STA	ANDARD RESPONSIBILITY NOTES:		
1.	I (WE) CERTIFY THAT: ALL DEVELOPMENT AND CONSTRUCTION WILL BE DONE IN ACCORDANCE WITH THIS SEDIMENT AND EROSION		
a.	CONTROL PLAN, AND FURTHER, AUTHORIZE THE RIGHT OF ENTRY FOR PERIODIC ON-SITE EVALUATION BY THE ANNE ARUNDEL SOIL CONSERVATION DISTRICT (AASCD) BOARD OF SUPERVISORS OR THEIR AUTHORIZED AGEN	ATS	Α
b.	ANY RESPONSIBLE PERSONNEL INVOLVED IN THE CONSTRUCTION PROJECT WILL HAVE A CERTIFICATE OF		
	ATTENDANCE FROM THE MARYLAND DEPARTMENT OF THE ENVIRONMENT'S APPROVED TRAINING PROGRAM FOR THE CONTROL OF SEDIMENT AND EROSION BEFORE BEGINNING THE PROJECT. RESPONSIBLE PERSONNEL ON SITE:		
с.	IF APPLICABLE, THE APPROPRIATE ENCLOSURE WILL BE CONSTRUCTED AND MAINTAINED ON SEDIMENT BASIN(S) INCLUDED IN THIS PLAN. SUCH STRUCTURE(S) WILL BE IN COMPLIANCE WITH THE ANNE ARUNDEL COUNTY CODE.		
2.	THE DEVELOPER IS RESPONSIBLE FOR THE ACQUISITION OF ALL EASEMENTS, RIGHT, AND/OR RIGHTS-OF-WAY BE REQUIRED FOR THE SEDIMENT AND EROSION CONTROL PRACTICES, STORM WATER MANAGEMENT PRACTIC DISCHARGE OF STORM WATER ONTO OR ACROSS ADJACENT OR DOWNSTREAM PROPERTIES INCLUDED IN THE	ES ANI	
3.	FOR INITIAL SOIL DISTURBANCE OR RE-DISTURBANCE, PERMANENT AND/OR TEMPORARY STABILIZATION PER TH AASCD VEGETATIVE ESTABLISHMENT SHALL BE COMPLETED WITHIN THREE CALENDAR DAYS FOR THE SURFAC CONTROLS, DIKES, SWALES, DITCHES, PERIMETER SLOPES AND ALL SLOPES GREATER THAN 3 HORIZONTAL TO (3:1) AND SEVEN DAYS FOR ALL OTHER DISTURBED OR GRADED AREAS ON THE PROJECT SITE.	E OF A	
4.	THE GRADING AND SEDIMENT CONTROL APPROVAL ON THIS PLAN EXTENDS ONLY TO THOSE AREAS WITHIN THI OF DISTURBANCE. THE APPROVAL OF THIS PLAN FOR SEDIMENT AND EROSION CONTROL DOES NOT RELIEVE THE DEVELOPER/CO		
5. 6.	THE APPROVAL OF THIS PLAN FOR SEDIMENT AND EROSION CONTROL DOES NOT RELIEVE THE DEVELOPER/CO FROM COMPLYING WITH FEDERAL, STATE OR COUNTY REQUIREMENTS PERTAINING TO ENVIRONMENTAL ISSUE THE DEVELOPER MUST REQUEST THAT THE SEDIMENT AND EROSION CONTROL INSPECTOR APPROVE WORK CO IN ACCORDANCE WITH THE APPROVED EROSION AND SEDIMENT CONTROL PLAN, THE GRADING OR BUILDING PE AND THE ORDINANCE.	S. OMPLE	TED
7. o	ALL MATERIAL SHALL BE TAKEN TO A SITE WITH AN APPROVED SEDIMENT AND EROSION CONTROL PLAN.		
8.	FIRST PHASE INSPECTION AND APPROVAL OF THE SEDIMENT AND EROSION CONTROL INSPECTOR SHALL BE RE UPON COMPLETION OF THE INSTALLATION OF EROSION AND SEDIMENT CONTROLS PRIOR TO PROCEEDING WIT OTHER EARTH DISTURBANCE OR GRADING. OTHER BUILDING OR GRADING INSPECTION APPROVALS MAY NOT B AUTHORIZED UNTIL THE INITIAL APPROVAL BY THE SEDIMENT AND EROSION CONTROL INSPECTOR IS GIVEN. IN: AND PERMITS MAY ALSO REQUIRE THAT AN INSPECTION AND CERTIFICATION OF THE INSTALLATION OF SEDIME CONTROL ALSO BE PERFORMED BY A DESIGN PROFESSIONAL PRIOR TO CONSTRUCTION COMMENCING.	H ANY E SPECT	
9.	APPROVAL FROM THE INSPECTOR MUST BE REQUESTED ON FINAL STABILIZATION OF ALL SITES PRIOR TO REMO SEDIMENT AND EROSION CONTROLS.	OVAL C	DF
10.	EXISTING TOPOGRAPHY MUST BE FIELD VERIFIED BY RESPONSIBLE PERSONNEL TO THE SATISFACTION OF THE CONTROL INSPECTOR PRIOR TO COMMENCING WORK.	SEDIM	IENT
	TURE OF DEVELOPER/OWNER DATE		
T I TLE: ADDR			
ADDR	2662 RIVA ROAD		
TEI EF	ANNAPOLIS, MARYLAND 21401 PHONE NUMBER: (410) 222 - 7500		
EMAIL	ADDRESS: pwbrau78@aacounty.org		
THE D	SULTANT'S CERTIFICATION EVELOPER'S PLAN TO CONTROL SILT AND EROSION IS ADEQUATE TO CONTAIN THE SILT AND EROSION		
CONT	IE PROPERTY COVERED BY THE PLAN. I CERTIFY THAT THIS PLAN OF EROSION AND SEDIMENT ROL REPRESENTS A PRACTICAL AND WORKABLE PLAN BASED ON MY PERSONAL KNOWLEDGE OF THIS AND WAS PREPARED IN ACCORDANCE WITH THE REQUIREMENTS OF THE AASCD PLAN SUBMITTAL		
GUIDE SEDIM	ELINES AND THE CURRENT MARYLAND STANDARDS AND SPECIFICATIONS FOR SOIL EROSION AND IENT CONTROL. I HAVE REVIEWED THIS EROSION AND SEDIMENT CONTROL PLAN WITH THE IR/DEVELOPER.		
MD P.I	E. LICENSE #27734		
MD LA	ND SURVEYOR LICENSE #		
	NDSCAPE ARCHITECT # JESSE M. LINDSAY, P.E.		
NAME FIRM I			
ADDR			
CITY_	TOWSON STATE MD ZIP CODE 21286		
	THE CONSULTANT'S CERTIFICATION MUST BE SIGNED AND SEALED BY A PROFESSIONAL IEER IF THE SITE LIES WITHIN THE SEVERN RIVER WATERSHED.		
GEN	ERAL CONSTRUCTION NOTES:	16.	ALL STONE USED FOR THE PROTECTION
1.	THIS PLAT IS BASED UPON A FIELD-RUN TOPOGRAPHIC SURVEY PERFORMED BY WBCM IN MARCH, 2019 AND REFLECTS SITE CONDITIONS AS OF THAT DATE.		FREE FROM EITHER LAMINATIONS, WEA DISINTEGRATE FROM THE ACTION OF AI INDIVIDUAL STONES WILL BE FREE FROM TIMES THE LEAST DIMENSION.
2. 3.	COORDINATES AND DIRECTIONS SHOWN HEREON ARE REFERRED TO THE MARYLAND STATE PLANE COORDINATE SYSTEM, NAD 83/2011 AS DETERMINED FROM REAL TIME KINEMATIC SURVEYING AS BROADCAST BY THE LEICA SMARTNET NETWORK. ELEVATIONS SHOWN HEREON ARE REFERRED TO THE NORTH AMERICAN VERTICAL DATUM OF 1988 (NAVD 88), AS DETERMINED BY	17.	ANY EXCAVATION THAT MEETS SAND FI OF AT AN APPROVED LOCATION.
1.	R T K, G P S, ORSERVATIONS AS BROADCASTED BY THE LEICA SMARTNET NETWORK(GEOID12A)	19.	THE WORK INSTALLED AS A PART OF TH WORKMANSHIP.
5.	THE LOCATION OF EXISTING UNDERGROUND UTILITIES IS SHOWN IN AN APPROXIMATE WAY ONLY. THE DESCRIPTION OF THE UNDERGROUND UTILITIES AS SHOWN HEREON WERE BASED SOLEY UPON FIELD OBSERVATIONS AND HAVE NOT BEEN COMPARED TO	20.	THE CONTRACTOR SHALL CORRECT, RE WORK FOUND NOT TO BE AS PER THE G
	OR VERIFIED WITH RECORD UTILITY DRAWINGS OR FIELD TEST PITS. THE SIZE, TYPE AND LOCATION OF THE UTILITY LINES SHOULD BE VERIFIED BY THE USER OF THIS DRAWING.	21.	WORK OR MATERIALS IN THE PROCESS
6.	IT IS THE CONTRACTOR'S RESPONSIBILITY TO FIELD VERIFY ACTUAL SITE CONDITIONS PRIOR TO THE START OF ANY WORK. THERE IS NO WARRANTY OR GUARANTEE ON THE COMPLETENESS OR CORRECTNESS OF THE EXISTING CONDITION INFORMATION. ANY DISCREPANCY FOUND SHALL BE BROUGHT TO THE IMMEDIATE ATTENTION OF THE ARCHITECT/ENGINEER PRIOR TO THE START OF ANY WORK.	22. 23.	ALL DISTURBED AREAS SHALL HAVE PER THREE CALENDAR DAYS ON SLOPES GR SEVEN CALENDAR DAYS AS TO ALL OTH ALL TREES WITH A DIAMETER GREATER
7.	THE WORDS "CERTIFY" OR "CERTIFICATION" AS USED HEREON ARE UNDERSTOOD TO BE AN EXPRESSION OF PROFESSIONAL OPINION BY THE UNDERSIGNED SURVEYOR, BASED UPON HIS BEST KNOWLEDGE, INFORMATION, AND BELIEF. AS SUCH, IT DOES NOT CONSTITUTE A GUARANTEE NOR A WARRANTY, EXPRESSED OR IMPLIED.		APPROVAL IS OBTAINED OR EXPLICITLY THAT ARE NOT TO BE REMOVED SHALL ALL DISTURBED AREAS WITH SLOPES G
8.	ALL CONSTRUCTION SHALL BE IN ACCORDANCE WITH ANNE ARUNDEL COUNTY STANDARD SPECIFICATIONS AND/OR DETAILS FOR CONSTRUCTION AND THE STATE HIGHWAY ADMINISTRATION'S HIGHWAY DRAINAGE MANUAL STANDARD SPECIFICATIONS AND DETAILS FOR CONSTRUCTION UNLESS OTHERWISE NOTED.	25.	HAS A SUFFICIENT DESIGN SHEAR STRE CONTROL PLANS. ALL ROADS SHALL BE CLEANED AND CL
9.	THE EXISTING UTILITIES AND OBSTRUCTIONS SHOWN ARE FROM THE BEST AVAILABLE RECORDS AND SHALL BE VERIFIED BY THE CONTRACTOR TO HIS SATISFACTION PRIOR TO CONSTRUCTION. NECESSARY PRECAUTIONS SHALL BE TAKEN BY THE CONTRACTOR TO PROTECT EXISTING SERVICES AND MAINS AND ANY DAMAGE TO THEM SHALL BE REPAIRED IMMEDIATELY AT HIS OWN EXPENSE.	26.	SHALL BE SWEPT BEFORE THE END OF ALL STAKING, RE-STAKING, AND CUT SH ENGINEER AT THE CONTRACTOR' S EXF
10.	THE CONTRACTOR SHALL CONTACT "MISS UTILITY" AT 1-800-257-7777 A MINIMUM OF 48 HOURS IN ADVANCE OF ANY EXCAVATION, BORING. PILE DRIVING AND/OR DIGGING FOR THE LOCATION OF GAS, ELECTRIC, TELEPHONE, WATER AND SEWER LINES.	27.	ALL CONSTRUCTION TO BE PERFORMED
11.	MECHANICAL EXCAVATION SHALL NOT BE CONDUCTED WITHIN 3 FEET HORIZONTALLY OR WITHIN 2 FEET VERTICALLY OF KNOWN UTILITY LOCATIONS. HAND OR SOFT DIGGING SHALL BE DONE WITHIN THESE LIMITS. UNDERGROUND UTILITIES, ONCE UNCOVERED, SHALL BE PROTECTED FROM BEING STRUCK BY EQUIPMENT.	28. 29.	CONTRACTOR MUST ENSURE THAT COP OF ANY WORK. CONTRACTOR SHALL RESTORE ALL ARE
12.	IT SHALL BE DISTINCTLY UNDERSTOOD THAT FAILURE TO MENTION SPECIFICALLY ANY WORK WHICH WOULD NATURALLY BE REQUIRED TO COMPLETE THE PROJECT SHALL NOT RELIEVE THE CONTRACTOR OF HIS RESPONSIBILITY TO COMPLETE SUCH WORK.	30.	AREAS, ROADS, AND PAVED AREAS, ETC STORMWATER MANAGEMENT HAS BEEN SQUARE FOOT OF DISTURBANCE.
13. 14.	ALL EXCESS SOIL SHALL BE REMOVED FROM THE SITE AND DISPOSED OF AT AN APPROVED DISPOSAL LOCATION. DISTURBANCES THAT DO NOT DRAIN TO A SEDIMENT CONTROL DEVICE SHALL BE STABILIZED BY THE END OF THE WORKDAY. NO		
	MORE AREA SHALL BE DISTURBED THAN CAN BE STABILIZED BY THE END OF THE WORKDAY. NO DISTURBED AREA SHALL BE LEFT UNSTABILIZED OVERNIGHT UNLESS THE RUNOFF IS DIRECTED TO AN APPROVED SEDIMENT CONTROL DEVICE. SLOPES SHALL BE STABILIZED IMMEDIATELY WITH TOPSOIL, SEED AND EROSION CONTROL MATTING (IF REQUIRED). SEE NOTE 17.		
15.	ALL FILL AREAS SHALL BE CLEANED OF ALL VEGETATION AND DEBRIS PRIOR TO THE PLACEMENT OF FILL. FILL MATERIAL SHALL BE PLACED IN CONTROLLED LIFTS WITH A MAXIMUM THICKNESS OF 8" PRIOR TO COMPACTION THAT IS CONTINUOUS OVER THE ENTIRE AREA OF FILL EACH LAYER OF FILL SHALL BE COMPACTED WITH THE MINIMUM NUMBER OF PASSES NECESSARY TO PRODUCE A FULL ASYMPTOTIC COMPACTION.		TR
)	300
	1"=150'-0"		

I THIN, SLABBY PIECES HAVING A MAXIMUM DIMENSION OF MORE THAN THREE AND ONE-HALF REQUIREMENTS MAY BE REUSED. OTHERWISE, UNSUITABLE MATERIAL IS TO BE DISPOSED

E PROJECT WILL CONTAIN NO FAULTY MATERIALS, OR ANY CARELESS, OR UNSKILLED

EPAIR, OR REMOVE AND REPLACE WITH PROPER WORK AT NO COST TO THE COUNTY, OR ANY BUARANTEE. THE CONTRACTOR SHALL ALSO MAKE GOOD ALL DAMAGES CAUSED TO OTHER OF FULFILLING THE GUARANTEE.

AREAS AS DELINEATED ON PLANS.

RMANENT OR TEMPORARY STABILIZATION COMPLETED WITHIN: REATER THAN 3:1 AND TO THE SURFACE OF ALL PERIMETER SEDIMENT CONTROLS. IER DISTURBED OR GRADED AREAS.

THAN 12 INCHES WITHIN THE LIMIT OF DISTURBANCE SHALL NOT BE REMOVED UNLESS PRIOR SHOWN ON THE PLANS TO BE REMOVED. ALL TREES WITHIN THE LIMIT OF DISTURBANCE, BE PROTECTED WITH TREE PROTECTION FENCING OR TREE REINFORCED PLANKING.

REATER THAN 3:1 SHALL BE STABILIZED WITH TEMPORARY SOIL STABILIZATION MATING THAT ESS FOR THE APPLICATION OR AS SHOWN ON THE APPROVED SEDIMENT AND EROSION

EACH WORK DAY.

D IN ACCORDANCE WITH STATE OF MARYLAND OCCUPATIONAL SAFETY LAWS.

PIES OF FEDERAL, STATE, AND COUNTY PERMITS ARE POSTED ON SITE PRIOR TO THE START

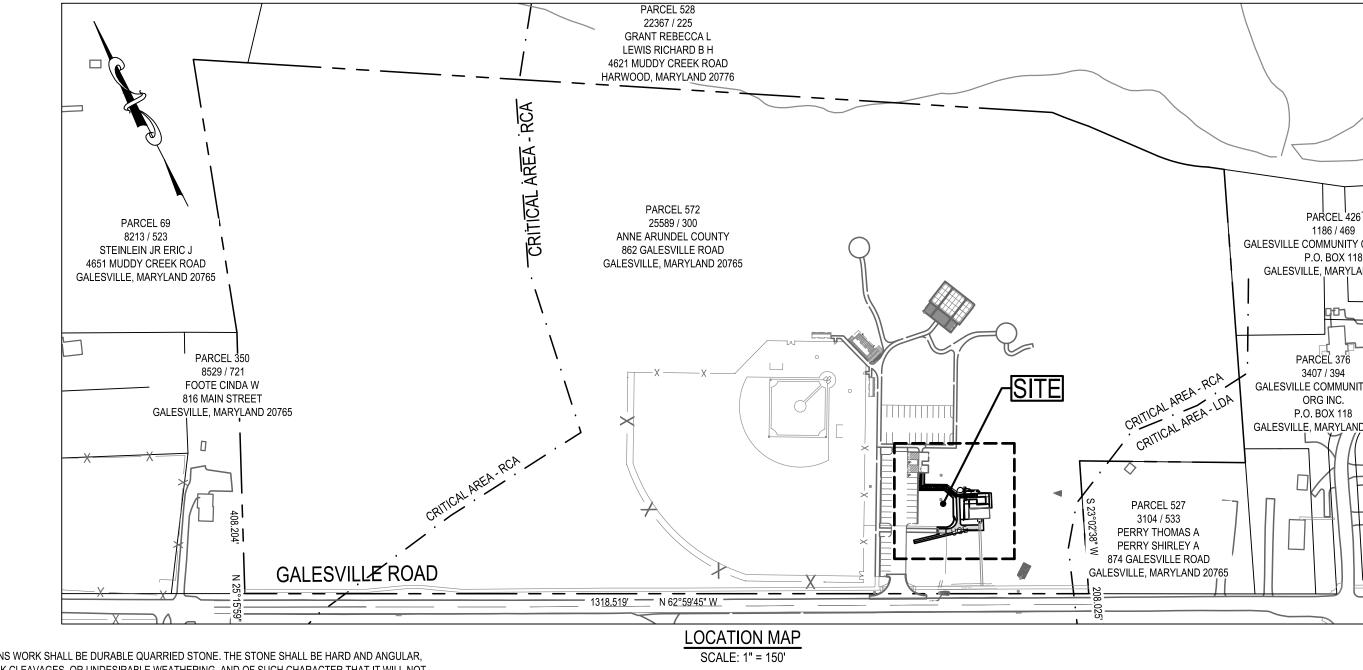
EAS IMPACTED BY CONSTRUCTION ACTIVITY. THIS SHALL INCLUDE BUT NOT LIMITED TO GRASS

APPROVED FOR THIS SITE BY STORMWATER MANAGEMENT EXEMPTION. SITE IS UNDER 5,000

300 E 410.512.45

NNE ARUNDEL COUNTY MARY DEPARTMENT OF PUBLIC WOR WILSON HOUSE RESTORATIO HOT SOX FIELD AT WILSON PARE

100% SUBMISSION - JULY 26, 2024 862 GALESVILLE ROAD, GALESVILLE, MARYLAND 20765 PROJECT NO. P573200, CONTRACT NO. P573201



CLEAVAGES, OR UNDESIRABLE WEATHERING, AND OF SUCH CHARACTER THAT IT WILL NOT R, SALT, WATER, OR HANDLING. SEDIMENTARY STONE WILL GENERALLY BE UNACCEPTABLE.

EARED BY THE END OF EACH WORK DAY. ANY MUD OR ROCKS TRACKED ON THE ROADWAYS

IEETS SHALL BE PERFORMED BY A REGISTERED LAND SURVEYOR OR PROFESSIONAL

SEQUENCE OF CONSTRUCTION:

- **INITIAL PHASE** PRE-CONSTRUCTION MEETING: NOTIFY THE DEPARTMENT OF INSPECTIONS AND PERMITS. (410-222-7780), RECREATION AND PARKS CONTACT ERICA JACKSON (410-222-2866) AT LEAST 48 HOURS BEFORE COMMENCING WORK. WORK MAY NOT COMMENCE UNTIL THE PERMITTEE OR THE RESPONSIBLE PERSONNEL HAVE MET ON SITE WITH THE SEDIMENT AND EROSION CONTROL INSPECTOR TO REVIEW THE APPROVED PLANS.
- CONTRACTOR SHALL LOCATE AND PROCURE ALL STAGING AND STOCKPILING AREAS WHICH SHALL BE APPROVED BY THE PROJECT INSPECTOR.
- 3. PRESENT FINALIZED SCHEDULE OF WORK AND MAINTENANCE OF TRAFFIC OPERATIONS TO THE ENGINEER AND ANNE ARUNDEL COUNTY INSPECTIONS AND PERMITS DIVISION.
- 4. CLEAR AND GRUB THOSE AREAS FOR INSTALLATION OF SEDIMENT AND EROSION PERIMETER CONTROLS, INCLUDING STABILIZED CONSTRUCTION ENTRANCE, REINFORCED SILT FENCE AND INLET PROTECTION.
- INSTALL REMAINING SEDIMENT CONTROL DEVICES AS REQUIRED PER THE PLANS. BUILD STAGING AND STOCKPILE AREAS. OBTAIN APPROVAL FROM THE COUNTY SEDIMENT AND EROSION CONTROL INSPECTOR.

6. PERFORM THE FOLLOWING SEQUENCE FOR EACH DAY OF UTILITY CONSTRUCTION OPERATIONS: CONTRACTOR TO ONLY DISTURB THE AREA THAT WILL BE STABILIZED THE SAME DAY.

- INSTALL REINFORCED SILT FENCE DOWNGRADE OF AREA TO BE WORKED ON A DAILY BASIS. CLEAR AND GRUB AREA WHERE UTILITIES WILL BE INSTALLED. REMOVE AND SALVAGE TOPSOIL
- EXCAVATE AND INSTALL UTILITIES AND APPURTENANCES. PLACE BACKFILL AND COMPACT. INSTALL TEMPORARY PAVING OR, PLACE TOPSOIL, FINE GRADE, SEED AND APPLY MULCH IN
- UNPAVED DISTURBED AREAS.
- STREETS ARE TO BE SWEPT FREE OF DIRT AND DEBRIS. DIRECT ALL WATER PUMPED DURING TRENCH DEWATERING OPERATIONS TO AN APPROVED

PORTABLE SEDIMENT TANK. CLEAN OUT TANK WHEN ONE-THIRD (1/3) FILLED WITH SILT. HAUL SEDIMENT TO AN APPROVED SITE.

7. FOR OPEN CUT PIPE INSTALLATION THE FOLLOW A. EXCAVATED TRENCH MATERIAL SHALL

- IMMEDIATELY FOLLOWING PIPE INSTAL AND STABILIZED AT THE END OF EACH
- TEMPORARY REINFORCED SILT FENCE AREA ON A DAILY BASIS.
- 8. NO EXCAVATED MATERIAL SHALL BE PLACED IN ROADWAY. THE CONTRACTOR SHALL TAKE PRE OF EXISTING VEGETATED AREAS TO THE EXTEN AREAS DISTURBED AS A RESULT OF THE CONTR STABILIZED BY THE END OF THE WORK DAY.

9. STABILIZE THE TOP OF ALL TRENCHES BY THE I STOCKPILED SOIL REMAINING AFTER REFILLING THE SURFACE AND HAULED FROM THE SITE BY CONTRACTOR SHALL BE RESPONSIBLE FOR OB STOCKPILE AREAS. THE CONTRACTOR SHALL A MUD OFF THE ROADWAYS BY THE END OF EACH

10. COMPLETE MASS GRADING AND BEGIN PARKING

11. ONCE UPSTREAM AREAS ARE 95% STABILIZED, (SEDIMENT IS TO BE PREVENTED FROM ENTER PIPES TO BE CONNECTED AFTER CONTRIBUTING CERTIFY SWM INSTALLATION. UPON COMPLETIC DURING A NOAA 3-DAY DRY FORECASTED PERIC

12. STABILIZE ANY REMAINING DISTURBED AREAS


13. REMOVE ANY REMAINING SEDIMENT CONTROLS INSPECTIONS AND PERMITS DIVISION. FINE GRA PERIMETER CONTROLS.

			REVISIONS			
East Joppa Road Suite 200		NO.	DESCRIPTION	BY	DATE	
Baltimore, MD 21286 500 www.transystems.com			100% SUBMISSION		08/01/24	APPROVED
IEMS						CHIEF ENGINEER
	I hereby certify that these documents were prepared or approved by me, and that I am a duly licensed professional engineer under the					
	laws of the State of Maryland. License # <u>27734</u> Expiration Date: <u>07/12/26</u>					ASSISTANT CHIEF ENGINE

LAND			SUTH AND SE
			ANNEORO LART AND
KS			HOUSE ROAD ONE STILLE POOL BAYFIELDS WEST
			BANARD ROLD EZZ ROLD Z ROLD Z ROLD ROLD Z ROLD
) N WB PT# 900	NORTHING EASTING	JERSE CONTROL LISTING G ELEV. DESCRIPTION 0.78 23.70 REBAR & CAP	And a contract of the contract
901 902 903	430,886.93 1,439,86 430,536.85 1,439,91 430,410.35 1,439,75	1.52 22.98 REBAR & CAP 5.81 19.92 REBAR & CAP 0.12 21.44 REBAR & CAP	2559 PORT ROAD CARD AND ROAD AND
904	430,619.18 1,439,42	6.85 26.19 REBAR & CAP	<u>VICINITY MAP</u> SCALE: 1" = 2,000'
	LEGEND		
	DESCRIPTION	EXISTING	NEW
—	BUILDING	EX. BLDG	
5	BITUMINOUS CONCRET	E PAVING EX. MACADAM	
	PORTLAND CEMENT CC	DNCRETE EX. CONC.	
	GRAVEL PAVING	GRAVEL	
	GRAVEL TRAIL / WALK	GRAVEL	
	WOODED/BUSH AREA		
	DECIDUOUS / EVERGRE	MAR Your Your	
	CLEAN OUT DRAIN INLET	© c.o.	
26	FIRE HYDRANT POWER POLE		
9 TY CTR ORG INC.	PROPERTY MON. SIGN (ONE-POST)	• 600	
118 LAND 20765	STORM DRAIN MH STREET LIGHT	D ¢	
	TRAVERSE STATION SPOT ELEVATION	<u></u> ▲900 × 25.5	+ 25.5
	MAJOR CONTOUR	25 26	25
	SURVEY LIMITS		26 26
3 ND 20765	CHAIN LINK FENCE SPLIT RAIL FENCE	— X — X — X — X	_
IND 20765	U/G ELECTRIC U/G STORM	E D	UGEUGE
	SOIL LINE SOIL BORING		DCA (C/D) DXB (C/D)
	PROPERTY LINE	\V_	
	CRITICAL AREA LINE LIMITS OF DISTURBANC	CE LOD	
	INDEX OF D	DRAWINGS	
	<u>SHEET NO. SHEE</u> <u>CIVIL</u>	<u>ET TITLE</u>	
WING PROCEDURES SHALL APPLY:		IG CONDITIONS AND DEMOLITION PLA	AN
. BE PLACED ON HIGH SIDE OF TRENCH. LLATION, THE TRENCH SHALL BE BACKFILLED COMPA	4. SITE DE		
WORKING DAY. SHALL BE PLACED DOWNSTREAM OF ANY DISTURBE		CAPE PLAN	
STALL BE FLACED DOWNSTILLAM OF ANT DISTORDE	ARCHIT	ECTURAL /IATIONS SYMBOLS AND NOTES	
N DITCHES ADJACENT TO THE EXISTING	8. CODE A	NERAL STANDARDS NALYSIS	
ECAUTIONS TO PREVENT THE DISTURBANCE NT POSSIBLE. ANY EXISTING VEGETATED	10. EXISTIN	ITION FLOOR PLANS	
RACTOR'S WORK OPERATIONS SHALL BE	12. NEW W0	ORK FLOOR PLANS ORK ELEVATIONS	
END OF EACH WORK DAY. ALL EXCESS	14. INTERIC	NS AND DETAILS DR ELEVATIONS DR ELEVATIONS	
G THE TRENCH(S) SHALL BE REMOVED FROM THE END OF THE WORKING DAY. THE		X DETAILS	
TAINING ALL PERMITS FOR HIS OFF-SITE	18. KITCHEI	N SKELETON DETAILS PLAN AND DETAILS	
LSO ADEQUATELY CLEAN ALL DIRT AND ⊣ WORKING DAY.	20. RAMP A	ND VIEWING PLATFORM DETAILS JLES AND DETAILS	
G LOT AND SIDEWALK PAVING.	22. WINDOV	N DETAILS	
INSTALL SWM SYSTEMS AND DEVICES AND/OR PLAN		AL NOTES	
ING SWM SYSTEMS AND DEVICES AND/OR PLAN ING SWM SYSTEMS DURING CONSTRUCTION; INFLOW G AREAS ARE ALSO STABILIZED). THE ENGINEER MUS	24. FOUNDA		
ON OF PAVING AND CURB AND GUTTER INSTALLATION OD, INSTALL EACH OF THE PROPOSED RAIN GARDENS	AND 26. PARTIAL S 27. REPAIR	L FRAMING PLANS SECTIONS AND DETAILS	
AS REQUIRED.	28. SECTIO	NS AND DETAILS L DETAILS	
S AFTER PRIOR APPROVAL FROM ANNE ARUNDEL CO ADE AND STABILIZE AREA FORMERLY OCCUPIED BY	JNTY		
NUL ANU STADILIZE AREA FURMERLY UUUUPIED BY			
	ANNE ARUN	DEL COUNTY	

Ν

DEPARTMENT OF PUBLIC WORKS DATE APPROVED DATE | SCALE: AS SHOWN WILSON HOUSE RESTORATION HOT SOX FIELD AT WILSON PARK DRAWN BY: R.S.S. CHECKED BY: PROJECT MANAGER J.M.L. DATE APPROVED DATE SHEET NO. 01 OF 29 COVER SHEET PROJECT NO.: P573200 CONTRACT NO.: P573201 CHIEF, RIGHT-OF-WAY

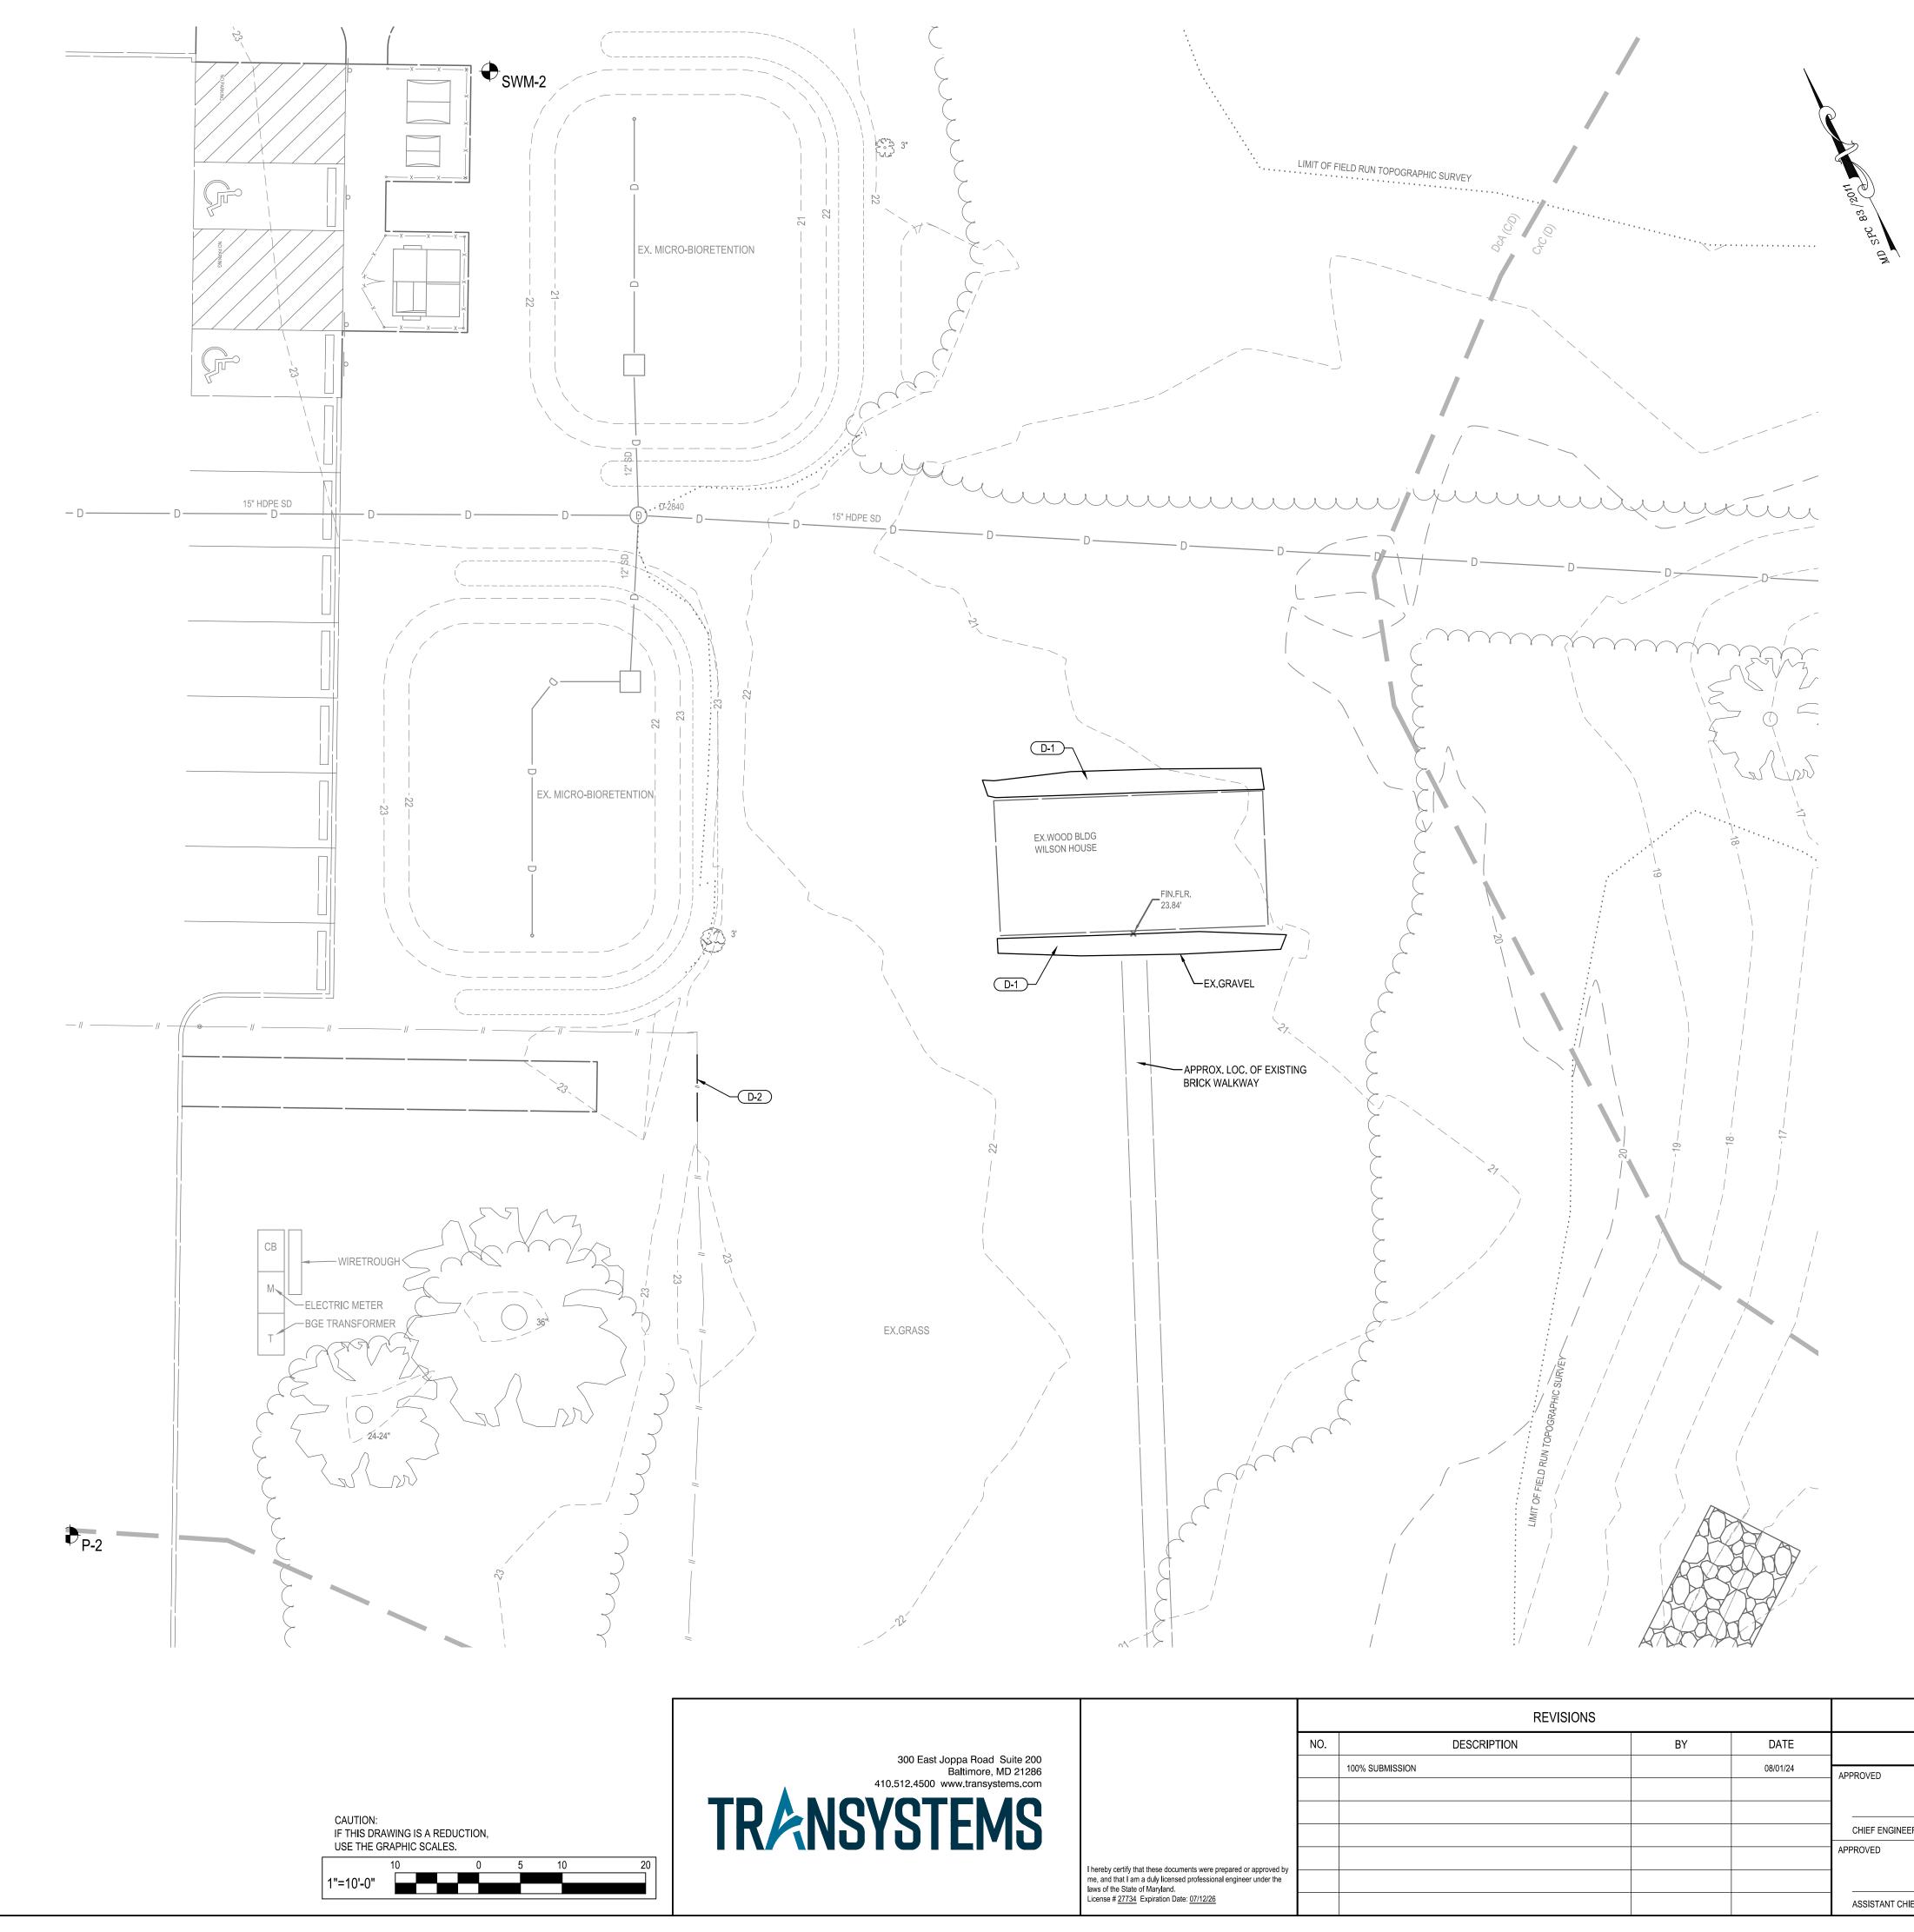


			REVISIONS				ANNE A	ARUNDEL COUNTY	
at Janna Dand, Suita 200		NO.	DESCRIPTION	BY	DATE	_	DEPARTMEN	NT OF PUBLIC WORKS	
ast Joppa Road Suite 200 Baltimore, MD 21286 00 www.transystems.com	_		100% SUBMISSION		08/01/24	APPROVED DATE	APPROVED	DATE SCALE: 1" = 10' WILSON HOUSE RESTORATION	1
-	-					_		DRAWN BY: R.S.S. HOT SOX FIELD AT WILSON PARK	
TEMS	_					 Chief Engineer	PROJECT MANAGER	CHECKED BY: J.M.L.	
						APPROVED DATE	APPROVED	DATE SHEET NO. 02 OF 29 EXISTING CONDITIONS AND	
	ese documents were prepared or approved by Ily licensed professional engineer under the aryland.					_		PROJECT NO.: P573200 DEMOLITION PLAN	
License # 27734 Expin						ASSISTANT CHIEF ENGINEER	CHIEF, RIGHT-OF-WAY	CONTRACT NO.: P573201	

DESCRIPTION	EXISTING	REMOVE
BUILDING	EX. BLDG	
BITUMINOUS CONCRETE PAVING	EX. MACADAM	
PORTLAND CEMENT CONCRETE	EX. CONC.	
GRAVEL PAVING	GRAVEL	
GRAVEL TRAIL / WALK	GRAVEL	
WOODED/BUSH AREA		
DECIDUOUS / EVERGREEN TREES	#M	
CLEAN OUT	∽۲۸۸۲ ۲۵۵۶ ۲۵۵ ⊚ ۵.۵.	
DRAIN INLET		
FIRE HYDRANT	\bowtie	
POWER POLE		
PROPERTY MON.	O 600	
SIGN (ONE-POST)		
STORM DRAIN MH	\bigcirc	
STREET LIGHT	ф.	
TRAVERSE STATION	<u> </u>	
SPOT ELEVATION	× 25.5	
MAJOR CONTOUR	25	
MINOR CONTOUR	26	
SURVEY LIMITS		
	- x x x	
SPLIT RAIL FENCE	// //	////////
U/G ELECTRIC	———— E ————	
U/G STORM	D	
SOIL LINE	DcA (C/D) CxB (C/D)	
SOIL BORING	в#	
PROPERTY LINE	'	
CRITICAL AREA LINE -	· · · ·	
LIMITS OF DISTURBANCE	LOD	

DEMOLITION

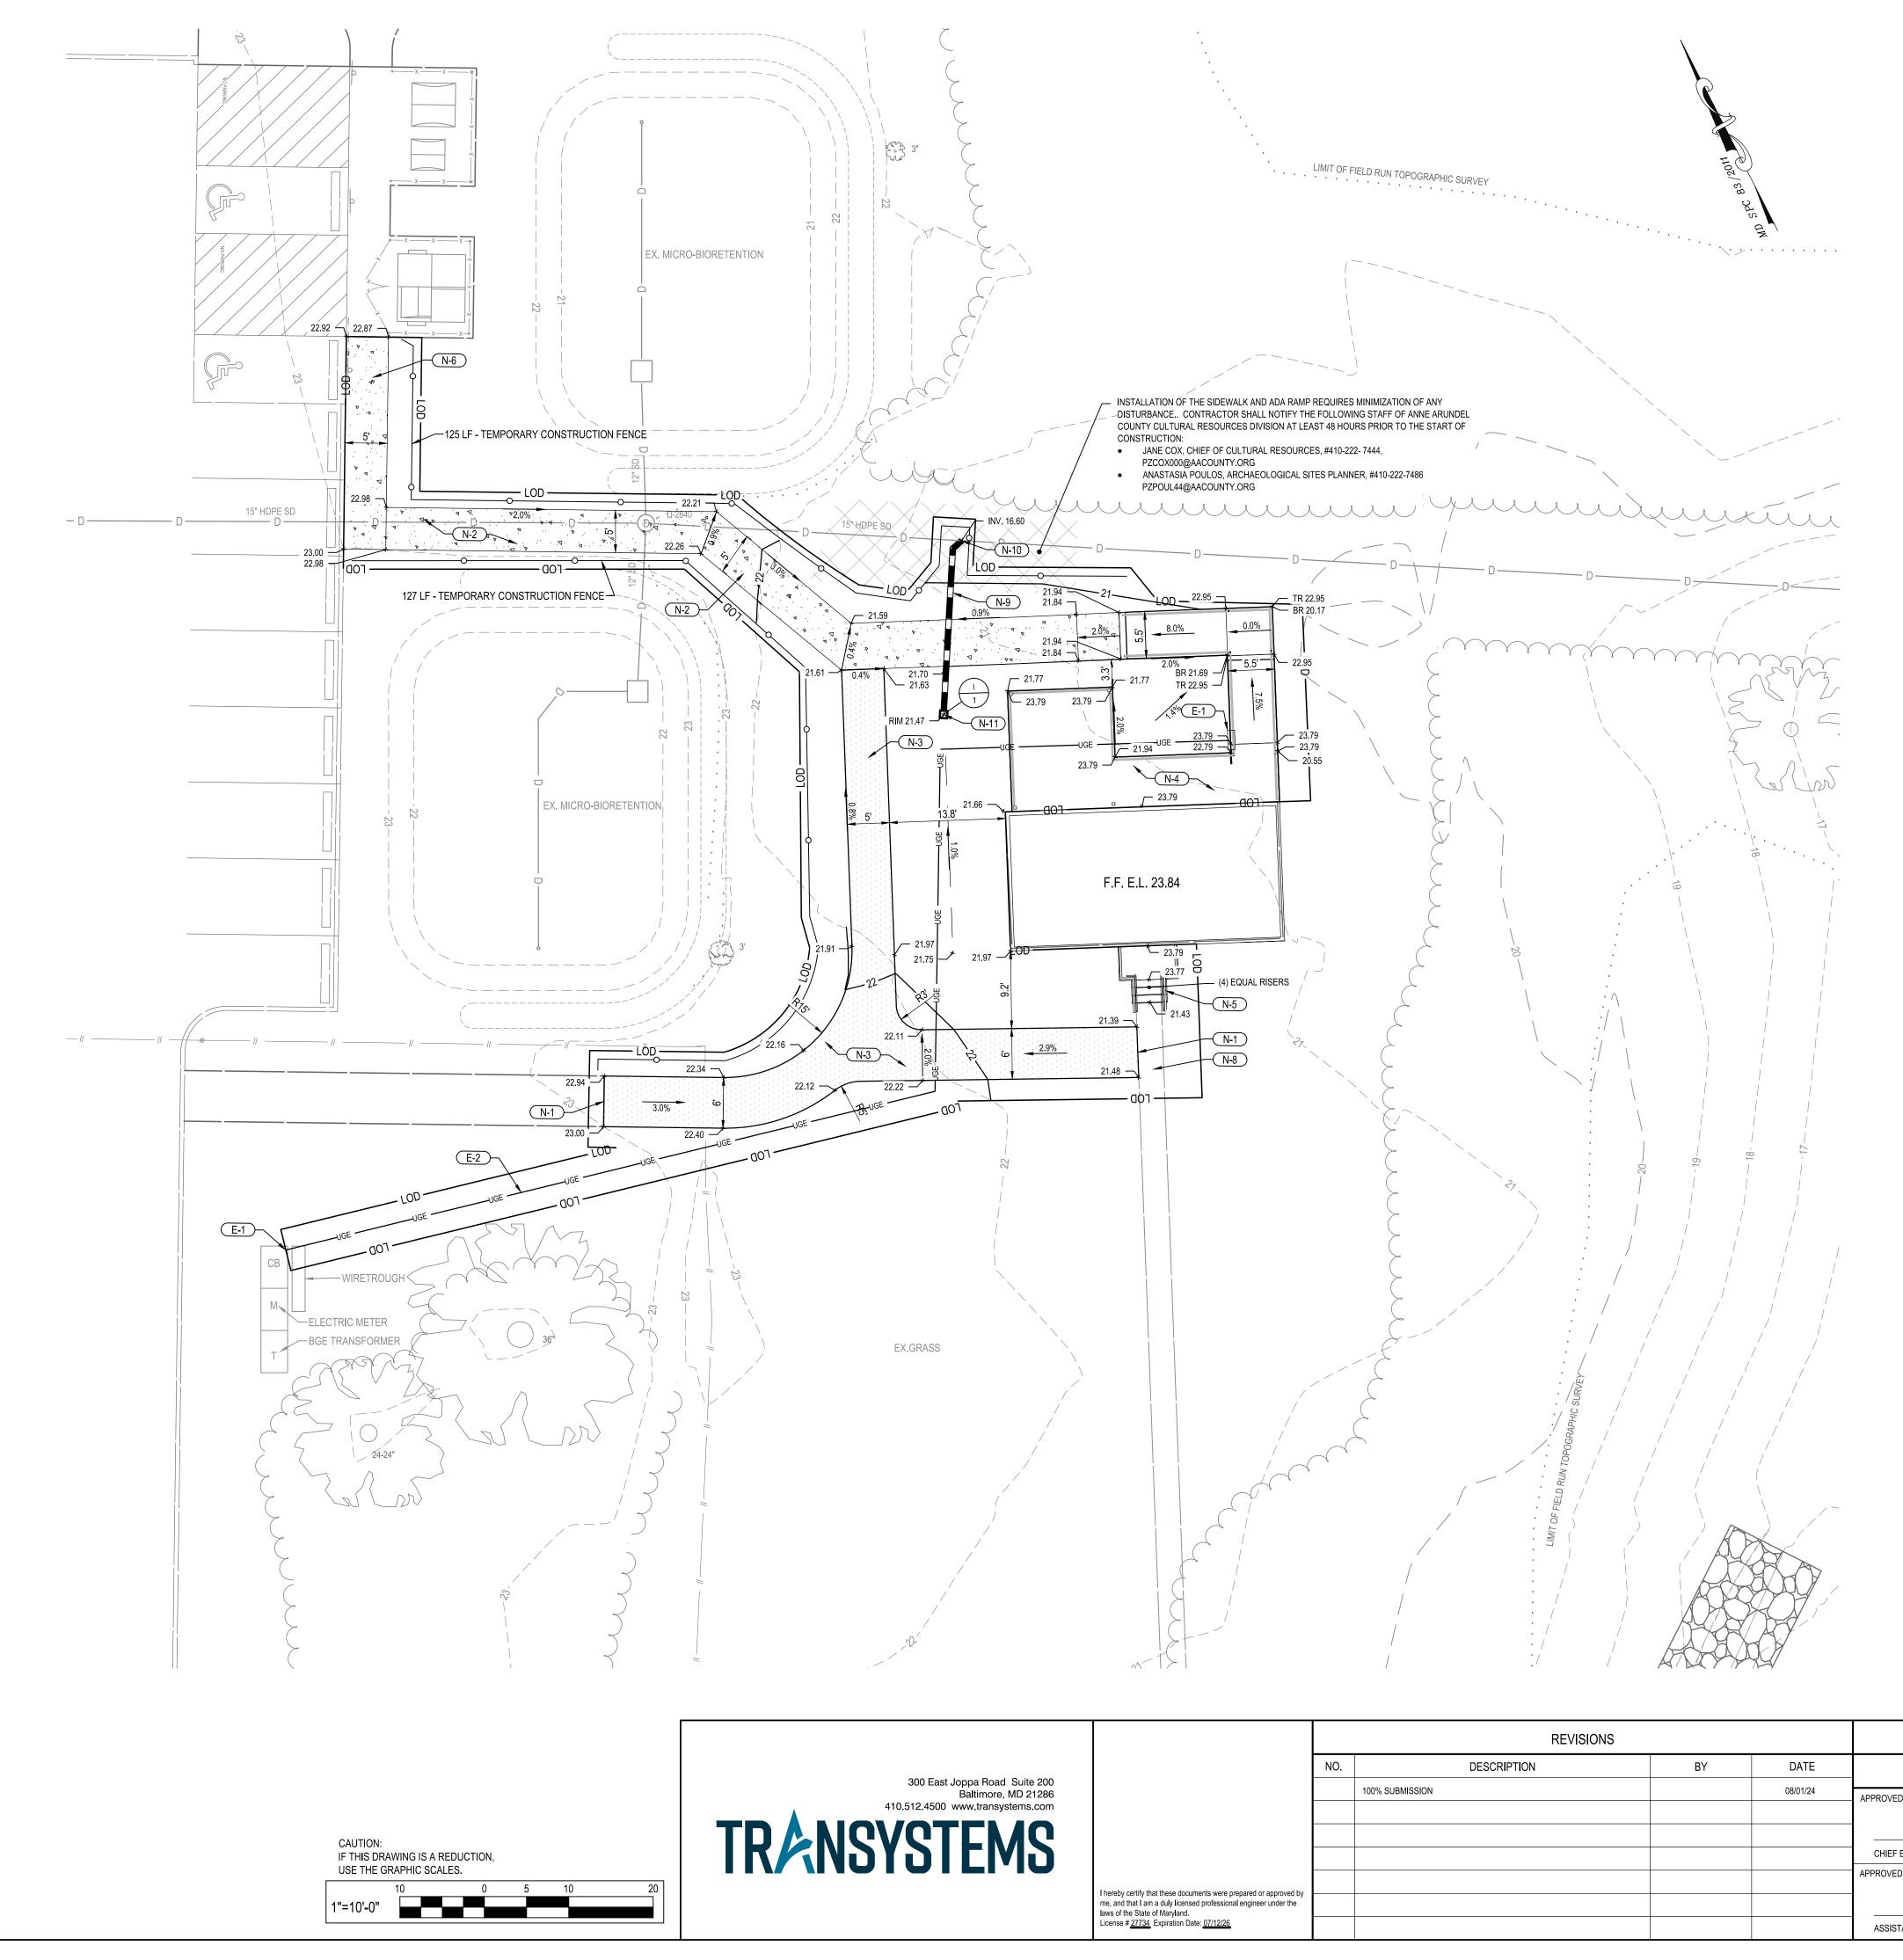D-1 REMOVE EXISTING GRAVEL. D-2 REMOVE EXISTING SPLIT RAIL FENCING.



			REVISIONS			
		NO.	DESCRIPTION	BY	DATE	
ast Joppa Road Suite 200 Baltimore, MD 21286			100% SUBMISSION		08/01/24	APPROVED
00 www.transystems.com						
TEMS						CHIEF ENGINEER
						APPROVED
	I hereby certify that these documents were prepared or approved by me, and that I am a duly licensed professional engineer under the					
	laws of the State of Maryland. License # <u>27734</u> Expiration Date: <u>07/12/26</u>					ASSISTANT CHIEF ENGINEER

DESCRIPTION	EXISTING	NEW
BUILDING	EX. BLDG	
BITUMINOUS CONCRETE PAVING	EX. MACADAM	
PORTLAND CEMENT CONCRETE	EX. CONC.	
GRAVEL PAVING	GRAVEL	
GRAVEL TRAIL / WALK	GRAVEL	
WOODED/BUSH AREA		
DECIDUOUS / EVERGREEN TREES	###12" \$ 6" { ~~~~~~~~~~~~~~~~~~~~~~~~~~~~~~~~~~	
CLEAN OUT	MAC 3.0.	
DRAIN INLET		
FIRE HYDRANT		
POWER POLE	\sim	
PROPERTY MON.	O 600	
SIGN (ONE-POST)		
STORM DRAIN MH	\square	
STREET LIGHT	¢.	
TRAVERSE STATION	<u> </u>	
SPOT ELEVATION	× 25.5	+ 25.5
MAJOR CONTOUR	<u> </u>	25
MINOR CONTOUR	26	26
SURVEY LIMITS		
CHAIN LINK FENCE	- X X X	
SPLIT RAIL FENCE	//	
U/G ELECTRIC	———— E ————	UGE UGE UGE UGE
U/G STORM	D	
SOIL LINE	DcA (C/D) CxB (C/D)	
SOIL BORING	₩	
PROPERTY LINE	'	
CRITICAL AREA LINE -	· · · ·	
LIMITS OF DISTURBANCE	LOD	
TEMPORARY CONSTRUCTION FEN	CE	oo

CONSTRUCTION NOTES

- N-1 MEET EXISTING CONDITIONS.
- N-2 NEW CONCRETE SIDEWALK, SEE DETAIL #1 ON SITE DETAILS.
- N-3 NEW GRAVEL (CRUSHED OYSTER SHELL) PEDESTRIAN TRAIL, SEE DETAIL #2 ON SITE DETAILS.
- N-4 NEW WOODEN DECK, REFER TO ARCHITECTURAL DRAWINGS.
- N-5 NEW WOODEN STAIRS, REFER TO ARCHITECTURAL DRAWINGS.
- N-6 TRANSPLANT EXISTING PLANT MATERIAL TO OTHER SIDE OF NEW SIDEWALK
- N-7 ADA RAMP (WOOD)
- N-8 EXISTING BRICK WALK
- N-9 8" PVC STORM DRAIN
- N-10 INSERTA WYE CONNECTION N-11 12"X12" NYLOPLAST INLET
- GENERAL ELECTRICAL NOTES
- 1. INSTALLATION SHALL COMPLY WITH NEC AND ALL LOCAL CODES HAVING

JURISDICTION. ELECTRICAL NOTES

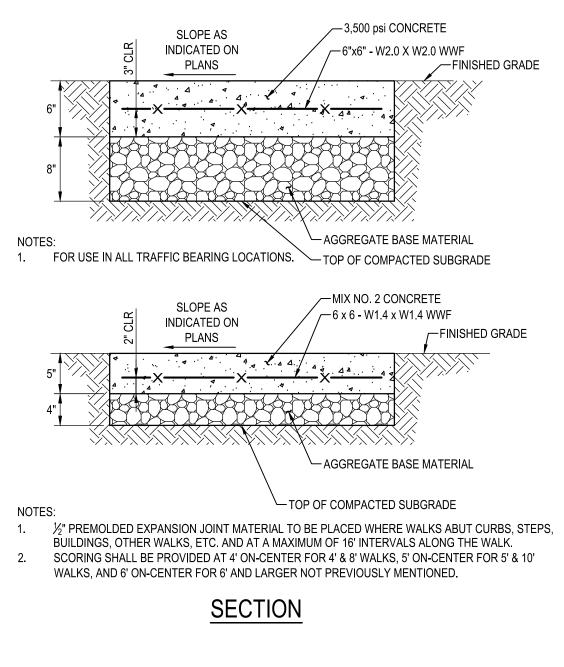
- E-1 FURNISH AND INSTALL 60/3 BREAKER IN EXISTING PANEL TO FEED NEW PANEL
- LOCATED AT NEW RAMP. TYPE AND AIC RATING TO MATCH EXISTING PANEL.
- E-2 FURNISH AND INSTALL 4#6, #10GRD 2"C, 30"BELOW GRADE TO FEED NEW PANEL AND CONNECT.
- E-3 FURNISH AND INSTALL LOCKABLE 120/208V 12 POLE 60A MAIN BREAKER AND BUSING IN NEMA 3R ENCLOSURE. PANEL SHALL HAVE 4 - 20/1 FEEDER BREAKERS FOR FUTURE USE. MOUNT PANEL TO STRUCTURAL SUPPORTS OF RAMP.

SEDIMENT AND EROSION CONTROL NOTES

- 1. THE CONSTRUCTION EQUIPMENT SHALL REMAIN WITHIN THE LOD UNTIL ALL PROPOSED WORK IS COMPLETED, THEN HAVE THE TIRES/TREADS THOROUGHLY CLEANED OF MUD, SEDIMENT, ETC. PRIOR TO LEAVING THE LOD. ALSO, ALL MATERIAL REMOVAL/EQUIPMENT SHALL BE LIFTED OUT FROM THE LOD.
- 2. NO DISTURBED AREA SHALL BE LEFT UNSTABILIZED AT THE END OF EACH DAY UNLESS RUNOFF IS DIRECTED TO A MDE APPROVED SEDIMENT CONTROL DEVICE
- 3. CONTRACTOR SHALL AVOID AND TAKE CARE NOT TO DISTURB EXISTING STORMWATER FACILITIES.

ANNE ARUNDEL COUNTY

DEPARTMENT OF PUBLIC WORKS DATE APPROVED DATE SCALE: 1" = 10' WILSON HOUSE RESTORATION HOT SOX FIELD AT WILSON PARK R.S.S. DRAWN BY: CHECKED BY: PROJECT MANAGER J.M.L. DATE APPROVED DATE SHEET NO. 03 OF 29 SITE LAYOUT PLAN AND PROJECT NO .: P573200 GRADING PLAN CONTRACT NO.: P573201 CHIEF, RIGHT-OF-WAY








\int_{16}^{3} x 5.5" ALUMINUM EDGING WHERE WALK ABUTS LAWN AREAS.
/FINISHED GRADE
/ /5" SURFACE AGGREGATE MATERIAL
/ (SEE SPECIFICATIONS)
A A A A A A A A A A A A A A A A A A A
TOP OF COMPACTED SUBGRADE
MIRAFI 1160N GEOTEXTIL FABRIC OR APPROVED EQUEAL

SECTION



			REVISIONS			
Fact James Baard, Ouite 000		NO.	DESCRIPTION	BY	DATE	
East Joppa Road Suite 200 Baltimore, MD 21286 500 www.transystems.com			100% SUBMISSION		08/01/24	APPROVED
TEMS						
ΙΕΝΟ						CHIEF ENGINEER APPROVED
	I hereby certify that these documents were prepared or approved by me, and that I am a duly licensed professional engineer under the laws of the State of Maryland.					
	License # <u>27734</u> Expiration Date: <u>07/12/26</u>					ASSISTANT CHIEF ENGINEE

DEPARTMENT OF PUBLIC WORKS							
DATE	APPROVED DATE	SCALE: AS SHOWN	WILSON HOUSE RESTORATION				
		DRAWN BY: R.S.S.	HOT SOX FIELD AT WILSON PARK				
	PROJECT MANAGER	CHECKED BY: J.M.L.					
DATE	APPROVED DATE	SHEET NO. 04 OF 29	SITE DETAILS				
		PROJECT NO.: P573200					
	CHIEF, RIGHT-OF-WAY	CONTRACT NO.: P573201					
			© TRANSYSTEMS				

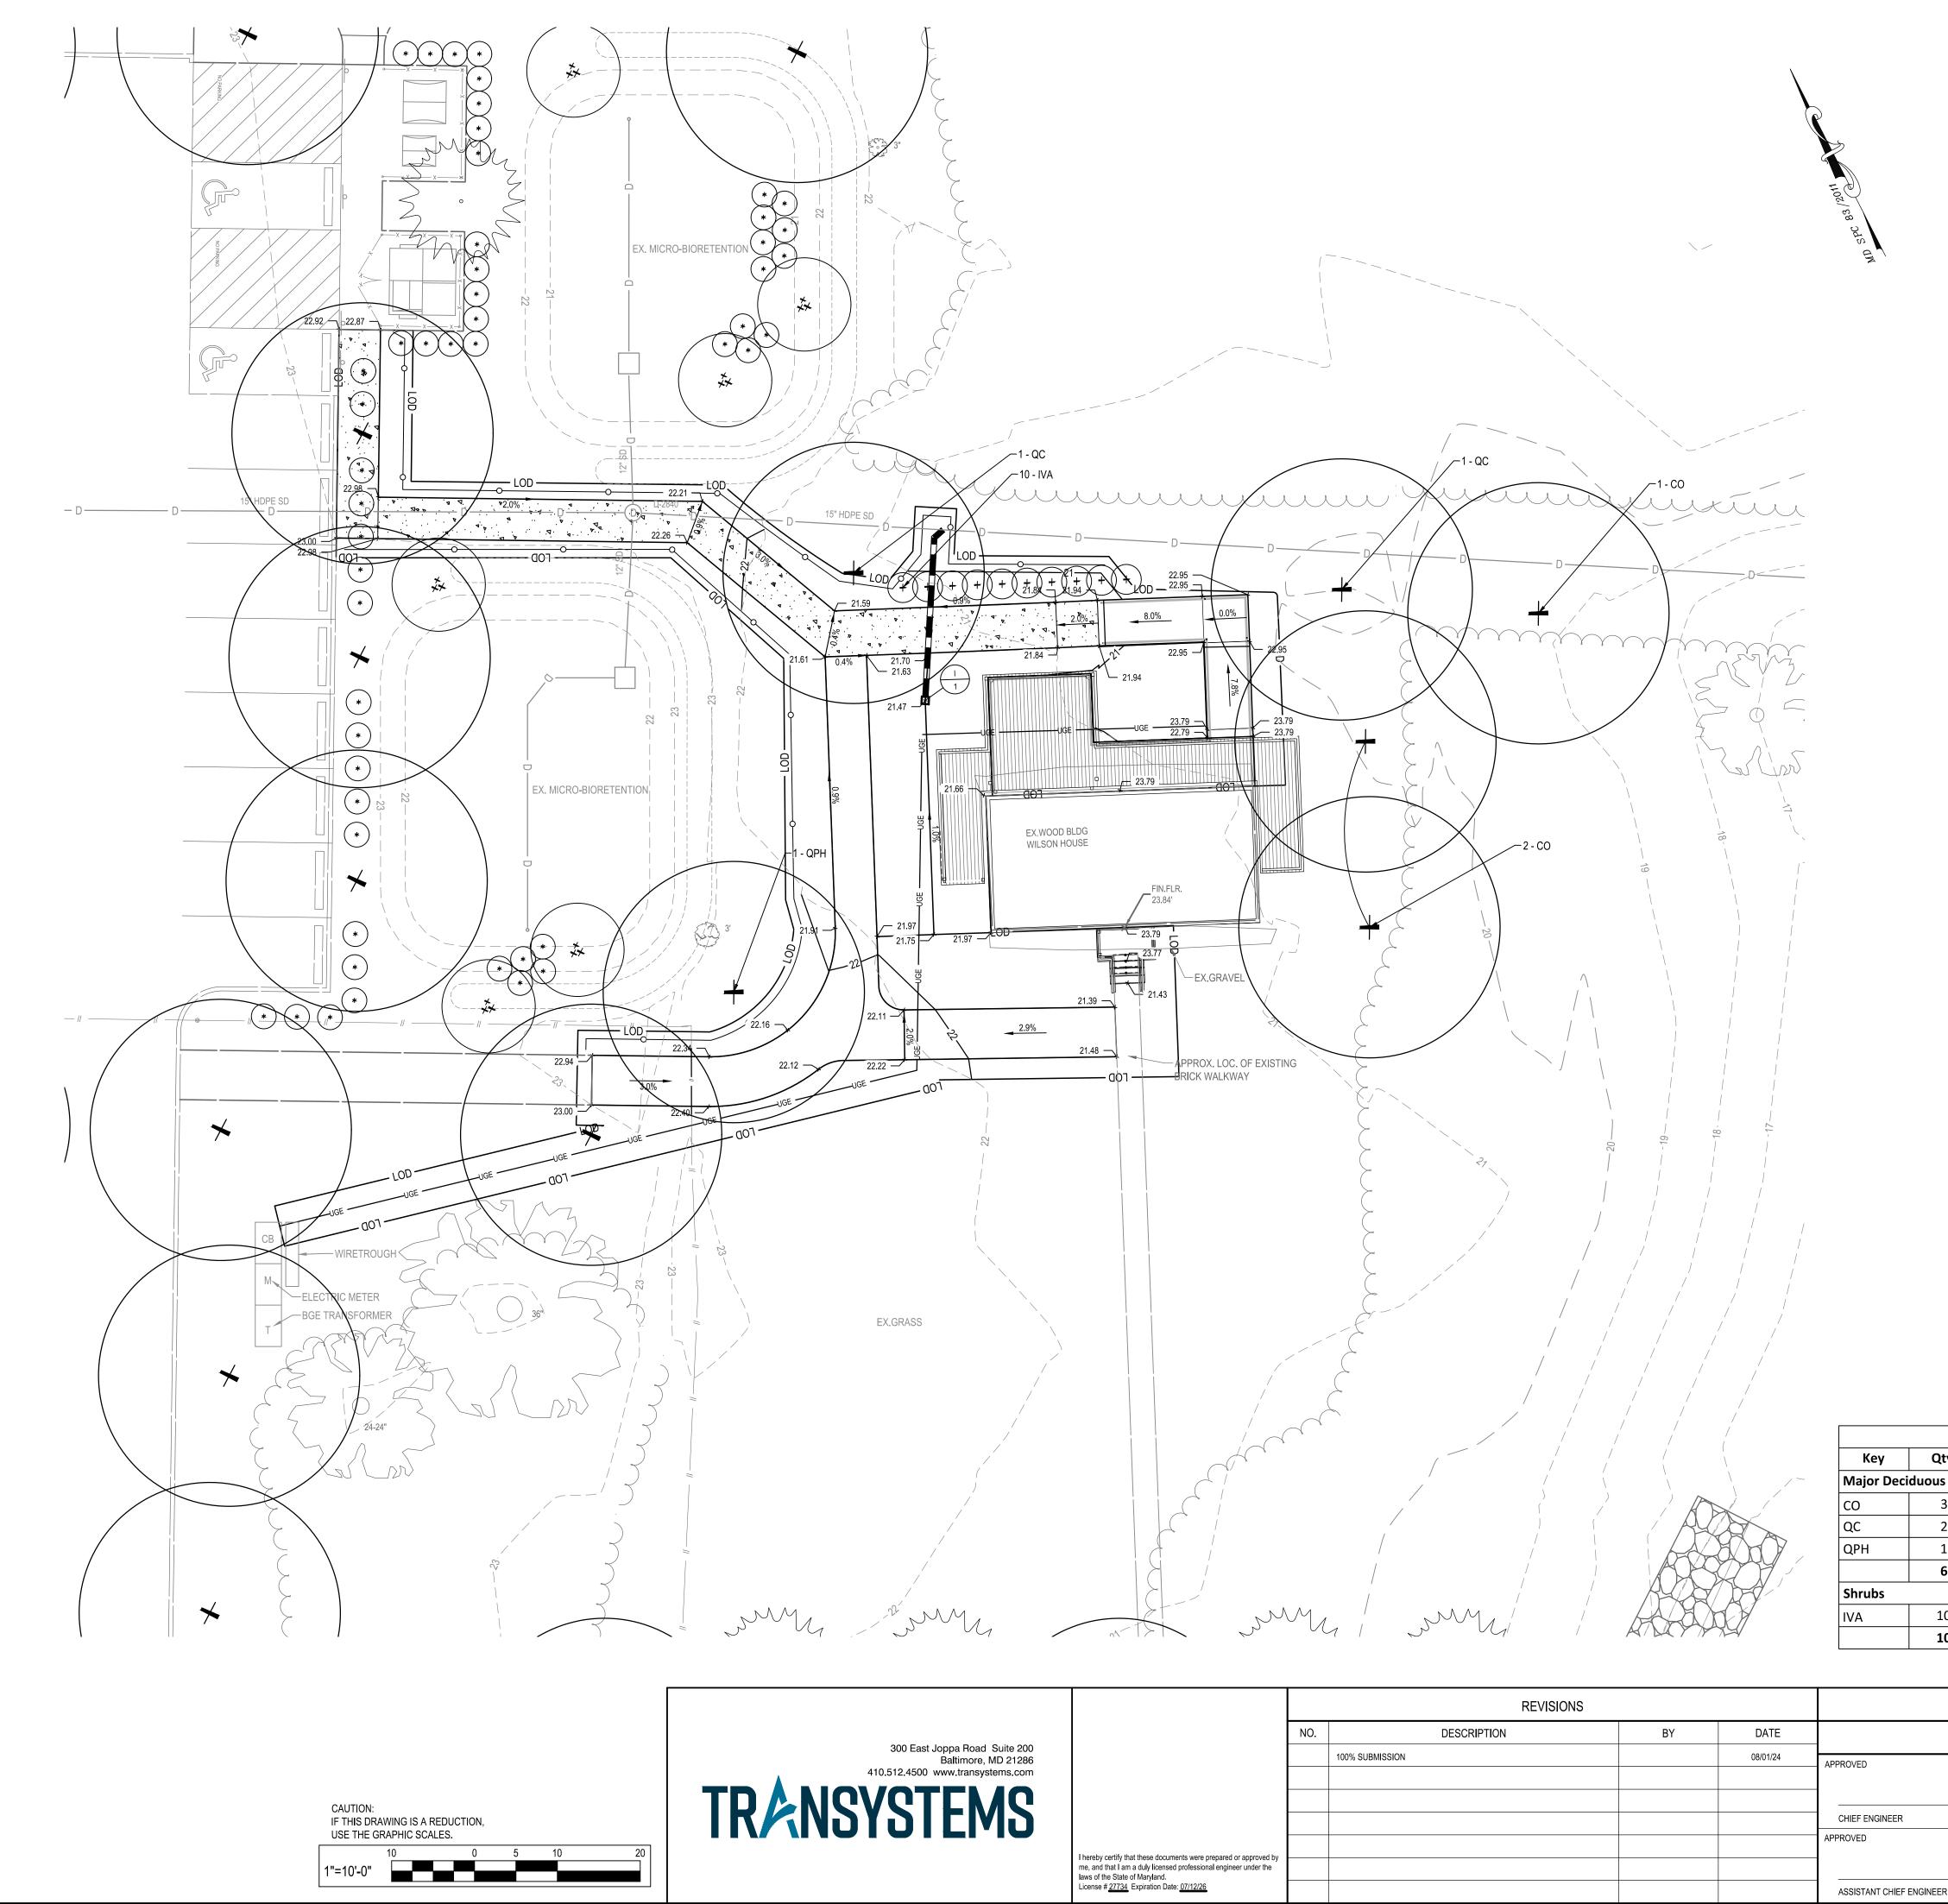


			REVISIONS			
		NO.	DESCRIPTION	BY	DATE	
ast Joppa Road Suite 200 Baltimore, MD 21286			100% SUBMISSION		08/01/24	APPROVED
00 www.transystems.com						
Ι ΕΙΥΙΟ						CHIEF ENGINEER
	I hereby certify that these documents were prepared or approved by me, and that I am a duly licensed professional engineer under the laws of the State of Maryland.					
	License # <u>27734</u> Expiration Date: <u>07/12/26</u>					ASSISTANT CHIEF ENGINEE

= 26.5 ACRES = 4,223 SQFT = 565 SQFT
= 2,249SQFT = 0.0 (0 SQFT)
 = 0.10 ACRES (4,223 SQFT) = 0 % (0 SQFT / 0 SQFT) = 53.3 % (2249 SQFT / 4,223 SQFT) = 0.55 ACRES (23,911 SQFT) = 17.12 ACRES (745,895 SQFT) = 0 % (0 SQFT / 23,911 SQFT) = 3.19 % (23,768 SQFT / 745,895 SQFT) = .55 ACRES (100% COVERAGE) = 11.9 ACRES (70% COVERAGE) = 0.0 ACRES / 0 SF = 0.0 ACRES / 0 SF

PROPOSED PLANTING MITIGATION WITHIN CRITICAL AREA = 1,700 SF

CANOPY TREE LARGE SHRUB = 6 TREES X 200 SF = 1200 SF = 10 SHRUBS X 50 SF = 500 SF

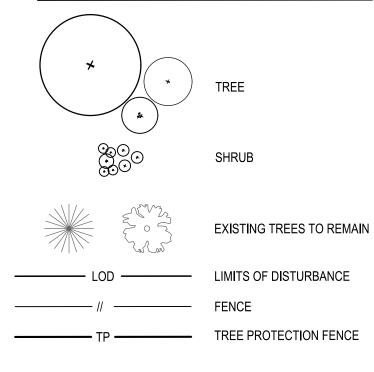PLANTING LEGEND



	PLANT SCHEDULE										
Qty.	Botanical Name	Common Name	Size (Min.)	Root	Remarks						
us Tree	25										
3	Celtis occidentalis	Hackberry	2.5" Cal.	B&B	As Shown						
2	Quercus coccinea	Scarlet Oak	2.5" Cal.	B&B	As Shown						
1	Quercus phellos	Willow Oak	2.5" Cal.	B&B	As Shown						
6	Total										
10	Itea virginica ' Fizzy Mizzy [®] Sweetspire'	Gem Box Inkberry	18-24" Hgt. & Sprd., #3	CONT.	36 IN O.C.						
10	Total										
	ANNE	ARUNDEL COUNTY									

DEPARTMENT OF PUBLIC WORKS DATE APPROVED DATE SCALE: 1" = 10' WILSON HOUSE RESTORATION HOT SOX FIELD AT WILSON PARK R.S.S. DRAWN BY: CHECKED BY: PROJECT MANAGER J.M.L. DATE APPROVED DATE SHEET NO. 05 OF 29 LANDSCAPE PLAN PROJECT NO.: P573200 CHIEF, RIGHT-OF-WAY CONTRACT NO.: P573201 EER © TRANSYSTEMS 2024

HDDKE	VIATIONS			1		DETAIL SYMBOLS
A/C	AIR CONDITION	FIN	FINISH	PLAM	PLASTIC LAMINATE	
ACC	ACCESSIBLE	FIXT	FIXTURE	PLAS	PLASTIC	(TYP)
ACOUS INSUL	ACOUSTICAL INSULATION	FLR	FLOOR	PLYWD	PLYWOOD	
ACT	ACOUSTICAL CEILING TILE	FLR FIN	FLOOR FINISH	PREFAB	PREFABRICATE	A101 A501
ADDL	ADDITIONAL	FLUOR	FLUORESCENT	PREFIN	PREFINISH	SHEET NUMBER WHERE
ADH	ADHESIVE	FO	FINISHED OPENING	PREP	PREPARATION	SECTION IS TAKEN
ADJ	ADJACENT, ADJOING, ADJUSTABLE	FRP	FIBERGLASS REINFORCED PLASTIC	PT	PAINT, PRESSURE TREATED	
AFF	ABOVE FINISHED FLOOR	FRZ	FREEZER	QRY	QUARRY	ELEVATION SYMBOL
ALT	ALTERNATE	FT	FEET, FIRE TREATED, FOOT	QT	QUARRY TILE	(TYP)
ALUM	ALUMINUM	FURN	FURNISH, FURNITURE	R	RADIUS, RISER	INDICATES DIRECTION
ANOD	ANODIZE	GA	GAGE	RB	RUBBER BASE	INTERIOR (TYP)
APPROX	APPROXIMATE	GALV	GALVANIC, GALVANIZED	RD	ROAD, ROOF DRAIN	ELEVATION 2
ARCH	ARCHITECT	GC	GENERAL CONTRACTOR	RECT	RECTANGLE	SYMBOL WITH 4 A101 A401 2 MULTIPLE VIEWS
AV		GL	GLASS	REF	REFERENCE, REFRIGERATOR	3
BATT	BATTEN	GLZ	GLAZING	REINF	REINFORCE	
BLDG	BUILDING	GYP	GYPSUM	REQD	REQUIRED	WALL SECTION SYMBOL
BLKHD	BULKHEAD	HC	HANDICAP	REV	REVISION	
BOT	BOTTOM	HDPE	HIGH DENSITY POLYETHYLENE	RFI	REQUEST FOR INFORMATION	
CB	CERAMIC BASE	HDW	HARDWARE	RH	RIGHT HAND	INDICATES DIRECTION OF CUTTING PLANE
CER	CERAMIC	HM	HOLLOW METAL	RM	ROOM	
CG	CORNER GUARD	HORIZ	HORIZONTAL	RO	ROUGH OPENING	(TYP)
CJ	CONSTRUCTION JOINT, CONTROL JOINT	HT	HEIGHT HEATING, VENTILATING, AND AIR	RT	RIGHT	
CL	CENTER LINE	HVAC	CONDITIONING	S	SOUTH	ENLARGED DETAIL SYMBOL
CLR	CLEAR, COLOR	INSTL	INSTALL	SC	SOLID CORE	
CMU	CONCRETE MASONRY UNIT	INSUL	INSULATION	SCHED	SCHEDULE	
COL	COLUMN	INT	INTERIOR	SCWD	SOLID CORE WOOD DOOR	DRAWING TITLE SYMBOL
CONC	CONCRETE	JAN	JANITOR	- SF	SQUARE FOOT (FEET)	A101 A101 SCALE: 0" = 0"
CONF	CONFERENCE	- L	ANGLE, LITER	- SHT	SHEET	
CONT	CONTINUE	LAM	LAMINATE	SIM	SIMILAR	— N
COORD	COORDINATE		LAVATORY	SPEC	SPECIFICATION	
CORR	CORRIDOR	LBS	POUND	SQ	SQUARE	PLAN NORTH SYMBOL
СРТ	CARPET	LED	LIGHT EMITTING DIODE	STC	SOUND TRANSMISSION CLASS	
СТ	CERAMIC TILE		LEFT HAND	STOR	STORAGE	FLOOR LEVEL SYMBOL
CTR	CENTER		LINEAR	STRUCT	STRUCTURAL	+ ELEV. 00.00
CYL	CYLINDER	MAINT	MAINTENANCE	SUSP	SUSPEND	FLOOR ELEVATION TAG
D	DEEP, DEPTH	MATL	MATERIAL	SYM	SYMBOL	FLOOR LEVEL
DEMO	DEMOLITION	MAX	MAXIMUM	- TEL	TELEPHONE	ROOM NAME & NUMBER ROOM NAME
DF	DRINKING FOUNTAIN	MECH	MECHANICAL	TEMP	TEMPORARY	TAG SYMBOL ###
DIA	DIAMETER	MEL	MELAMINE	ТНК	THICKNESS	
DIM	DIMENSION	MFR	MANUFACTURER	THRES	THRESHOLD	DOOR TAG SYMBOL
DIR	DIRECTION	MID	MIDDLE	THRU	THROUGH	
DISP	DISPENSER	MIN	MINIMUM, MINUTE	TK BD	TACKBOARD	WINDOW TAG SYMBOL
DIST	DISTANCE	MIRR	MIRROR	TMPD GL	TEMPERED GLASS	KEYNOTE TAG SYMBOL
DIV	DIVIDE, DIVISION	MISC	MISCELLANEOUS	ТО	TOP OF	KEYNOTE TAG SYMBOL
DS	DOWNSPOUT	MO	MASONRY OPENING	TV	TELEVISION	WALL TYPE TAG SYMBOL
DW	DISHWASHER	MOD	MODIFY	ТҮР	TYPICAL	
DWG	DRAWING	MTL	METAL	UL	UNDERWRITERS LABORATORIES	Λ
E	EAST	N	NORTH	UNO	UNLESS NOTED OTHERWISE	
EA	EACH		NOT APPLICABLE		UTILITY	
EL	ELEVATION	NAR	NARROW	VAR	VARIATION, VARIES	REVISION TAG &
ELEC	ELECTRIC		NOT IN CONTRACT	- VB	VINYL BASE	
ELEV	ELEVATION	NOM	NOMINAL	- VCT	VINYL COMPOSITION TILE	
EQ	EQUAL	NTS	NOT TO SCALE	VERT	VERTICAL	COLUMN BUBBLE & COLUMN GRID SYMBOL
EQUIP	EQUIPMENT		ON CENTER	VIF	VERIFY IN FIELD	
EQUIV	EQUIVALENT		OCCUPY	— W	WEST, WIDE	
EW	EACH WAY	OD	OUTSIDE DIAMETER	W/	WITH	
EXIST	EXISTING		OWNER FURNISHED/CONTRACTOR	W/O	WITHOUT	
EXT	EXTERIOR, EXTERNAL	OF/CI	INSTALLED	WB	WOOD BASE	
FD	FLOOR DRAIN	OFF	OFFICE	WC	WALL COVERING, WATER CLOSET	
FE	FIRE EXTINGUISHER	OF/OI	OWNER FURNISHED/OWNER INSTALLED	WD	WOOD	
FEC	FIRE EXTINGUISHER CABINET	OH	OVERHANG	WH	WATER HEATER	
				WLD	WELDED	
FF	FINISH FACE	OPH	OPPOSITE HAND	VVLD		
FF FF EL	FINISH FLOOR ELEVATION	OPH OPNG	OPPOSITE HAND OPENING	WM	WIRE MESH	



	-DETAIL DRAWING NUMBER
A101 A501	- SHEET NUMBER WHERE SECTION IS DRAWN
	- SHEET NUMBER WHERE SECTION IS TAKEN
1 (A101 A201)	
(TYP)	
1 (P)	-INDICATES DIRECTION OF VIEWING PLANE
1 A101 A401 2	2
3	
A101 A301	
(P)	
(P) 1	
A101 A501	
	OF OTION
	SECTION SCALE: 0" = 0"
A101 A101	
A101 A101	
A101 A101	SCALE: 0" = 0"
A101 A101	SCALE: 0" = 0"
A101 A101 N FLOOR LEV ELEV. 00.00 + ROOM NAME	SCALE: 0" = 0"
A101 A101 N FLOOR LEV ELEV. 00.00 FLOOR NAME ###	SCALE: 0" = 0"
A101 A101 N FLOOR LEV FLOOR LEV ELEV. 00.00 FLOOR NAME ### ###	SCALE: 0" = 0"
A101 A101 N FLOOR LEV ELEV. 00.00 FLOOR NAME ###	SCALE: 0" = 0"
A101 A101 N FLOOR LEV FLOOR LEV ELEV. 00.00 FLOOR NAME ### ###	SCALE: 0" = 0"
A101 A101 N FLOOR LEV ELEV. 00.00 + ROOM NAME ### ### ###	SCALE: 0" = 0"

GENERAL NOTES

- 1. GENERAL NOTES FOUND ON THIS SHEET APPLY TO ALL DRAWINGS. ALL WORK SHALL BE PERFORMED IN ACCORDANCE WITH ALL STATE 2. CODES, REGULATIONS AND ORDINANCES, MATERIAL EQUIPMENT, I PROCEDURES SHALL BE IN STRICT ACCORDANCE WITH THE APPLIC
- OF THE LATEST CURRENT EDITION OF THE REFERENCED DOCUMEN ACTUAL FIELD CONDITIONS MAY VARY FROM THOSE INDICATED. SH 3. CONDITIONS DIFFER FROM THOSE ORDINARILY ENCOUNTERED AND RECOGNIZED AS INHERENT IN WORK OF THE CONTRACTOR PROVID CONTRACT, THE CONTRACTOR SHALL PROMPTLY, BEFORE CONDITI NOTIFY THE OWNER'S MANAGER. FAILURE TO DO SO MAY WAIVE TH RIGHT TO RECEIVE ADDITIONAL TIME OR CONSIDERATION DUE TO S
- BY SUBMITTING A BID PROPOSAL, THE CONTRACTOR CERTIFIES TH 4. SITES AND UNDERSTANDS THE COMPLETE SCOPE OF WORK, WHICH PROPOSAL.
- DEFINITIONS: "PROVIDES" MEANS "FURNISH AND INSTALL". "VERIFY" 5. THE FIELD AND COORDINATE DIMENSIONS AND DISCREPANCIES"
- DIMENSIONS OF OPENINGS SHALL BE VERIFIED BY CONTRACTOR. S 6. INCLUDE A SCHEDULE OF ACTUAL OPENING DIMENSIONS AS VERIFI
- DURING THE WORK, ANY UNCOVERED CONDITIONS THAT CAUSE CC 7. INTENDED DESIGN MUST BE IMMEDIATELY BROUGHT TO THE ATTEN ARCHITECT.
- CONTRACTOR SHALL STAGE ALL WORK IN SUCH A WAY AS TO ENSU 8. EGRESS AT ALL TIMES.
- BEFORE COMMENCING ANY DEMOLITION, THE CONTRACTOR MUST 9. DEMOLITION WITH THE PROPOSED WORK AND OTHER DISCIPLINES.
- 10. THE ARCHITECT SHALL HAVE NO RESPONSIBILITY FOR THE DISCOV HANDLING, REMOVAL, DISPOSAL OF, OR EXPOSURE OF PERSONS T MATERIALS IN ANY FORM AT THE PROJECT SITE, INCLUDING BUT NOT LIMITED TO ASBESTOS, ASBESTOS PRODUCTS, POLYCHLORINATED BIPHENYL (PCB) OR OTHER TOXIC SUBSTANCES. CONTRACTOR TO CONTACT ARCHITECT AND OWNER IF THESE ITEMS ARE APPARENT OR SUSPECTED.
- 11. DO NOT SCALE DRAWINGS. USE WRITTEN DIMENSIONS ONLY.
- 12. ALL DIMENSIONS, NOTES, FINISHES AND FIXTURES SHOWN ON TYPICAL FLOOR PLANS, SECTIONS, OR DETAILS SHALL APPLY TO ALL SIMILAR, SYMMETRICAL OR OPPOSITE HAND
- PLANS, SECTIONS OR DETAILS. 13. COORDINATE WITH ALL EXISTING AND PROPOSED FLOOR WALL AND ROOF PENETRATIONS.
- 14. COORDINATE ALL NEW WORK WITH EXISTING CONDITIONS.
- 15. ARCHITECT IS NOT RESPONSIBLE FOR CONSTRUCTION THAT IS STARTED PRIOR TO PERMIT BEING ISSUED.
- APPLY, INSTALL, CONNECT, CLEAN AND/OR CONDITION MANUFACTURED ARTICLES, 16. MATERIALS AND/OR EQUIPMENT PER MANUFACTURER'S INSTRUCTIONS. IN CASE OF CONFLICT BETWEEN MANUFACTURER'S INSTRUCTIONS AND THE CONTRACT DOCUMENTS, THE CONTRACTOR SHALL OBTAIN WRITTEN CLARIFICATION FROM THE ARCHITECT BEFORE PROCEEDING.
- 17. PAINT FERROUS OR GALVANIZED METAL EXPOSED TO VIEW IN FINISHED CONSTRUCTION, OTHER THAN COMPLETELY FACTORY PREFINISHED ITEMS SPECIFIED.
- 18. PROVIDE MOISTURE RESISTANT GYPSUM BOARD AT ALL LOCATIONS WHERE GYPSUM BOARD IS SHOWN IN DRAWINGS.

	100% SUBMISSION
I hereby certify that these documents were prepared or	
approved by me, and that I am a duly licensed professional architect under the laws of the State of	
Mandand	

NO.

	APPROVED
	CHIEF ENGINEER
	APPROVED
	ASSISTANT CHIEF ENGINEER

DATE 08/01/24

ΒY

REVISIONS

DESCRIPTION


Maryland. License # <u>15613</u> Expiration Date: <u>11/26/24</u>

	MATERIALS	
S. TE, COUNTY AND LOCAL INSTALLATION, AND	CMU, CONCRET MASONRY UNIT	PLYWOOD
CABLE REQUIREMENTS NTS. HOULD ACTUAL	BRICK	PLYWOOD (SMALL SCALE)
ID GENERALLY DED FOR IN THE TIONS ARE DISTURBED, HE CONTRACTOR'S SUCH CONDITIONS.	CAST STONE OF PRECAST CONC	FINISHED HARDWOOD
HAT THEY HAVE VISITED CH IS INCLUDED IN THE	CONCRETE	CRUSHED GRAVEL STONE
" MEANS "VERIFY IN SHOP DRAWINGS SHALL FIED IN FIELD.	SAND OR GROU	COMPACT FILL EARTH
ONFLICT WITH THE NTION OF THE	RIGID INSULATION	NATURAL CUT STONE
URE SAFE EMERGENCY	BATT INSULATION	WOOD, BLOCKING & SHIMS
VERY, PRESENCE, TO HAZARDOUS	ALUMINUM	WOOD, FRAMING & FURRING

STEEL

ENGINEERED WOOD

	DEPART	MENT OF I	PUBLIC V	VORKS	
DATE	APPROVED	DATE	SCALE:	AS SHOWN	WILSON HOUSE RESTORATION
			DRAWN BY:	A.D.M.	HOT SOX FIELD AT WILSON PARK
	PROJECT MANAGER		CHECKED BY:	B.P.F.	
DATE	APPROVED	DATE	SHEET NO.	6 of 29	ABBREVIATIONS, SYMBOLS
			PROJECT NO.:	P573200	AND GENERAL NOTES
R	CHIEF, RIGHT-OF-WAY		CONTRACT NO .:	P573201	

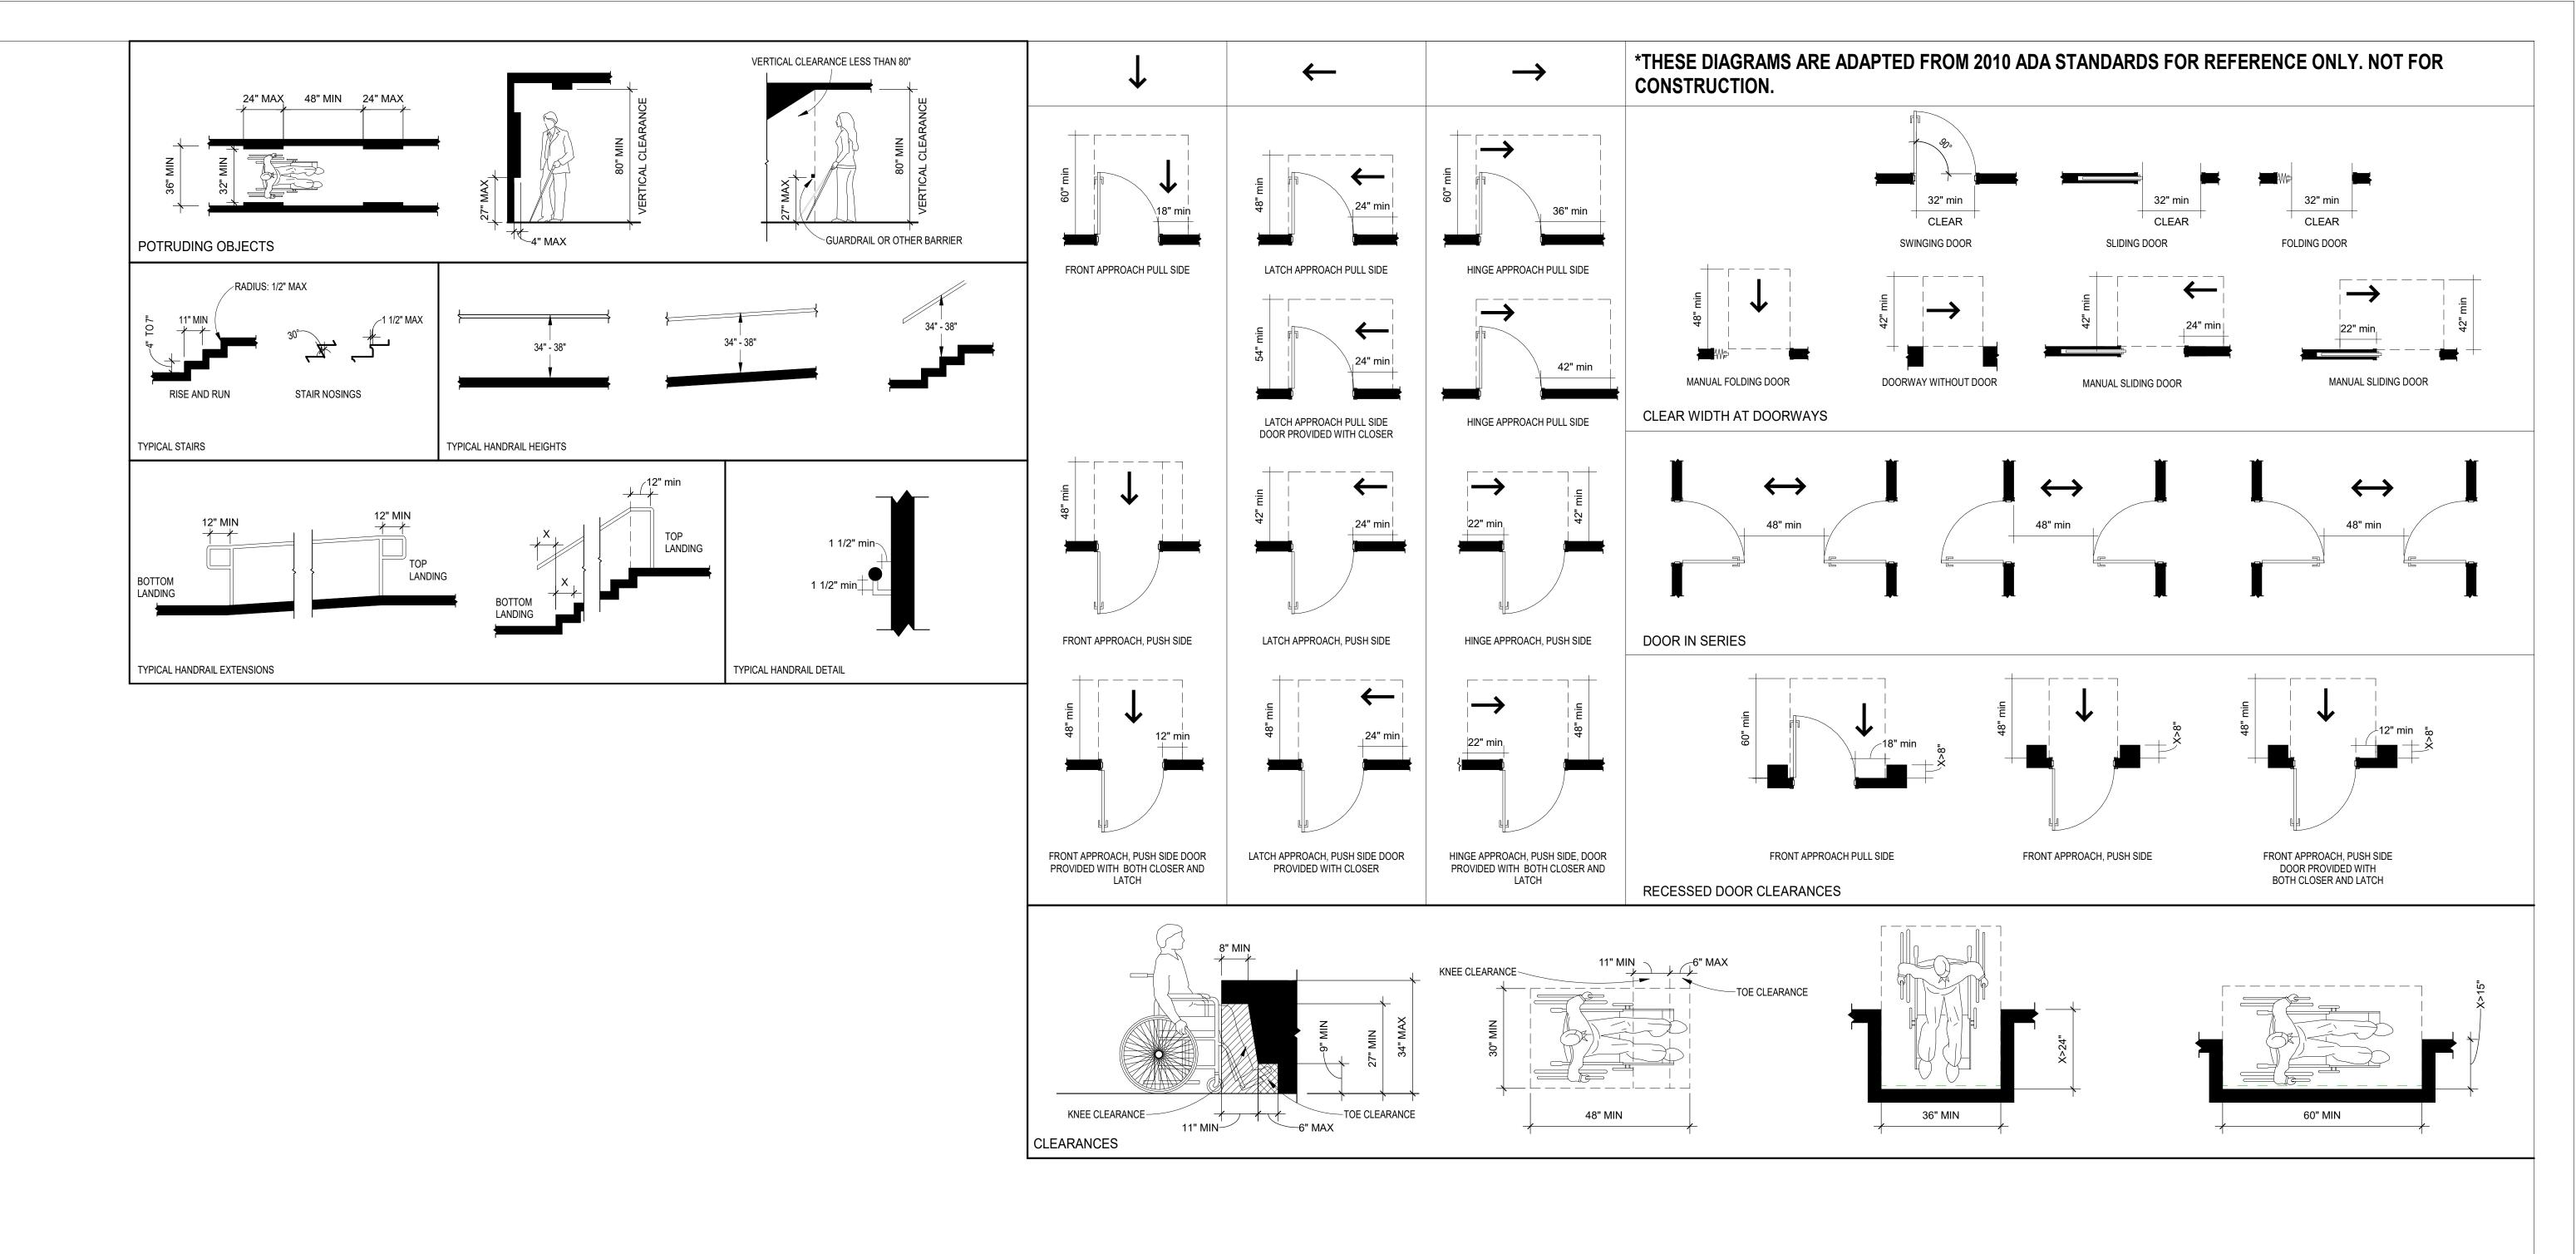



Joppa Road, Suite 200
Baltimore, MD 21286 www.transystems.com
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		REVISIONS			
	NO.	DESCRIPTION	BY	DATE	
		100% SUBMISSION		08/01/24	APPROVED
					-
					CHIEF ENGINEER
					APPROVED
I hereby certify that these documents were prepared or approved by me, and that I am a duly licensed professional architect under the laws of the State of					_
Maryland. License # <u>15613</u> Expiration Date: <u>11/26/24</u>					ASSISTANT CHIEF ENGINEER

DEPARTMENT OF PUBLIC WORKS									
DATE	APPROVED	DATE	SCALE:	AS SHOWN	WILSON HOUSE RESTORATION				
			DRAWN BY:	A.D.M.	HOT SOX FIELD AT WILSON PARK				
	PROJECT MANAGER		CHECKED BY:	B.P.F.					
DATE	APPROVED	DATE	SHEET NO.	7 of 29	ADA GENERAL				
			PROJECT NO .:	P573200	STANDARDS				
EER	CHIEF, RIGHT-OF-WAY		CONTRACT NO .:	P573201					
					© TRANSYSTEMS 2024				

1.1 PROJECT TEAM AND LOCATION INF NAME AND ADDRESS ANNE ARUNDEL MAP 69 PARCEL GALESVILLE, ME OWNER REP. / AGENT PROFESSIONALS OF RECORD: BRYAN F 1.2 STATEMENT OF WORK / PROJECT E RESTORATION OF EXISTING HISTORIC PROPOSED USE UNOCCUPIED SPACE. FINISHES BOTH INTERIOR AND EXTERIOR ORIENTATION, AND APPEARANCE. NEW PLUMBING SYSTEMS CURRENTLY EXIS AT THE COMPLETION OF THE PROJECT FLOOR THAT WILL BE VIEWABLE TO TH COUNTY STAFF WILL BE PERMITTED TO EXHIBITS.	COUNTY 572 572 0 20765 FISHER LICENSE #: 1561 DESCRIPTION BUILDING PREVIOSLY U REPAIR EXISTING CHIM DR. NEW HISTORICALLY OR. NEW HISTORICALLY OR. NEW HISTORICALLY OR. NEW HISTORICALLY OR. NEW HISTORICALLY TOUD-LOOK COMPOS TAND THERE ARE NO F , THE BUILDING WILL BE E PUBILC ONLY BY LOO	SED AS A SINGLE-FAM NEY, ROOF, AND STRU ACCURATE FINISHES I DOORS TO MATCH ORIC ITE BOARDWALK AND I LANS TO INSTALL SUC E UNOCCUPIED AND WI KING THROUGH EXTER	AILY DWELLIN JCTURE. REN BOTH INTER IGINAL IN MA DECK. NO EI CH SYSTEMS VILL HAVE FU RIOR WINDO	NG. CURRENTI MOVE EXISTIN RIOR AND EXTE TERIAL, SIZE, LECTRICAL, M S AS PART OF T JRNISHED ROC	LY UNOCCUPIED - G NON-ORIGINAL ERIOR. ALL NEW SHAPE, PLACEMEN ECHANICAL, OR THE CURRENT WOR DMS ON THE FIRST
ANNE ARUNDEL MAP 69 PARCEL GALESVILLE, MI PROFESSIONALS OF RECORD: BRYAN F 1.2 STATEMENT OF WORK / PROJECT I RESTORATION OF EXISTING HISTORIC PROPOSED USE UNOCCUPIED SPACE. FINISHES BOTH INTERIOR AND EXTERIO WINDOWS. ALL NEW EXTERIOR DOORS ORIENTATION, AND APPEARANCE. NEW PLUMBING SYSTEMS CURRENTLY EXIS AT THE COMPLETION OF THE PROJECT FLOOR THAT WILL BE VIEWABLE TO TH COUNTY STAFF WILL BE PERMITTED TO EXHIBITS.	572 0 20765 FISHER LICENSE #: 1561 DESCRIPTION BUILDING PREVIOSLY U REPAIR EXISTING CHIM DR. NEW HISTORICALLY . NEW WINDOWS AND E V WOOD-LOOK COMPOS T AND THERE ARE NO F , THE BUILDING WILL BE E PUBILC ONLY BY LOO	SED AS A SINGLE-FAM NEY, ROOF, AND STRU ACCURATE FINISHES I DOORS TO MATCH ORIC ITE BOARDWALK AND I LANS TO INSTALL SUC E UNOCCUPIED AND WI KING THROUGH EXTER	AILY DWELLIN JCTURE. REN BOTH INTER IGINAL IN MA DECK. NO EI CH SYSTEMS VILL HAVE FU RIOR WINDO	NG. CURRENTI MOVE EXISTIN RIOR AND EXTE TERIAL, SIZE, LECTRICAL, M S AS PART OF T JRNISHED ROC	LY UNOCCUPIED - G NON-ORIGINAL ERIOR. ALL NEW SHAPE, PLACEMEN ECHANICAL, OR THE CURRENT WOR DMS ON THE FIRST
MAP 69 PARCEL GALESVILLE, MI PROFESSIONALS OF RECORD: BRYAN F 1.2 STATEMENT OF WORK / PROJECT D RESTORATION OF EXISTING HISTORIC PROPOSED USE UNOCCUPIED SPACE. FINISHES BOTH INTERIOR AND EXTERIOR WINDOWS. ALL NEW EXTERIOR DOORS ORIENTATION, AND APPEARANCE. NEW PLUMBING SYSTEMS CURRENTLY EXIS AT THE COMPLETION OF THE PROJECT FLOOR THAT WILL BE VIEWABLE TO TH COUNTY STAFF WILL BE PERMITTED TO EXHIBITS.	572 0 20765 FISHER LICENSE #: 1561 DESCRIPTION BUILDING PREVIOSLY U REPAIR EXISTING CHIM DR. NEW HISTORICALLY . NEW WINDOWS AND E V WOOD-LOOK COMPOS T AND THERE ARE NO F , THE BUILDING WILL BE E PUBILC ONLY BY LOO	SED AS A SINGLE-FAM NEY, ROOF, AND STRU ACCURATE FINISHES I DOORS TO MATCH ORIC ITE BOARDWALK AND I LANS TO INSTALL SUC E UNOCCUPIED AND WI KING THROUGH EXTER	AILY DWELLIN JCTURE. REN BOTH INTER IGINAL IN MA DECK. NO EI CH SYSTEMS VILL HAVE FU RIOR WINDO	NG. CURRENTI MOVE EXISTIN RIOR AND EXTE TERIAL, SIZE, LECTRICAL, M S AS PART OF T JRNISHED ROC	LY UNOCCUPIED - G NON-ORIGINAL ERIOR. ALL NEW SHAPE, PLACEMEN ECHANICAL, OR THE CURRENT WOR DMS ON THE FIRST
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			INLY UCCASI		
	AL CONSIDERATIONS				
ADOPTED CODES MODEL/ BASE	CODE NAME EDITION				
APPLICABLE CODES AS ADOPTED AND				TED CODES, 2	2024
BUILDING: 2021		G CODE: BUILDING CO	-		
LIFE SAFETY: 2018		G CODE: LIFE SADETY		-	
ACCESSIBILITY:		le and Useable Buildings - ICC A117.1-2009	s and		


CHAPTER 3	USE AND OCCUPANCY CLASSI	FICATION						
SECTION 311.2	MODERATE HAZARD STORAGE	GROUP S-1						
CHAPTER 5	GENERAL BUILDING HEIGHTS	AND AREAS						
TABLE 504.3	ALLOWABLE BUILDING HEIGHT	ALLOWABLE BUILDING HEIGHT IN FEET ABOVE GRADE PLANE						
	GROUP S-1, NON-SPRINKLERED	GROUP S-1, NON-SPRINKLERED = 40 FEET ABOVE GRADE						
		DPOINT OF ROOF SLOPE, COMPLIES						
TABLE 504.4	ALLOWABLE NUMBER OF STORIES							
	GROUP S-1, NON-SPRINKLERED, TYPE VB CONSTRUCTION = 1 STORIES, COMPIES WITH REQUIREMENT AS							
		TIED AS AN UNFINISHED, UNOCCUPIABLE AT						
		OVED. NO OCCUPANTS WILL ENTER THE SP						
MAINTENANCE BY AA COUNTY STAFF. NO FURNISHINGS, ITEMS, OT MATERIALS WILL BE STORED IN TH								
SECTION 506.2	ALLOWABLE AREA FACTOR							
	GROUP S-1, NON-SPRINKLERED, TYPE VB CONSTRUCTION = 9,000 SF							
	EXISTING AREA = 577 SF, COMPLIES							
CHAPTER 6 TYPES OF CONSTRUCTION								
TABLE 601	ABLE 601 FIRE RESISTANCE RATING REQUIREMENTS FOR BUILDING ELEMENTS							
	TYPE VB CONSTRUCTION							
	Primary Structural Frame	0 Hour Rated						
	Bearing Walls Ext.	0 Hour Rated						
	Bearing Walls Int.	0 Hour Rated						
	Non-Bearing Walls & Partitions	0 Hour Rated						
	Floor Construction	0 Hour Rated						
	Roof Construction	0 Hour Rated						
TABLE 602		UIREMENTS FOR EXTERIOR WALLS BASED	ON FIRE SEPARATION DISTANCE					
	,	N, OCCUPANCY GROUP S-1 = 0 HR						
CHAPTER 7	FIRE AND SMOKE PROTECTION	IFEATURES						
SECTION 705	EXTERIOR WALLS							
TABLE 705.8	MAXIMUM AREA OF EXTERIOR WALL OPENINGS BASED ON FIRE SEPARATION DISTANCE AND DEGREE OF							
	FIRE SEPARATION DISTANCE = 30 FEET OR GREATER, UNPROTECTED, NONSPRINKLERED = NO LIMIT							
SECTION 705.8.5	VERTICAL SEPARATION OF OPE							
		CEPTION 1 FOR BUILDINGS THREE STORIE	S OR LESS ABOVE GRADE					
CHAPTER 8	INTERIOR FINISHES							
TABLE 803.13	INTERIOR WALL AND CEILING F	INISH REQUIREMENTS BY OCCUPANCY						
	GROUP S, NONSPRINKLERED, C	CLASS C REQUIRED FOR ROOMS AND SPAC	ES					




		REVISIONS						
	NO.	DESCRIPTION	BY	DATE				
		100% SUBMISSION		08/01/24	APPROVED			
					CHIEF ENGINEER			
I hereby certify that these documents were prepared or								
approved by me, and that I am a duly licensed professional architect under the laws of the State of								
Maryland. License # <u>15613</u> Expiration Date: <u>11/26/24</u>					ASSISTANT CHIEF ENGINEEF			

ANNE ARUNDEL COUNTY

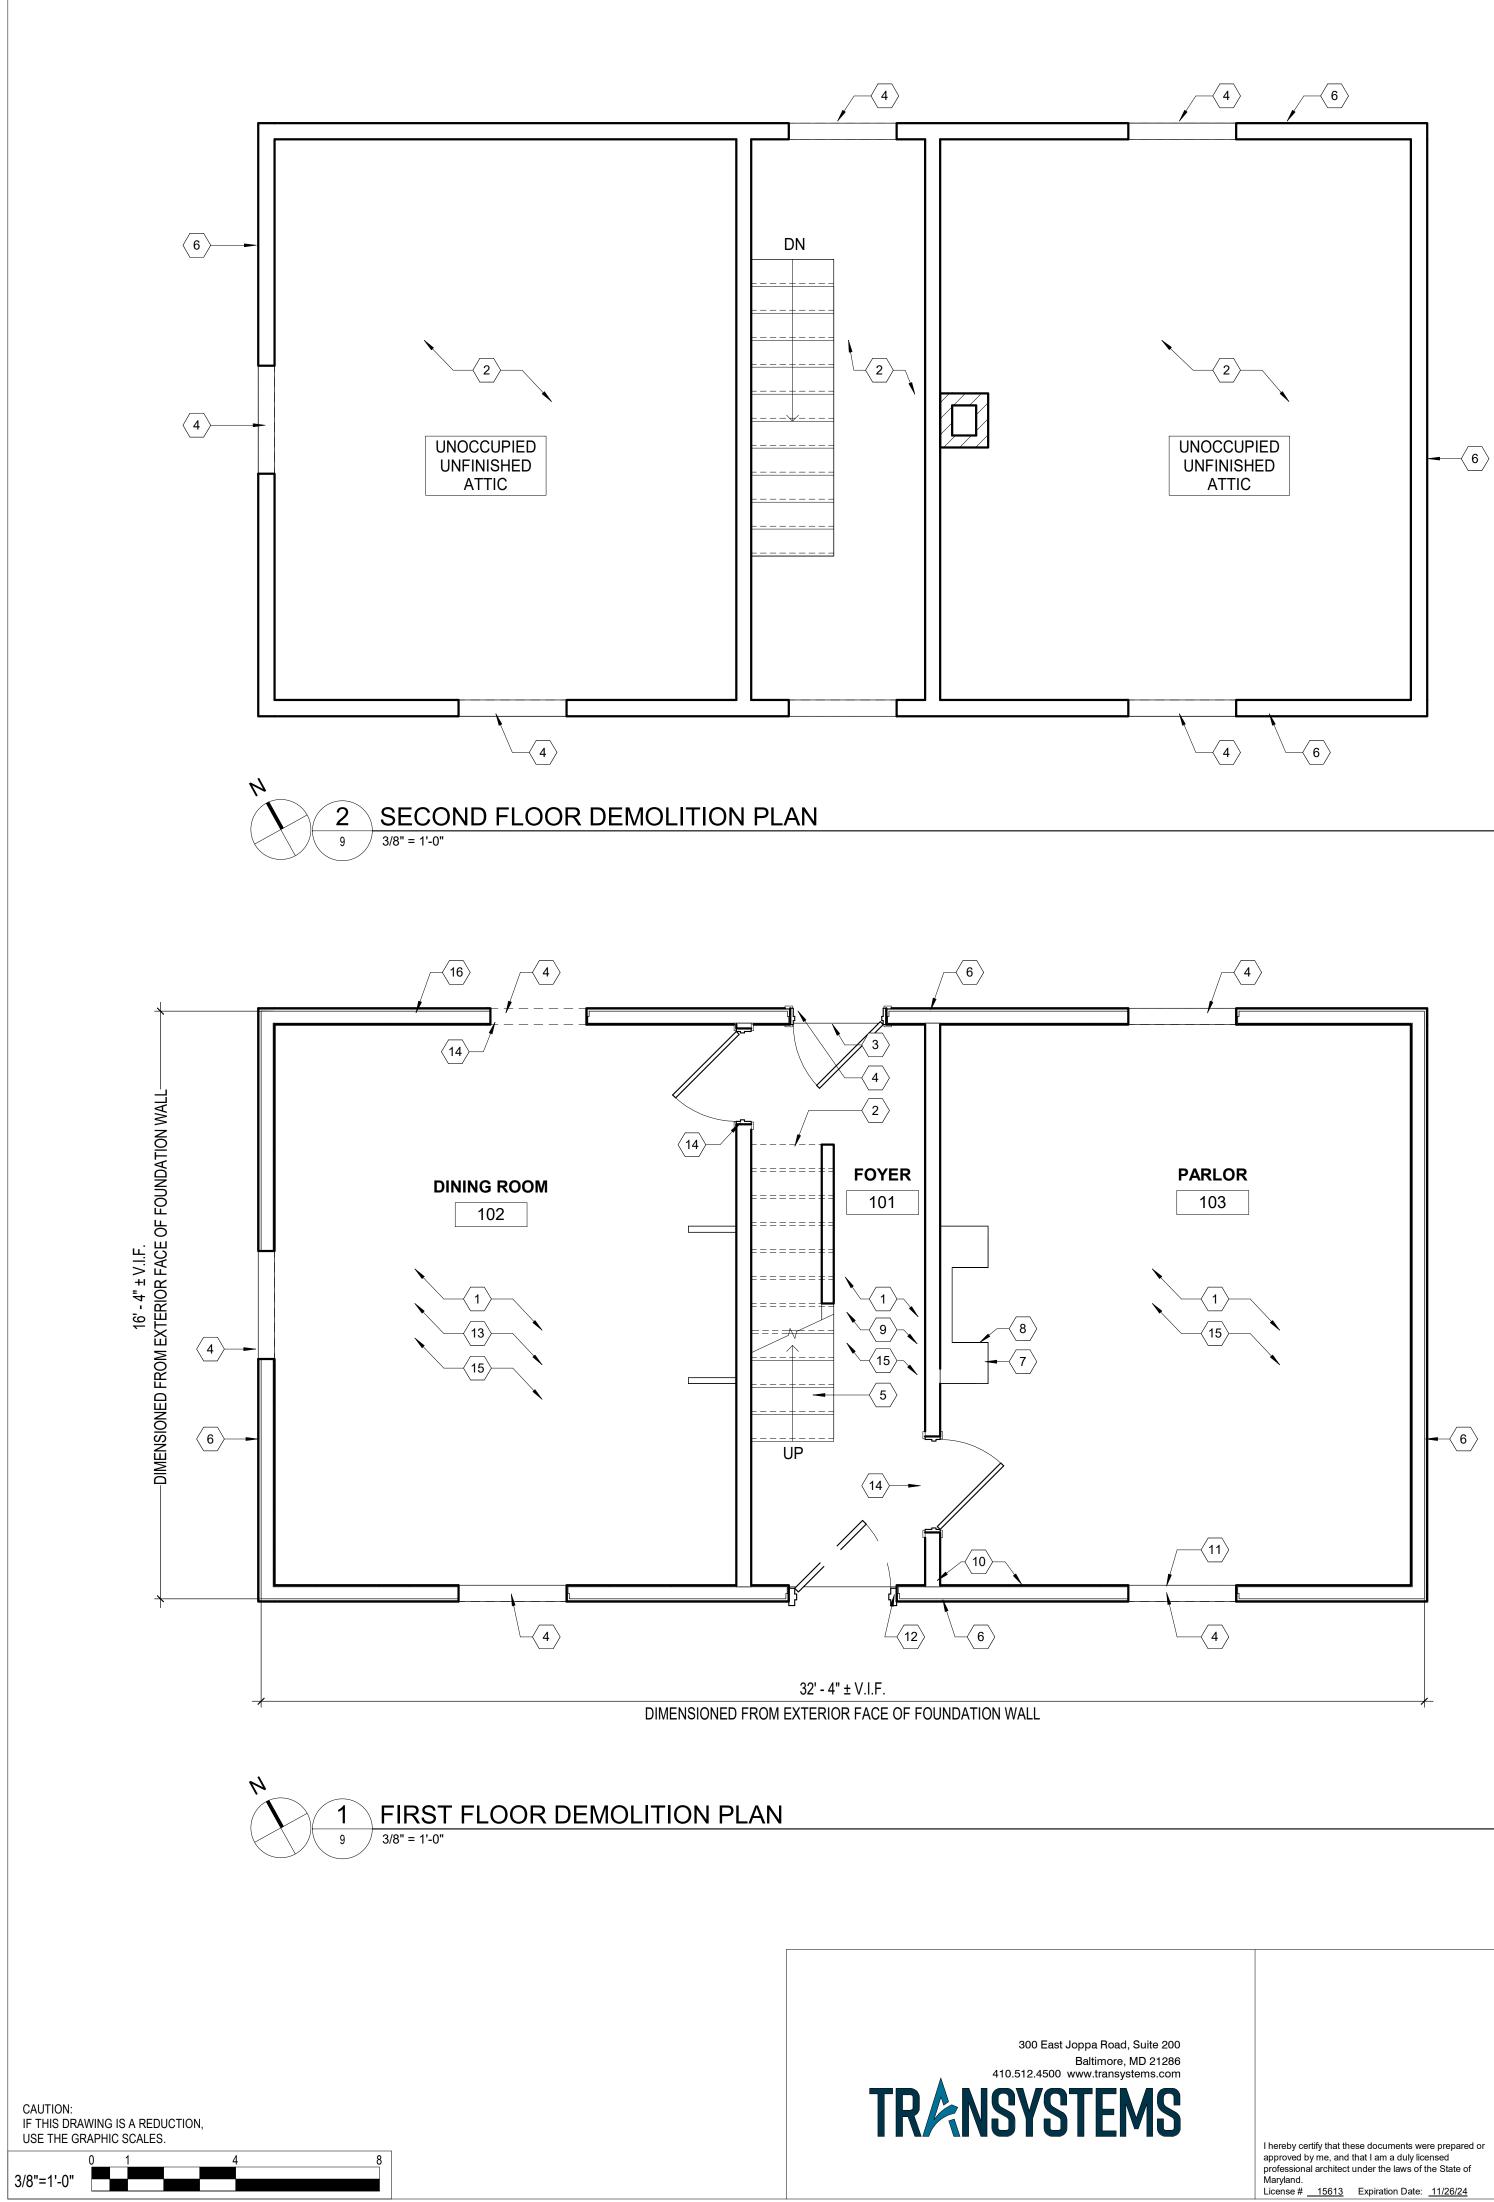DEPARTMENT OF PUBLIC WORKS DATE SCALE: DATE APPROVED WILSON HOUSE RESTORATION AS SHOWN HOT SOX FIELD AT WILSON PARK DRAWN BY: A.D.M. CHECKED BY: B.P.F. PROJECT MANAGER DATE SHEET NO. 8 of 29 DATE APPROVED CODE ANALYSIS PROJECT NO.: P573200 CONTRACT NO.: P573201 CHIEF, RIGHT-OF-WAY © TRANSYSTEMS 2024



		REVISIONS			
	NO.	DESCRIPTION	BY	DATE	
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					APPROVED
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Maryland. License # <u>15613</u> Expiration Date: <u>11/26/24</u>					ASSISTANT CHIEF ENGINEER

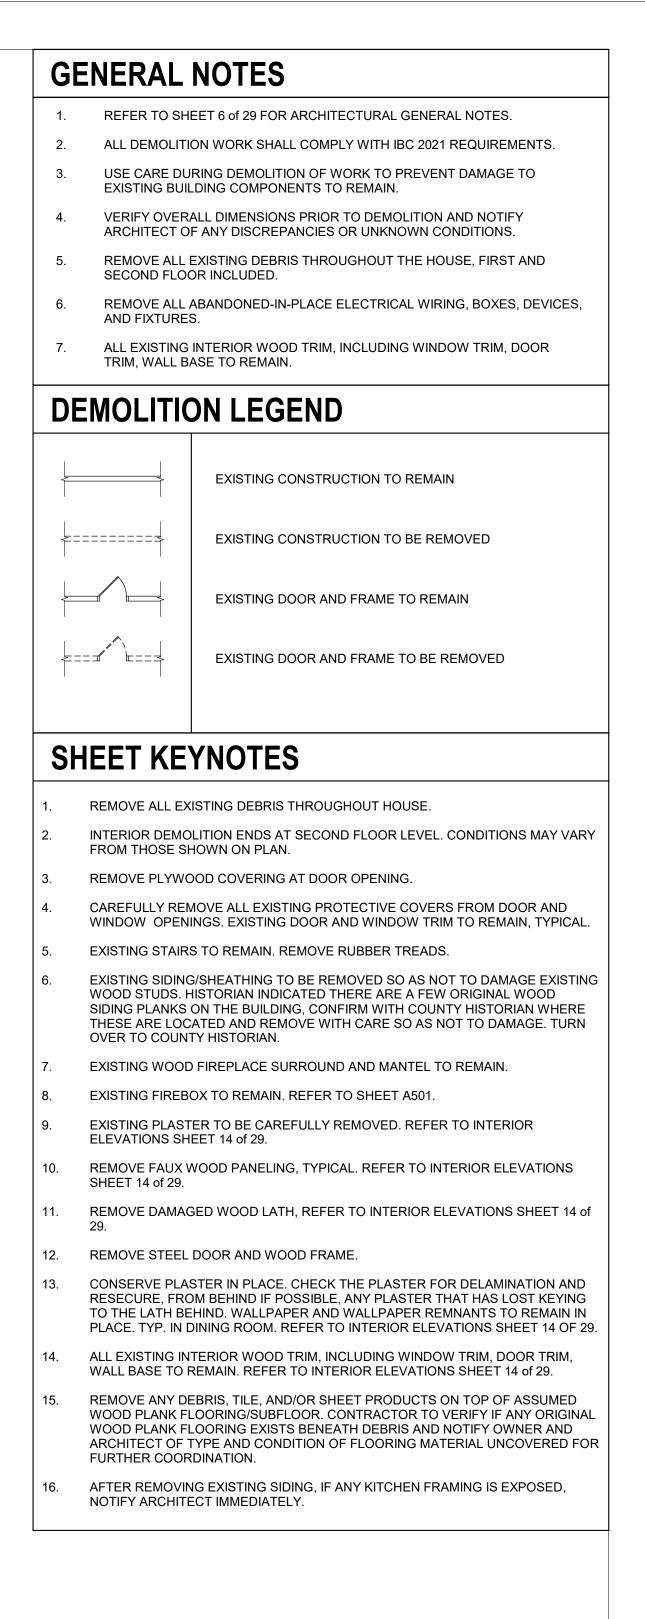

	DEPARTN	MENT OF	PUBLIC \	NORKS	
DATE	APPROVED	DATE	SCALE:	AS SHOWN	WILSON HOUSE RESTORATION
			DRAWN BY:	A.D.M.	HOT SOX FIELD AT WILSON PARK
	PROJECT MANAGER		CHECKED BY:	B.P.F.	
DATE	APPROVED	DATE	SHEET NO.	9 of 29	DEMOLITION FLOOR
			PROJECT NO.:	P573200	PLANS
	CHIEF, RIGHT-OF-WAY		CONTRACT NO.:	P573201	
	· · · ·				© TRANSYSTEMS 2024



-RAKE AND REPOINT CHIMNEY MORTAR; INSTALL VENTED CAPS ON CHIMNEYS. -FASCIA TO REMAIN, TYP. UNO.

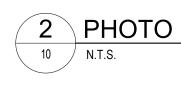
-SOFFIT TO REMAIN, TYP. UNO.

-EXISTING SIDING TO BE CAREFULLY REMOVED SO AS NOT TO DAMAGE EXISTING STRUCTURE

REMOVE PROTECTIVE COVERS FROM WINDOW OPENINGS

REMOVE STEEL DOOR AND WOOD FRAME







6 PHOTO 10 N.T.S.

10 N.T.S.

-DEMOLITION ENDS AT SECOND FLOOR LEVEL

-EXISTING DOOR AND FRAME TO REMAIN

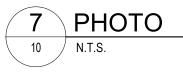
-EXISTING PLASTER TO BE CAREFULLY REMOVED SO AS TO LEAVE LATH IN PLACE

-REMOVE PLYWOOD DEBRIS TO BE REMOVED FROM BUILDING

-EXISTING WOOD TRIM AND CASING TO REMAIN



BUILDING







-REMOVE FAUX WOOD PANELING

-EXISTING WOOD WINDOW TRIM AND APRON TO REMAIN



12 PHOTO 10 N.T.S.



-EXISTING METAL DRIP EDGES TO REMAIN

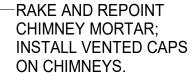
-FASCIA TO REMAIN, TYP. UNO.

SOFFIT TO REMAIN, TYP. UNO.

-EXISTING PLYWOOD TO BE CAREFULLY REMOVED SO AS NOT TO DAMAGE EXISTING STRUCTURE







-WOOD SHINGLES TO REMAIN

-FASCIA TO REMAIN, TYP. UNO.

-SOFFIT TO REMAIN, TYP. UNO.

-EXISTING PLYWOOD TO BE CAREFULLY REMOVED SO AS NOT TO DAMAGE EXISTING STRUCTURE

-REMOVE PROTECTIVE COVERS FROM WINDOW OPENINGS

EXISTING SIDING/SHEATHING TO BE REMOVED SO AS NOT TO DAMAGE EXISTING WOOD STUDS -EXISTING LATH TO

BE LEFT IN PLACE -EXISTING WOOD

TRIM AND CASING TO REMAIN

-DEBRIS TO BE **REMOVED FROM**

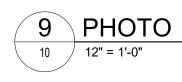


-EXISTING LATH TO BE LEFT IN PLACE

-EXISTING BRICK TO REMAIN


-EXISTING WOOD FIREPLACE SURROUND AND MANTEL TO REMAIN -EXISTING FIREBOX TO REMAIN





-EXISTING ELECTRICAL PANEL AND ASSOCIATED CONDUIT TO BE DEMOLISHED

		REVISIONS						
	NO.	DESCRIPTION	BY	DATE				
		100% SUBMISSION		08/01/24	APPROVED			
					CHIEF ENGINEER			
					APPROVED			
I hereby certify that these documents were prepared or approved by me, and that I am a duly licensed professional architect under the laws of the State of								
Maryland. License # <u>15613</u> Expiration Date: <u>11/26/24</u>					ASSISTANT CHIEF ENGINEER			

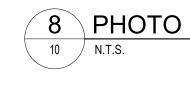



-WOOD FASCIA TO BE REPLACED IN THIS AREA WITH SAME MATERIAL, PAINT TO MATCH EXISTING

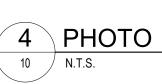
-SOFFIT TO REMAIN, TYP. UNO.

-REMOVE PROTECTIVE COVERS FROM WINDOW OPENINGS

-EXISTING SIDING TO BE CAREFULLY REMOVED SO AS NOT TO DAMAGE EXISTING STRUCTURE



-WOOD FASCIA TO BE REPLACED IN THIS AREA WITH SAME MATERIAL, PAINT TO MATCH EXISTING





-EXISTING WOOD FIREPLACE SURROUND AND MANTEL TO REMAIN

EXISTING FIRE BOX TO REMAIN

EXISTING BRICK

TO REMAIN

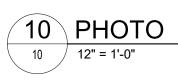


REMOVE FAUX WOOD PANELING

EXISTING DOOR AND FRAME TO REMAIN


EXISTING WOOD TRIM AND CASING TO REMAIN

-REMOVE DAMAGED WOOD LATH



ANNE ARUNDEL COUNTY

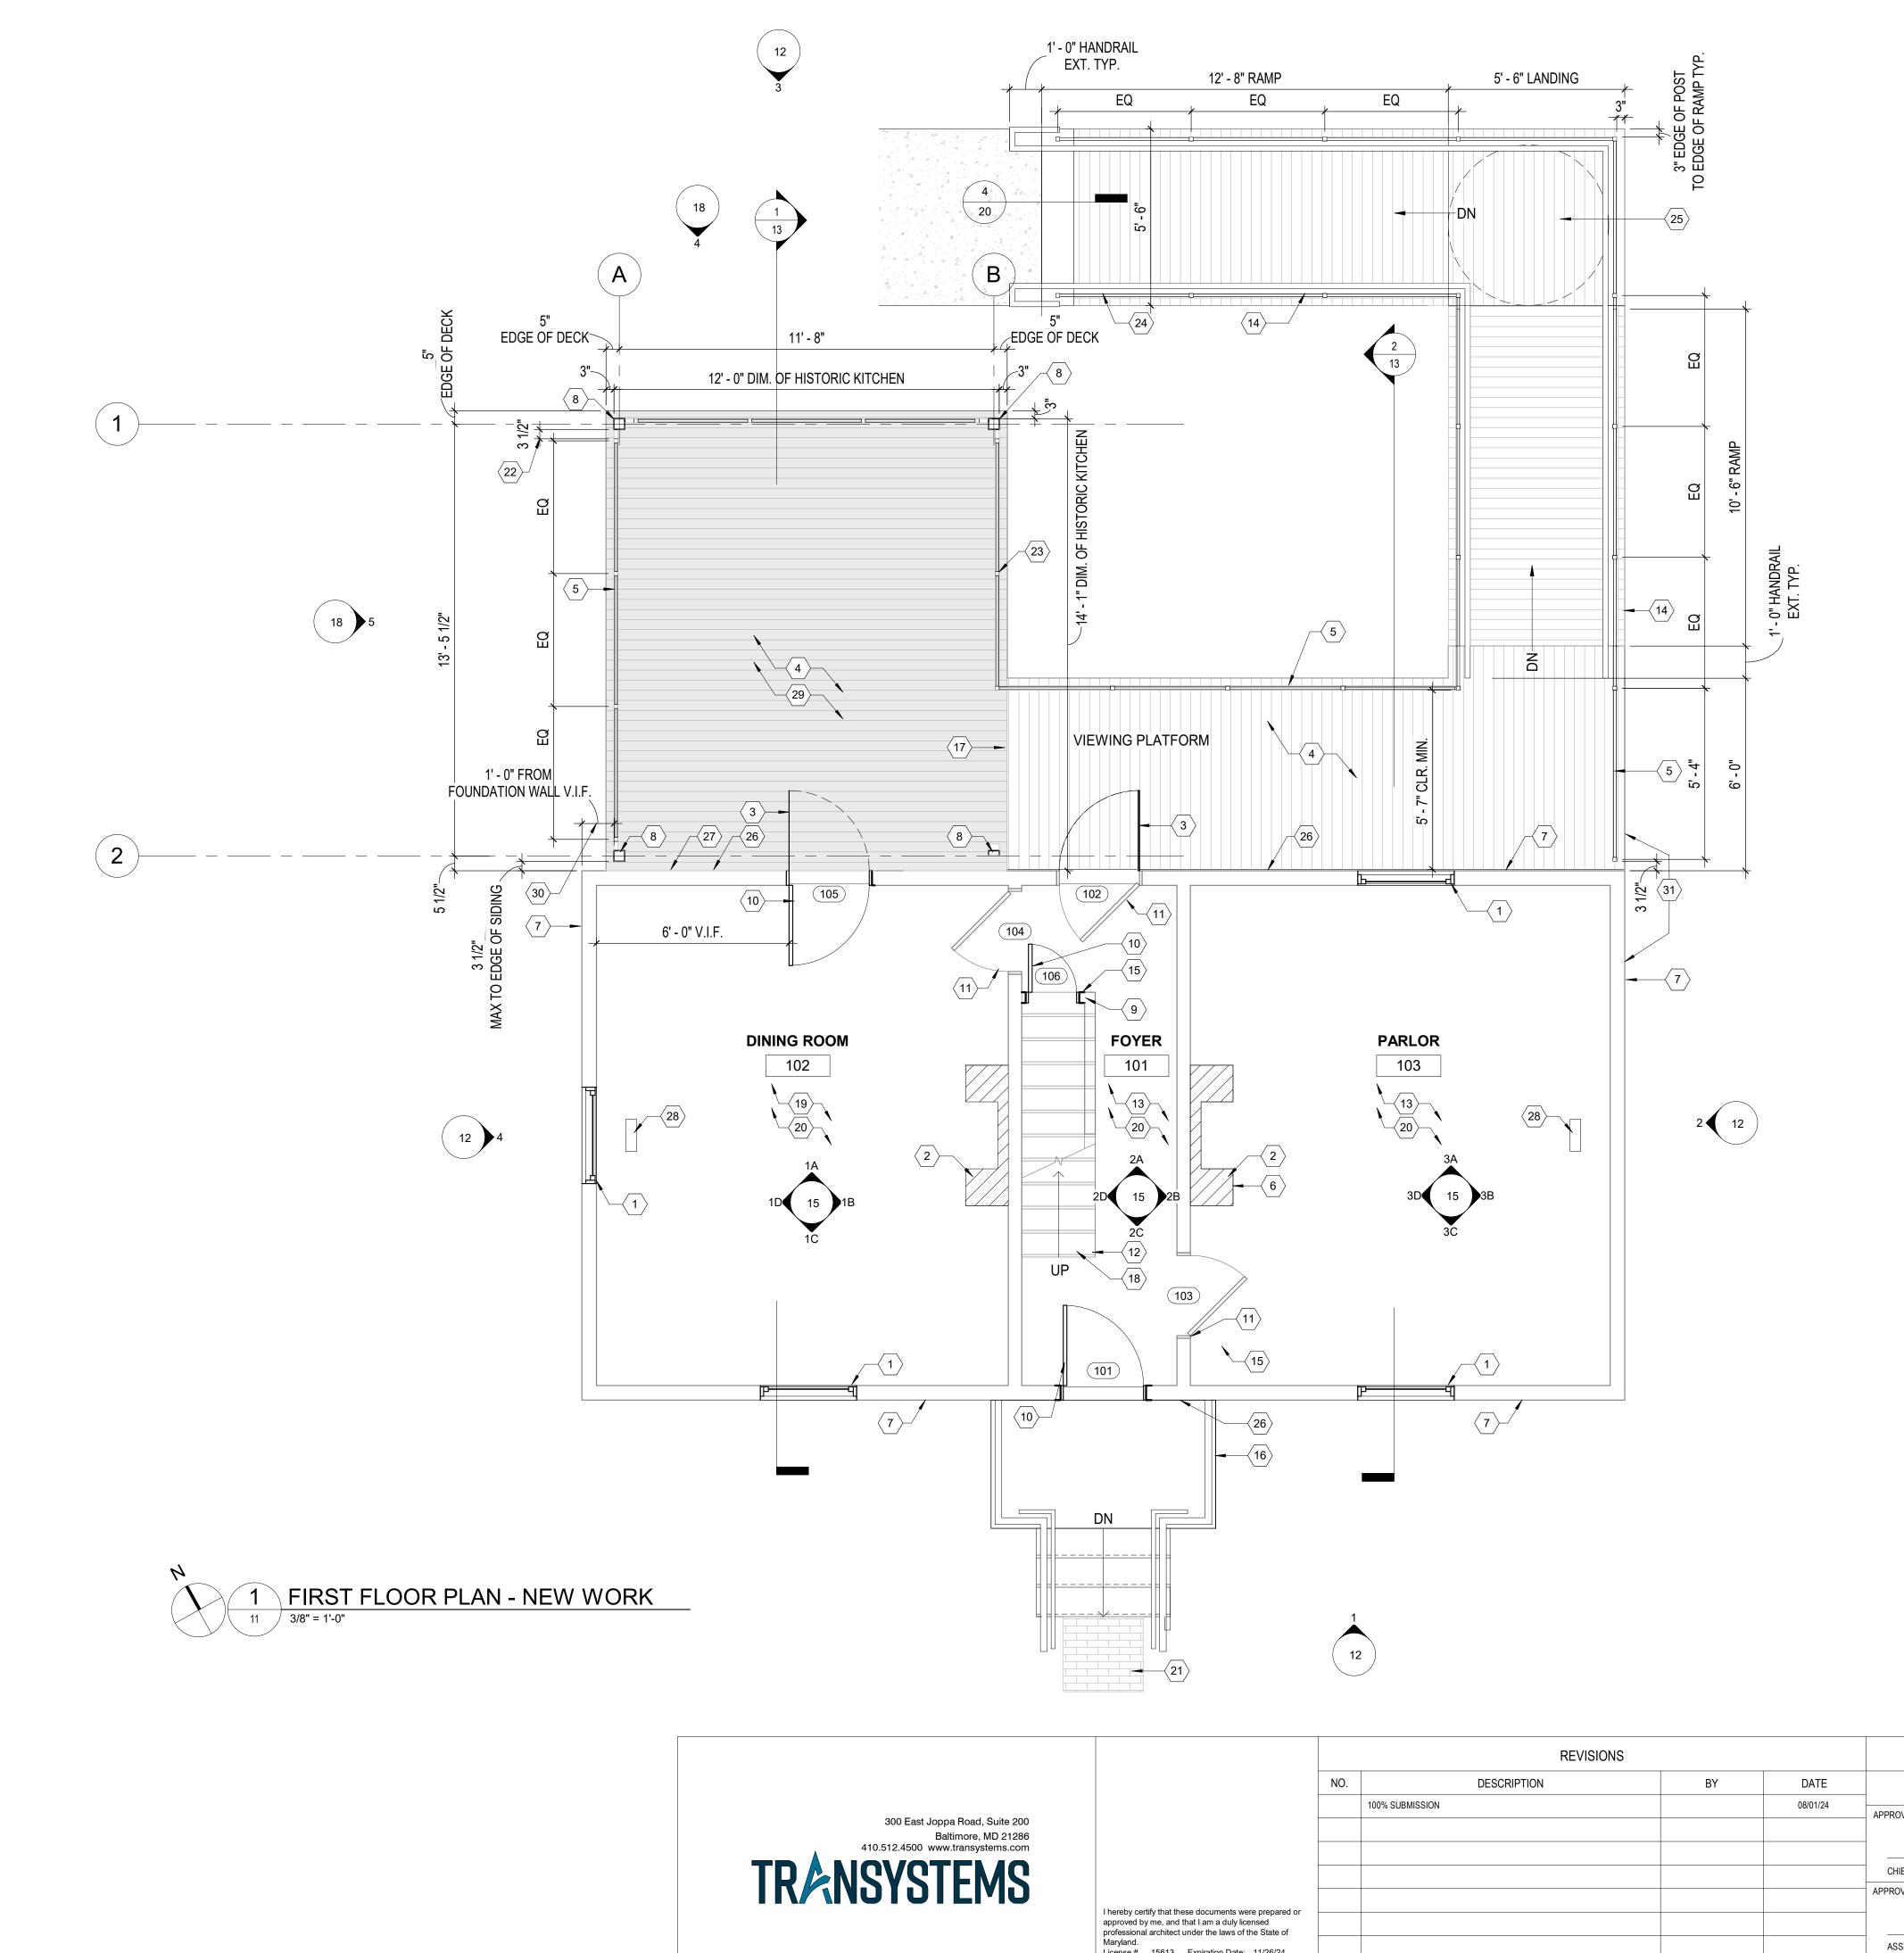DEPARTMENT OF PUBLIC WORKS DATE SCALE: DATE APPROVED WILSON HOUSE RESTORATION AS SHOWN HOT SOX FIELD AT WILSON PARK DRAWN BY: A.D.M. CHECKED BY: B.P.F. PROJECT MANAGER **EXISTING CONDITIONS** DATE APPROVED DATE SHEET NO. 10 of 29 PHOTOS PROJECT NO .: P573200 CHIEF, RIGHT-OF-WAY CONTRACT NO.: P573201 © TRANSYSTEMS 2024



APPROVED CHIEF ENGINEER APPROVED

License # 15613 Expiration Date: 11/26/24

ASSISTANT CHIEF ENGINEER

	DEPARTM	IENT OF I	PUBLIC V	VORKS	
DATE	APPROVED	DATE	SCALE:	AS SHOWN	WILSON HOUSE RESTORATION
			DRAWN BY:	A.D.M.	HOT SOX FIELD AT WILSON PARK
	PROJECT MANAGER		CHECKED BY:	B.P.F.	
DATE	APPROVED	DATE	SHEET NO.	11 of 29	NEW WORK FLOOR
			PROJECT NO.:	P573200	PLANS
	CHIEF, RIGHT-OF-WAY		CONTRACT NO .:	P573201	
			1		© TRANSYSTEMS 2

					EXISTING CONSTRUCTION TO REMAIN
					EXISTING DOOR AND FRAME TO REMAIN
					NEW CONSTRUCTION
					NEW DOOR AND FRAME
		-	SHE	ET KE	YNOTES
		-		ALL EXISTING	/ WOOD WINDOWS. REFER TO SHEET 22 of 29 FOR DETAILS. WOOD WINDOW TRIM TO REMAIN. PROVIDE NEW PAINT ON TRIM IN HISTORICALLY ACCURATE COLOR.
			2.	REFER TO SHE	EET 16 of 29 FOR FIREBOX DETAILS.
				NEW FRAMELE WITHIN WOOD	ESS GLASS DOOR MOUNTED OUTBOARD OF WOODEN DOOR DEN FRAME.
				PRESSURE-TR FOR DETAILS.	REATED WOOD DECKING. REFER TO STRUCTURAL DRAWINGS
				NEW POWDER DETAILS.	R COATED METAL GUARDRAIL. REFER TO SHEET 20 of 29 FOR
			6.	EXISTING BRIC	CK FIREBOX AND WOOD MANTLE SURROUND TO REMAIN.
					AP SIDING IN HISTORICALLY ACCURATE COLOR, TYP.
				BLACK POWDE FOR DETAILS.	ER COATED METAL POST, REFER TO STRUCTURAL DRAWINGS
			9.	NEW WORK E	NDS AT SECOND FLOOR LEVEL.
				DETAILS. CON	CALLY ACCURATE DOOR, REFER TO DOOR SCHEDULE FOR TRACTOR TO MEASURE DOOR OPENING AND PROVIDE ELD VERIFIED DOOR DIMENSION ON SHOP DRAWINGS.
					OD DOOR AND WOOD TRIM TO REMAIN. SCRAPE WOOD OF NT, REPAINT IN HISTORICALLY ACCURATE COLOR.
				TO BE PROVID	IRS AND WOOD TRIM TO REMAIN. NEW REPLICA BALUSTERS DED WHERE EXISTING BALUSTERS ARE MISSING. REFER TO 9 FOR DETAILS.
					AIN, TYP. PROVIDE NEW 1/2" MOISTURE RESISTANT GYP. E INDICATED ON ELEVATIONS.
				CONTRACTOR ENSURE ADA (BE PROVIDED DRAWINGS FC	NT RAMP, REFER TO SHEET 20 of 29 FOR DETAILS. R TO VERIFY ELEVATIONS PRIOR TO CONSTRUCTION TO COMPLIANT SLOPE. CONTRACTOR VERIFIED ELEVATIONS TO ON SHOP DRAWINGS FOR REVIEW. REFER TO CIVIL OR LOCATION AND SLOPE OF RAMP. SLOPE OF RAMP TO BE H CONTRACTOR VERIFIED ELEVATIONS AND PROVIDED ON RAWINGS.
				PROVIDE NEW	/ WOOD STUD AND 1/2" MOISTURE RESISTANT GYP. BOARD
					EET 19 of 29 FOR FRONT PORCH DETAILS.
					RECTION OF PRESSURE TREATED WOOD DECKING, REFER TO DWGS. FOR DETAILS.
			18.	EXISTING PAIN	NT FINISH ON STAIR TREADS AND RISERS TO REMAIN. ENSURE NTO EXISTING PAINT ON TREADS IS PRESERVED.
				AND RESECUR KEYING TO TH	ASTER IN PLACE. CHECK THE PLASTER FOR DELAMINATION RE, FROM BEHIND IF POSSIBLE, ANY PLASTER THAT HAS LOST IE LATH BEHIND. WALLPAPER AND WALLPAPER REMNANTS TO ACE. REFER TO EXISTING INTERIOR ELEVATION PHOTOS ON 9.
				ORIGINAL WOO TO MATCH FLO	EREMOVED FROM BUILDING. CONTRACTOR TO VERIFY IF ANY OD PLANK FLOORING EXISTS BENEATH DEBRIS. CONTRACTOR OORING IN KIND. IF EVIDENCE OF ORIGINAL FLOORING IS NOT NTRACTOR TO PROVIDE 5/4" THICK T&G PINE PLANK 'P.
					CK SIDEWALK TO BE EXCAVATED. STAIR/LANDING FOOTINGS IRB EXISTING WALK
					CLR BETWEEN KITCHEN SKELETON METAL POST AND OST, TYPICAL. REFER TO STRUCTURAL DWGS. FOR DETAIL.
			23.	GUARDRAIL PO	OST TO ALIGN W/ POST ON OPP. SIDE.
					ALK, REFER TO CIVIL DWGS. FOR DETAILS.
					CLR. ADA TURNING RADIUS AT LANDING. GAP BETWEEN SIDING AND WOOD DECK.
				NOTIFY ARCHI EXISTING DOC	VING EXISTING SIDING, IF ANY KITCHEN FRAMING IS EXPOSED, ITECT IMMEDIATELY. KITCHEN SKELETON BASED OFF OF CUMENTS AND PHOTOS. EDGE OF KITCHEN SKELETON TO DGE OF EXISTING EXTERIOR FRAMING.
					OR VENT WITH BUG SCREEN BETWEEN EXISTING FLOOR R TO SPECIFICATIONS FOR DETAILS.
CAUTION:			29.	SHADED AREA	A OF DECK TO RECEIVE DIFFERENT STAIN COLOR, ARCHITECT ROM MANUF. FULL RANGE OF STAIN OPTIONS AND COLORS.
IF THIS DRAWING IS A USE THE GRAPHIC S		8	30.	AFTER REMOV	VING EXISTING SIDING, IF ANY KITCHEN FRAMING IS EXPOSED, ITECT IMMEDIATELY. EDGE OF KITCHEN SKELETON TO ALIGN
/8"=1'-0"					F EXISTING EXTERIOR FRAMING. OF SIDING AND EDGE OF DECK
	ANN				
					S
DATE	APPROVED	DATE	SCALE:	AS SHOWN	
			DRAWN BY:	A.D.M.	HOT SOX FIELD AT WILSON PARK
DATE	PROJECT MANAGER	DATE	CHECKED BY:		NEW WORK FLOOR
DATE			SHEET NO.	11 of 29	

PLAN LEGEND

3.

4

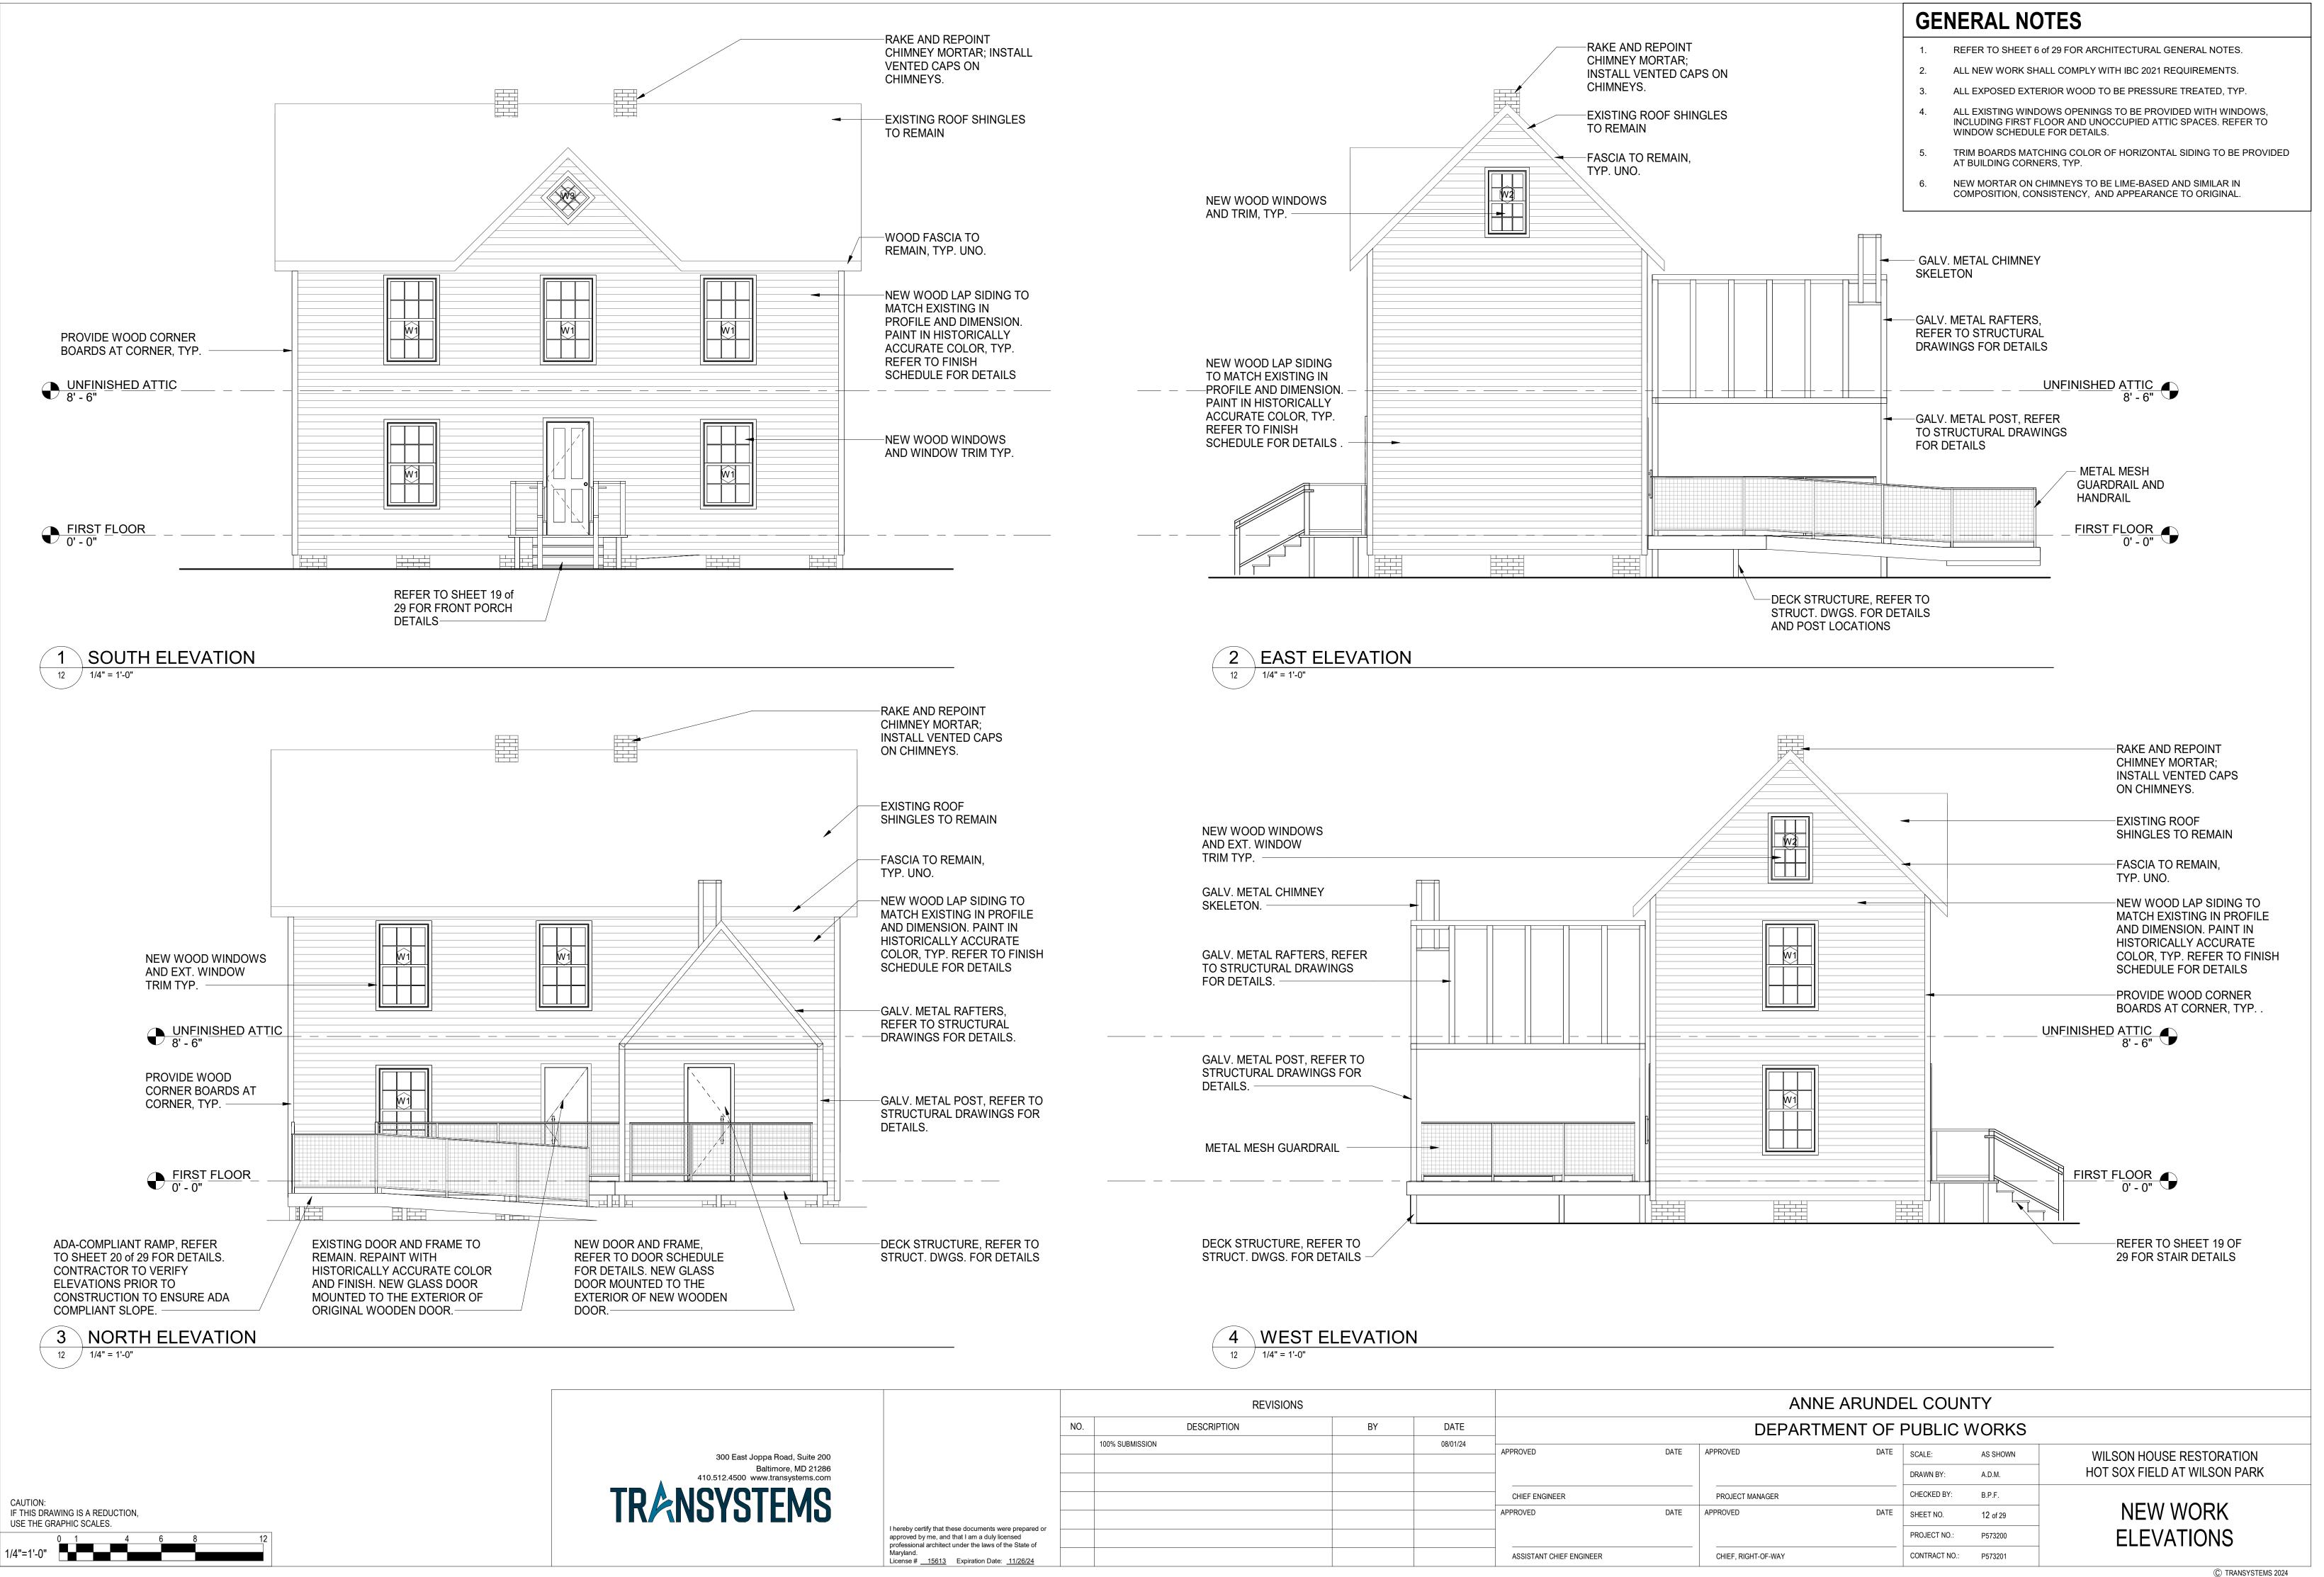
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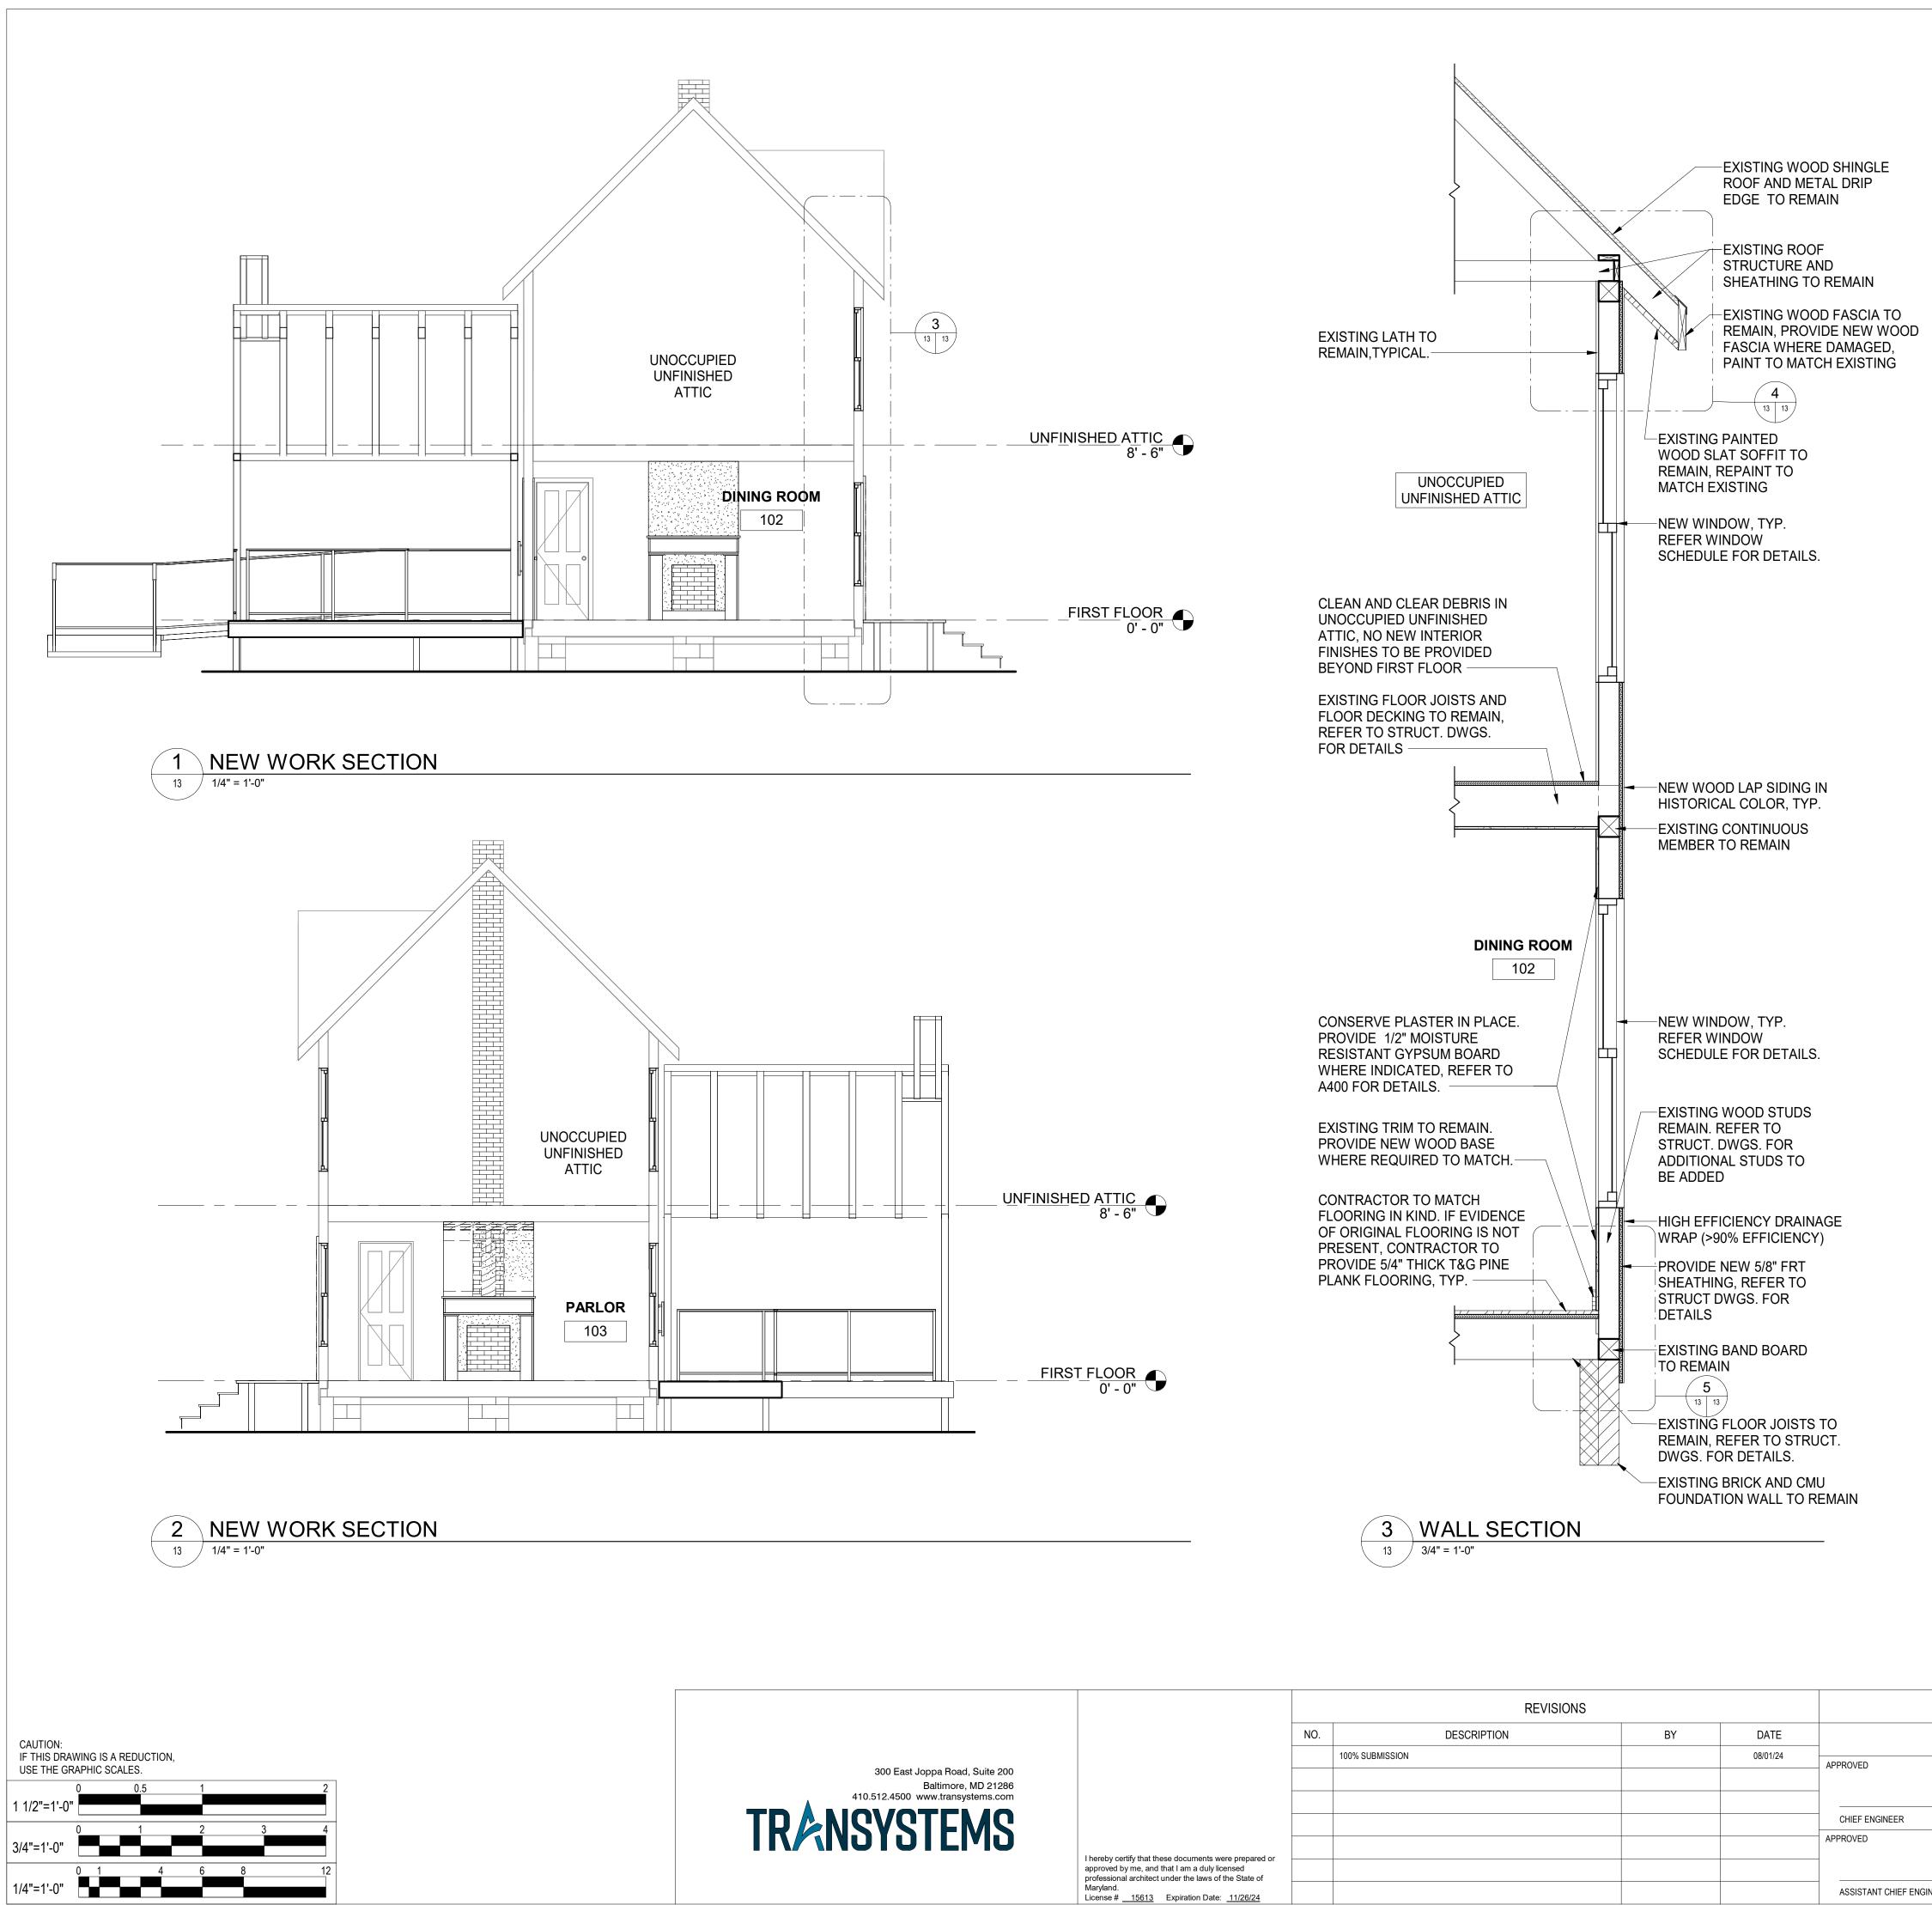
REFER TO SHEET G002 FOR ARCHITECTURAL GENERAL NOTES. ALL NEW WORK SHALL COMPLY WITH IBC 2021 REQUIREMENTS. USE CARE DURING DEMOLITION OF WORK TO PREVENT DAMAGE TO

EXISTING BUILDING COMPONENTS TO REMAIN. VERIFY OVERALL DIMENSIONS PRIOR TO DEMOLITION AND NOTIFY ARCHITECT OF ANY DISCREPANCIES OR UNKNOWN CONDITIONS. REMOVE ALL EXISTING DEBRIS THROUGHOUT THE HOUSE, FIRST AND


SECOND FLOOR INCLUDED. FLOOR, WALL AND CEILING FINISHES NOT TO BE REMOVED UNTIL AFTER COMPLETION OF HISTORIAN'S PAINT AND WALLPAPER STUDY.




	NO.	DESCRIPTION	BY	DATE	
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				<u> </u>	
					CHIEF ENGINEER
					APPROVED
certify that these documents were prepared or d by me, and that I am a duly licensed					
onal architect under the laws of the State of I.					ASSISTANT CHIEF ENGINEER
# <u>15613</u> Expiration Date: <u>11/26/24</u>					




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		100% SUBMISSION		08/01/24	APPROVED
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te of <u>5/24</u>					ASSISTANT CHIEF ENGINEER

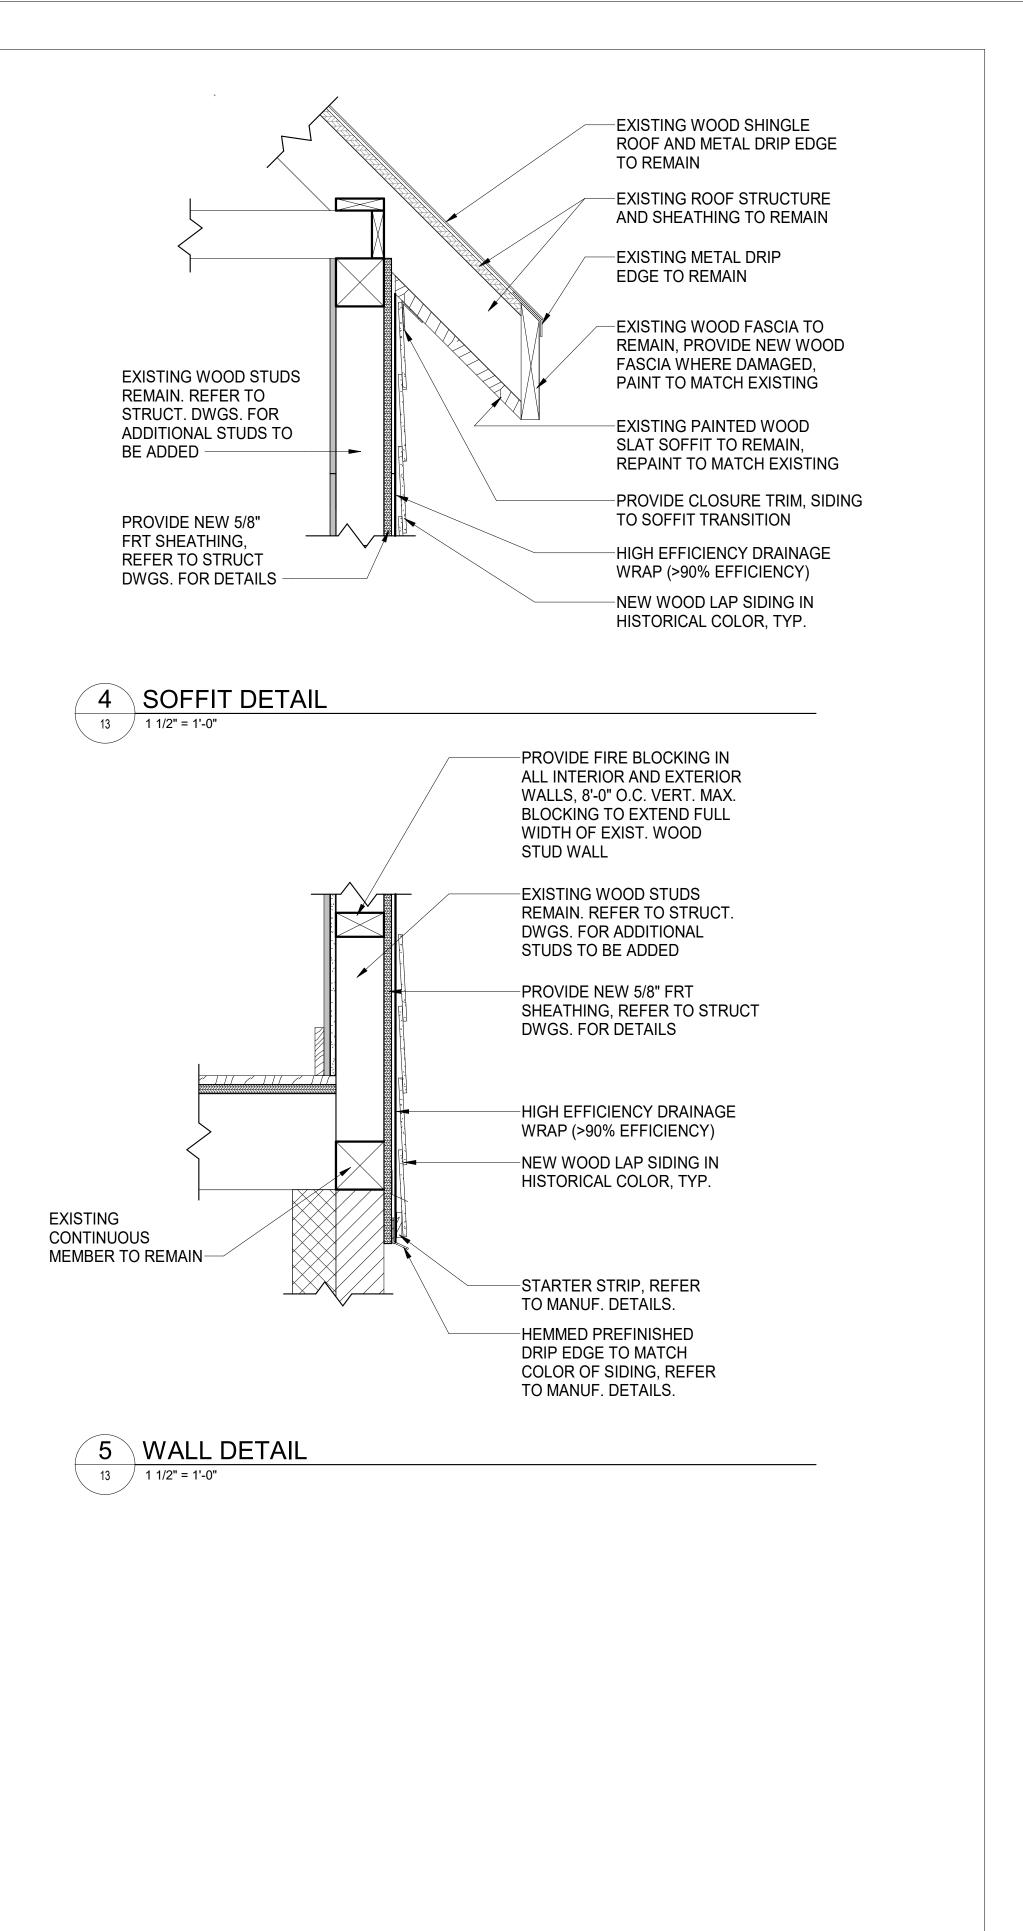

	DEPARTN	IENT OF		NORKS	
DATE	APPROVED	DATE	SCALE:	AS SHOWN	WILSON HOUSE RESTORATION
			DRAWN BY:	A.D.M.	HOT SOX FIELD AT WILSON PARK
	PROJECT MANAGER		CHECKED BY:	B.P.F.	
DATE	APPROVED	DATE	SHEET NO.	13 of 29	SECTIONS AND DETAILS
			PROJECT NO.:	P573200	SLUTIONS AND DETAILS
	CHIEF, RIGHT-OF-WAY		CONTRACT NO .:	P573201	

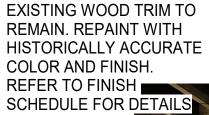

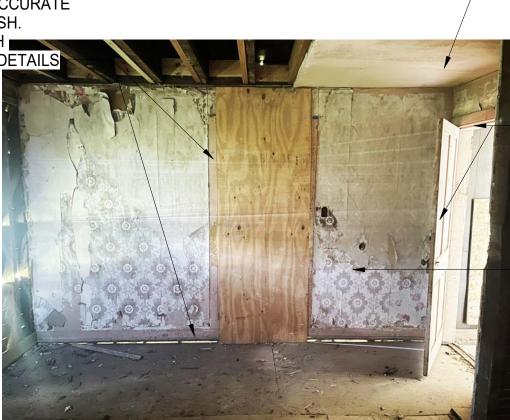

NORTH ELEVATION

DINING ROOM EXISTING ELEVATIONS 14 / N.T.S.

-REMOVE PAINTED PLASTER OR DRYWALL FROM CEILING. TAKE CARE TO NOT DAMAGE EXISTING FLOOR JOISTS. PROVIDE 1/2" MOISTURE RESISTANT GYPSUM BOARD

-EXISTING DOOR AND FRAME TO REMAIN. REPAINT WITH HISTORICALLY ACCURATE COLOR AND FINISH. REFER TO FINISH SCHEDULE FOR DETAILS

-CONSERVE PLASTER IN PLACE. CHECK THE PLASTER FOR DELAMINATION AND RESECURE, FROM BEHIND IF POSSIBLE, ANY PLASTER THAT HAS LOST KEYING TO THE LATH BEHIND. WALLPAPER AND WALLPAPER REMNANTS TO REMAIN IN PLACE. TYP. IN DINING ROOM



REMOVE PAINTED PLASTER OR DRYWALL

EXISTING FLOOR

GYPSUM BOARD

FROM CEILING. TAKE

CARE TO NOT DAMAGE

JOISTS. PROVIDE 1/2"

MOISTURE RESISTANT

-EXISTING DOOR, FRAME

AND TRIM TO REMAIN

-EXISTING PLASTER TO

REMOVED SO AS TO

-REMOVE PLYWOOD

-REMOVE FAUX WOOD

PANELING, TYP.

LEAVE LATH IN PLACE

BE CAREFULLY

EAST ELEVATION



NORTH ELEVATION



2 FOYER ELEVATIONS

DEMOLITION ENDS AT SECOND FLOOR LEVEL

-EXISTING DOOR AND FRAME TO REMAIN

-EXISTING PLASTER TO BE CAREFULLY REMOVED SO AS TO LEAVE LATH IN PLACE

REMOVE PLYWOOD

-DEBRIS TO BE REMOVED FROM BUILDING. CONTRACTOR TO VERIFY IF ANY ORIGINAL WOOD PLANK FLOORING EXISTS **BENEATH DEBRIS. CONTRACTOR** TO MATCH FLOORING IN KIND. IF EVIDENCE OF ORIGINAL FLOORING IS NOT PRESENT, CONTRACTOR TO PROVIDE 5/4" THICK T&G PINE PLANK FLOORING, TYP.

-EXISTING WOOD TRIM AND CASING TO REMAIN



NORTH ELEVATION CORNER



PROVIDE 1/2" MOISTURE **RESISTANT GYPSUM** BOARD ON ALL WALLS IN PARLOR. PAINT WITH HISTORICALLY ACCURATE COLOR AND FINISH. REFER TO FINISH SCHEDULE FOR DETAILS

-REMOVE FAUX WOOD PANELING, TYP.

-REMOVE PROTECTIVE **COVER FROM WINDOW** OPENING. EXISTING WOOD WINDOW TRIM AND APRON TO REMAIN



SOUTHEAST CORNER



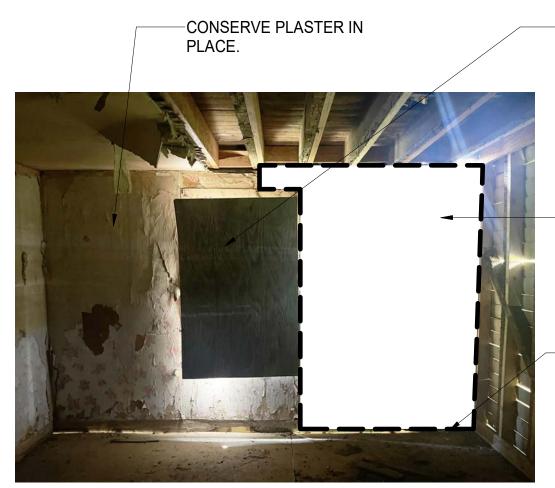


REMOVE PAINTED PLASTER OR DRYWALL FROM CEILING. TAKE CARE TO NOT DAMAGE EXISTING FLOOR JOISTS. PROVIDE 1/2" MOISTURE **RESISTANT GYPSUM BOARD**

-EXISTING WOOD TRIM TO REMAIN. REPAINT WITH HISTORICALLY ACCURATE COLOR AND FINISH. REFER TO FINISH SCHEDULE FOR DETAILS

-DEBRIS TO BE REMOVED FROM BUILDING.

CONTRACTOR TO VERIFY IF ANY ORIGINAL WOOD PLANK FLOORING EXISTS BENEATH DEBRIS. CONTRACTOR TO MATCH FLOORING IN KIND. IF EVIDENCE OF ORIGINAL FLOORING IS NOT PRESENT. CONTRACTOR TO PROVIDE 5/4" THICK T&G PINE PLANK FLOORING, TYP.



SOUTH ELEVATION

-REMOVE PAINTED PLASTER OR DRYWALL FROM CEILING. TAKE CARE TO NOT DAMAGE EXISTING FLOOR JOISTS. PROVIDE 1/2" MOISTURE RESISTANT GYPSUM BOARD



-DEBRIS TO BE REMOVED FROM BUILDING



WEST ELEVATION

PROVIDE 1/2" MOISTURE RESISTANT GYPSUM BOARD CEILING. PAINT. PAINT WITH HISTORICALLY ACCURATE COLOR AND FINISH. REFER TO FINISH SCHEDULE FOR DETAILS

-DEBRIS TO BE REMOVED FROM BUILDING. CONTRACTOR TO VERIFY IF ANY ORIGINAL WOOD PLANK FLOORING EXISTS BENEATH DEBRIS. CONTRACTOR TO MATCH FLOORING IN KIND. IF EVIDENCE OF ORIGINAL FLOORING IS NOT PRESENT, CONTRACTOR TO PROVIDE 5/4" THICK T&G PINE PLANK FLOORING, TYP.



REMOVE

WIRING

EXISTING LIGHT

ASSOCIATED

SWITCH AND ALL

-EXISTING WOOD

TO REMAIN

TRIM AND CASING

PROVIDE NEW WOOD BASE WHERE **REQUIRED TO MATCH** EXISTING IN KIND

	NO.	DESCRIPTION	BY	DATE	
		100% SUBMISSION		08/01/24	APPROVED
reported or					APPROVED
repared or ed State of					
/26/24					ASSISTANT CHIEF ENGINEEF

hereby certify that these documents were approved by me, and that I am a duly license professional architect under the laws of the Maryland. License # <u>15613</u> Expiration Date: <u>11</u>

SOUTH ELEVATION

-REMOVE PROTECTIVE COVER FROM WINDOW OPENING. WOOD WINDOW TRIM TO REMAIN

-PROVIDE 1/2" MOISTURE **RESISTANT GYPSUM** BOARD AS INDICATED.

–EXISTING TRIM TO REMAIN. PROVIDE NEW WOOD BASE WHERE REQUIRED TO MATCH EXISTING IN KIND



WEST ELEVATION

-REMOVE PROTECTIVE COVER FROM WINDOW OPENING.

-PROVIDE 1/2" MOISTURE RESISTANT GYPSUM BOARD AS INDICATED.

-PROVIDE NEW WOOD BASE WHERE REQUIRED TO MATCH EXISTING IN KIND

-EXISTING STAIR WALL

TO REMAIN

-REMOVE PAINTED PLASTER OR DRYWALL FROM CEILING. TAKE CARE TO NOT DAMAGE EXISTING FLOOR JOISTS. PROVIDE 1/2" MOISTURE RESISTANT GYPSUM BOARD

-EXISTING PLASTER TO BE CAREFULLY REMOVED SO AS TO LEAVE LATH IN PLACE. PROVIDE 1/2" MOISTURE **RESISTANT GYPSUM** BOARD ON ALL WALLS IN FOYER AREA.

-REMOVE STEEL DOOR AND FRAME

-EXISTING TRIM TO REMAIN, PROVIDE NEW WOOD BASE WHERE **REQUIRED TO MATCH** EXISTING IN KIND



BENEATH STAIR

REMOVE FAUX WOOD PANELING, TYP.

REMOVE PROTECTIVE COVER FROM WINDOW OPENING. EXISTING WOOD WINDOW TRIM AND APRON TO REMAIN

REMOVE DAMAGED WOOD LATH

EXISTING WOOD DOOR, FRAME AND TRIM TO REMAIN




WEST ELEVATION

-REFER TO SHEET 16 of 29 FOR FIREBOX DETAILS

-PROVIDE 1/2" MOISTURE RESISTANT GYPSUM BOARD ON ALL WALLS IN PARLOR. PAINT WITH HISTORICALLY ACCURATE COLOR AND FINISH. **REFER TO FINISH** SCHEDULE FOR DETAILS

	DEPART	MENT OF I	PUBLIC \	VORKS	
DATE	APPROVED	DATE	SCALE:	AS SHOWN	WILSON HOUSE RESTORATION
			DRAWN BY:	A.D.M.	HOT SOX FIELD AT WILSON PARK
	PROJECT MANAGER		CHECKED BY:	B.P.F.	
DATE	APPROVED	DATE	SHEET NO.	14 of 29	INTERIOR ELEVATIONS
			PROJECT NO.:	P573200	
ER	CHIEF, RIGHT-OF-WAY		CONTRACT NO .:	P573201	
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	NO.	DESCRIPTION	BY	DATE	_
		100% SUBMISSION		08/01/24	APPROVED
prepared or sed State of <u>1/26/24</u>					APPROVED ASSISTANT CHIEF ENGINEER

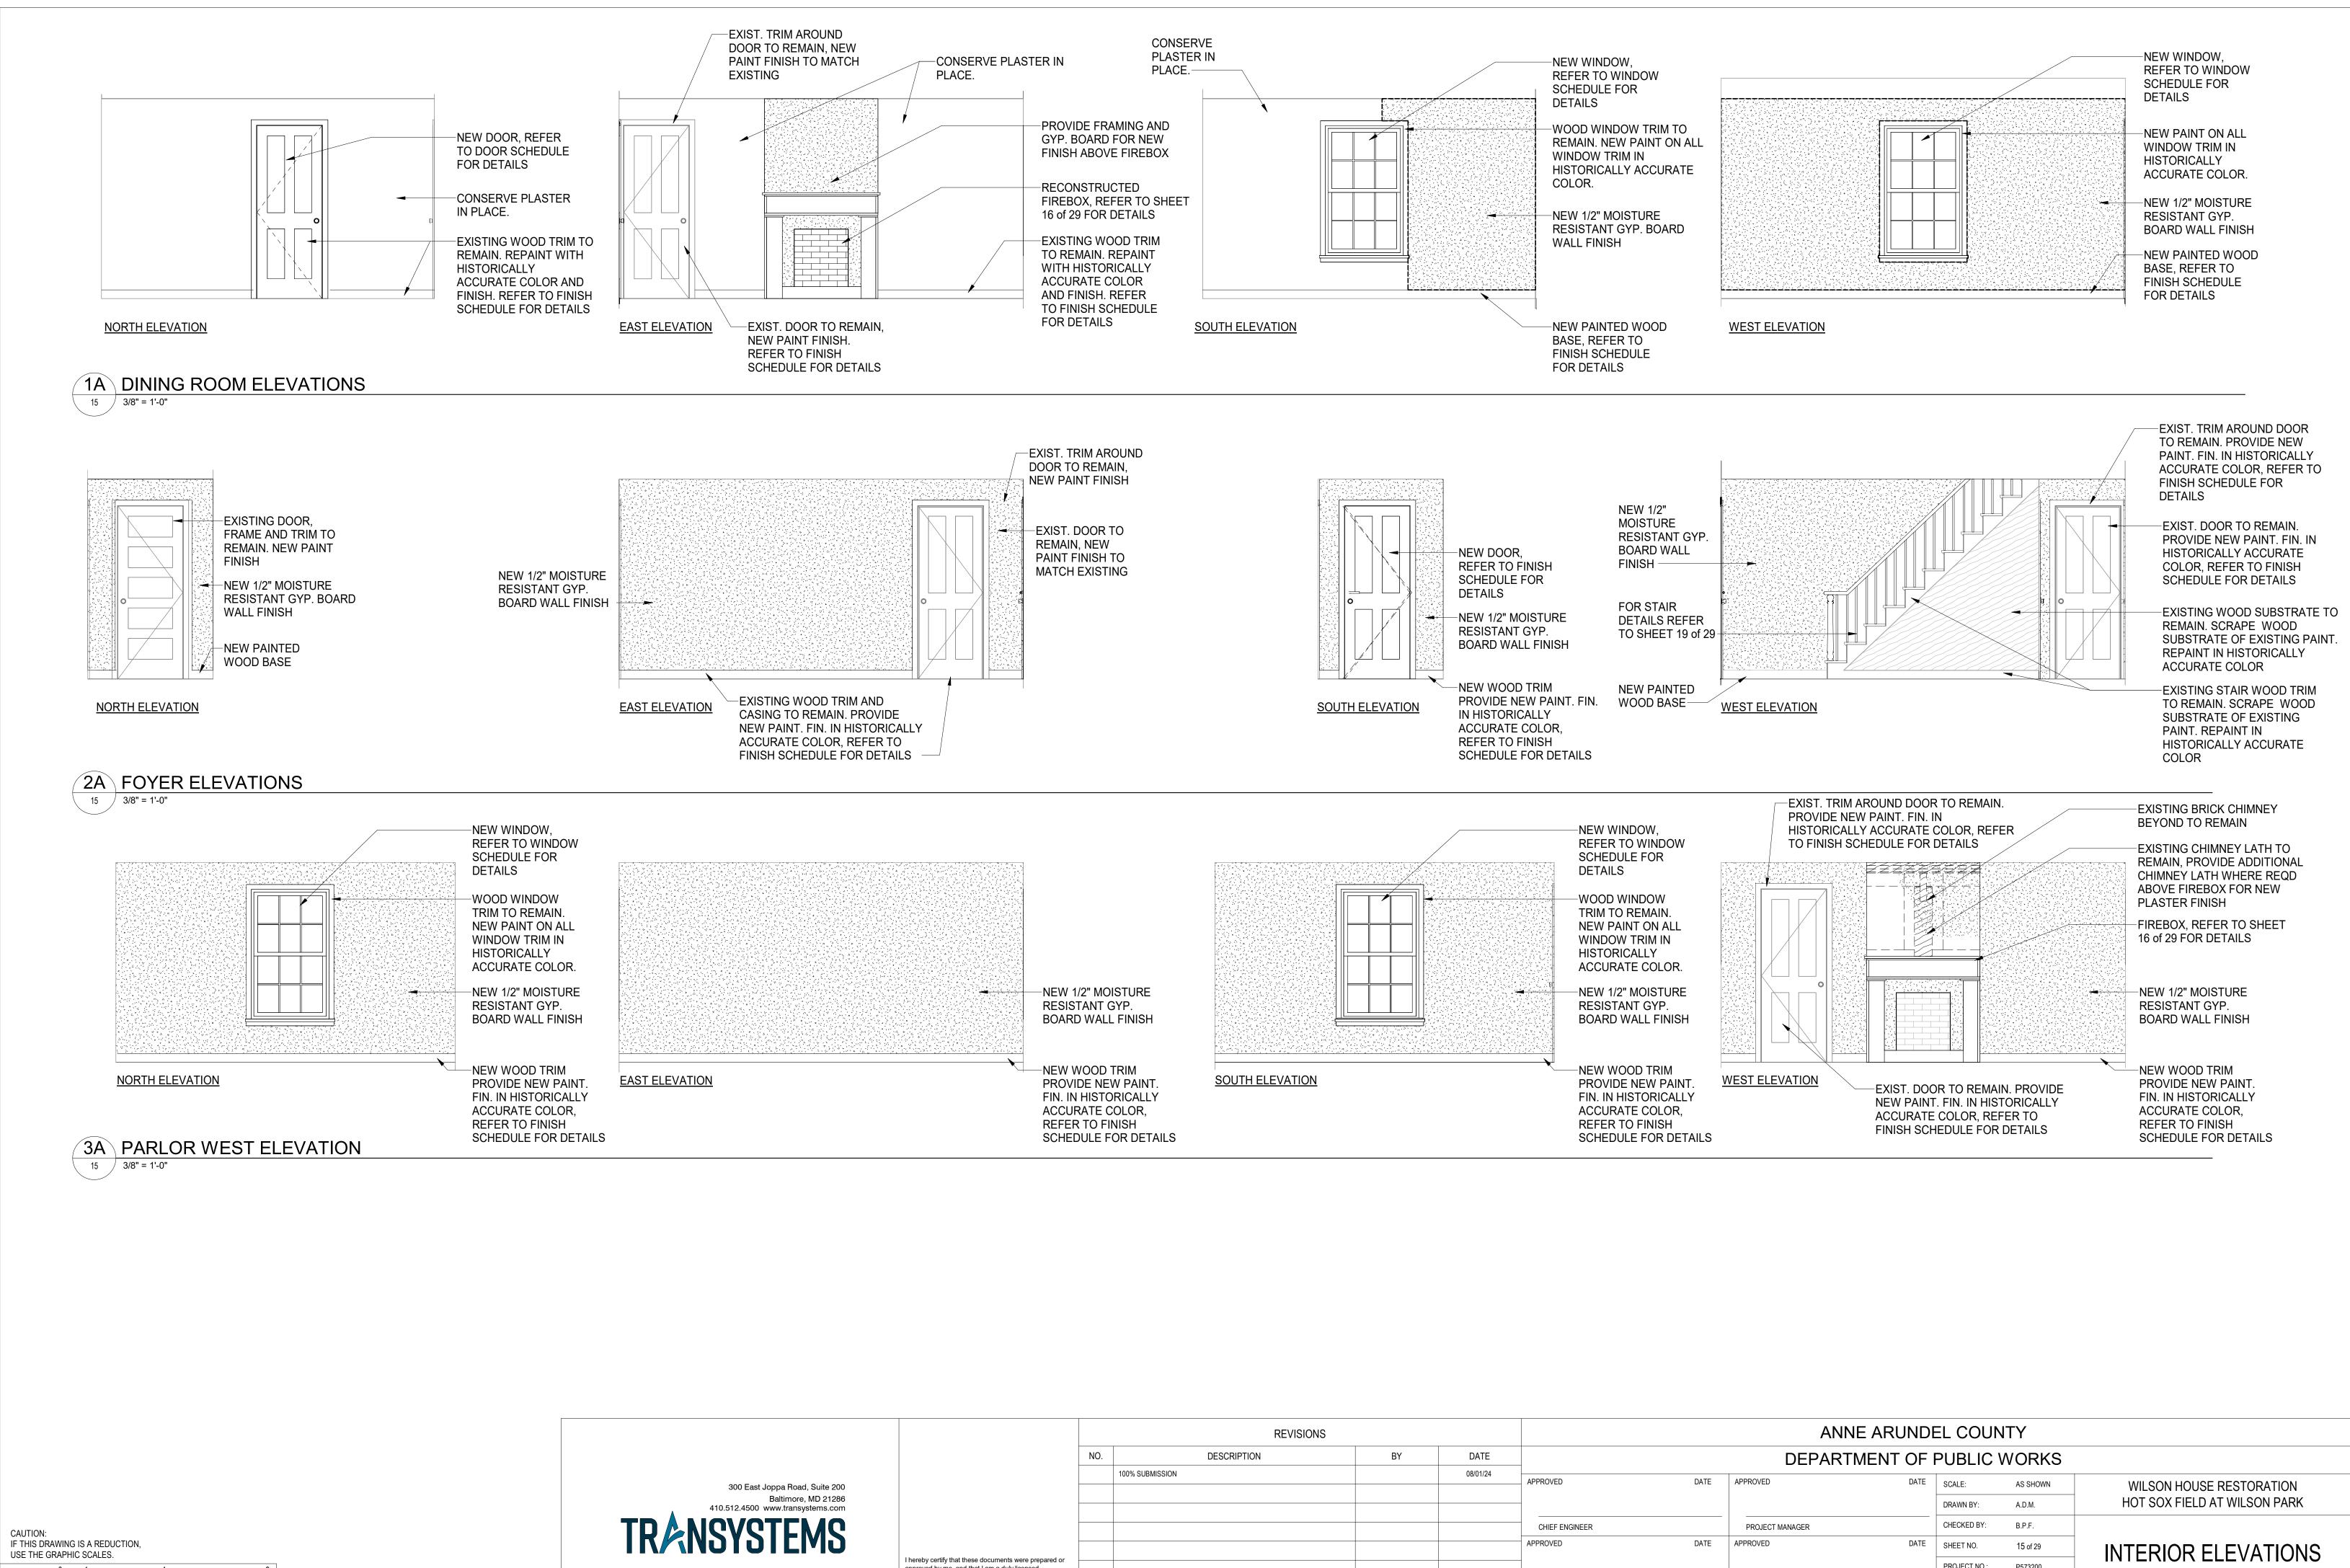approved by me, and that I am a duly licens professional architect under the laws of the Maryland. License # 15613 Expiration Date: 1

3/8"=1'-0'

		DEPART	MENT OF	PUBLIC V	VORKS	
DATI	A	PPROVED	DATE	SCALE:	AS SHOWN	WILSON HOUSE RESTORATION
				DRAWN BY:	A.D.M.	HOT SOX FIELD AT WILSON PARK
		PROJECT MANAGER		CHECKED BY:	B.P.F.	
DATI	A	PPROVED	DATE	SHEET NO.	15 of 29	INTERIOR ELEVATIONS
				PROJECT NO.:	P573200	
ER		CHIEF, RIGHT-OF-WAY		CONTRACT NO.:	P573201	

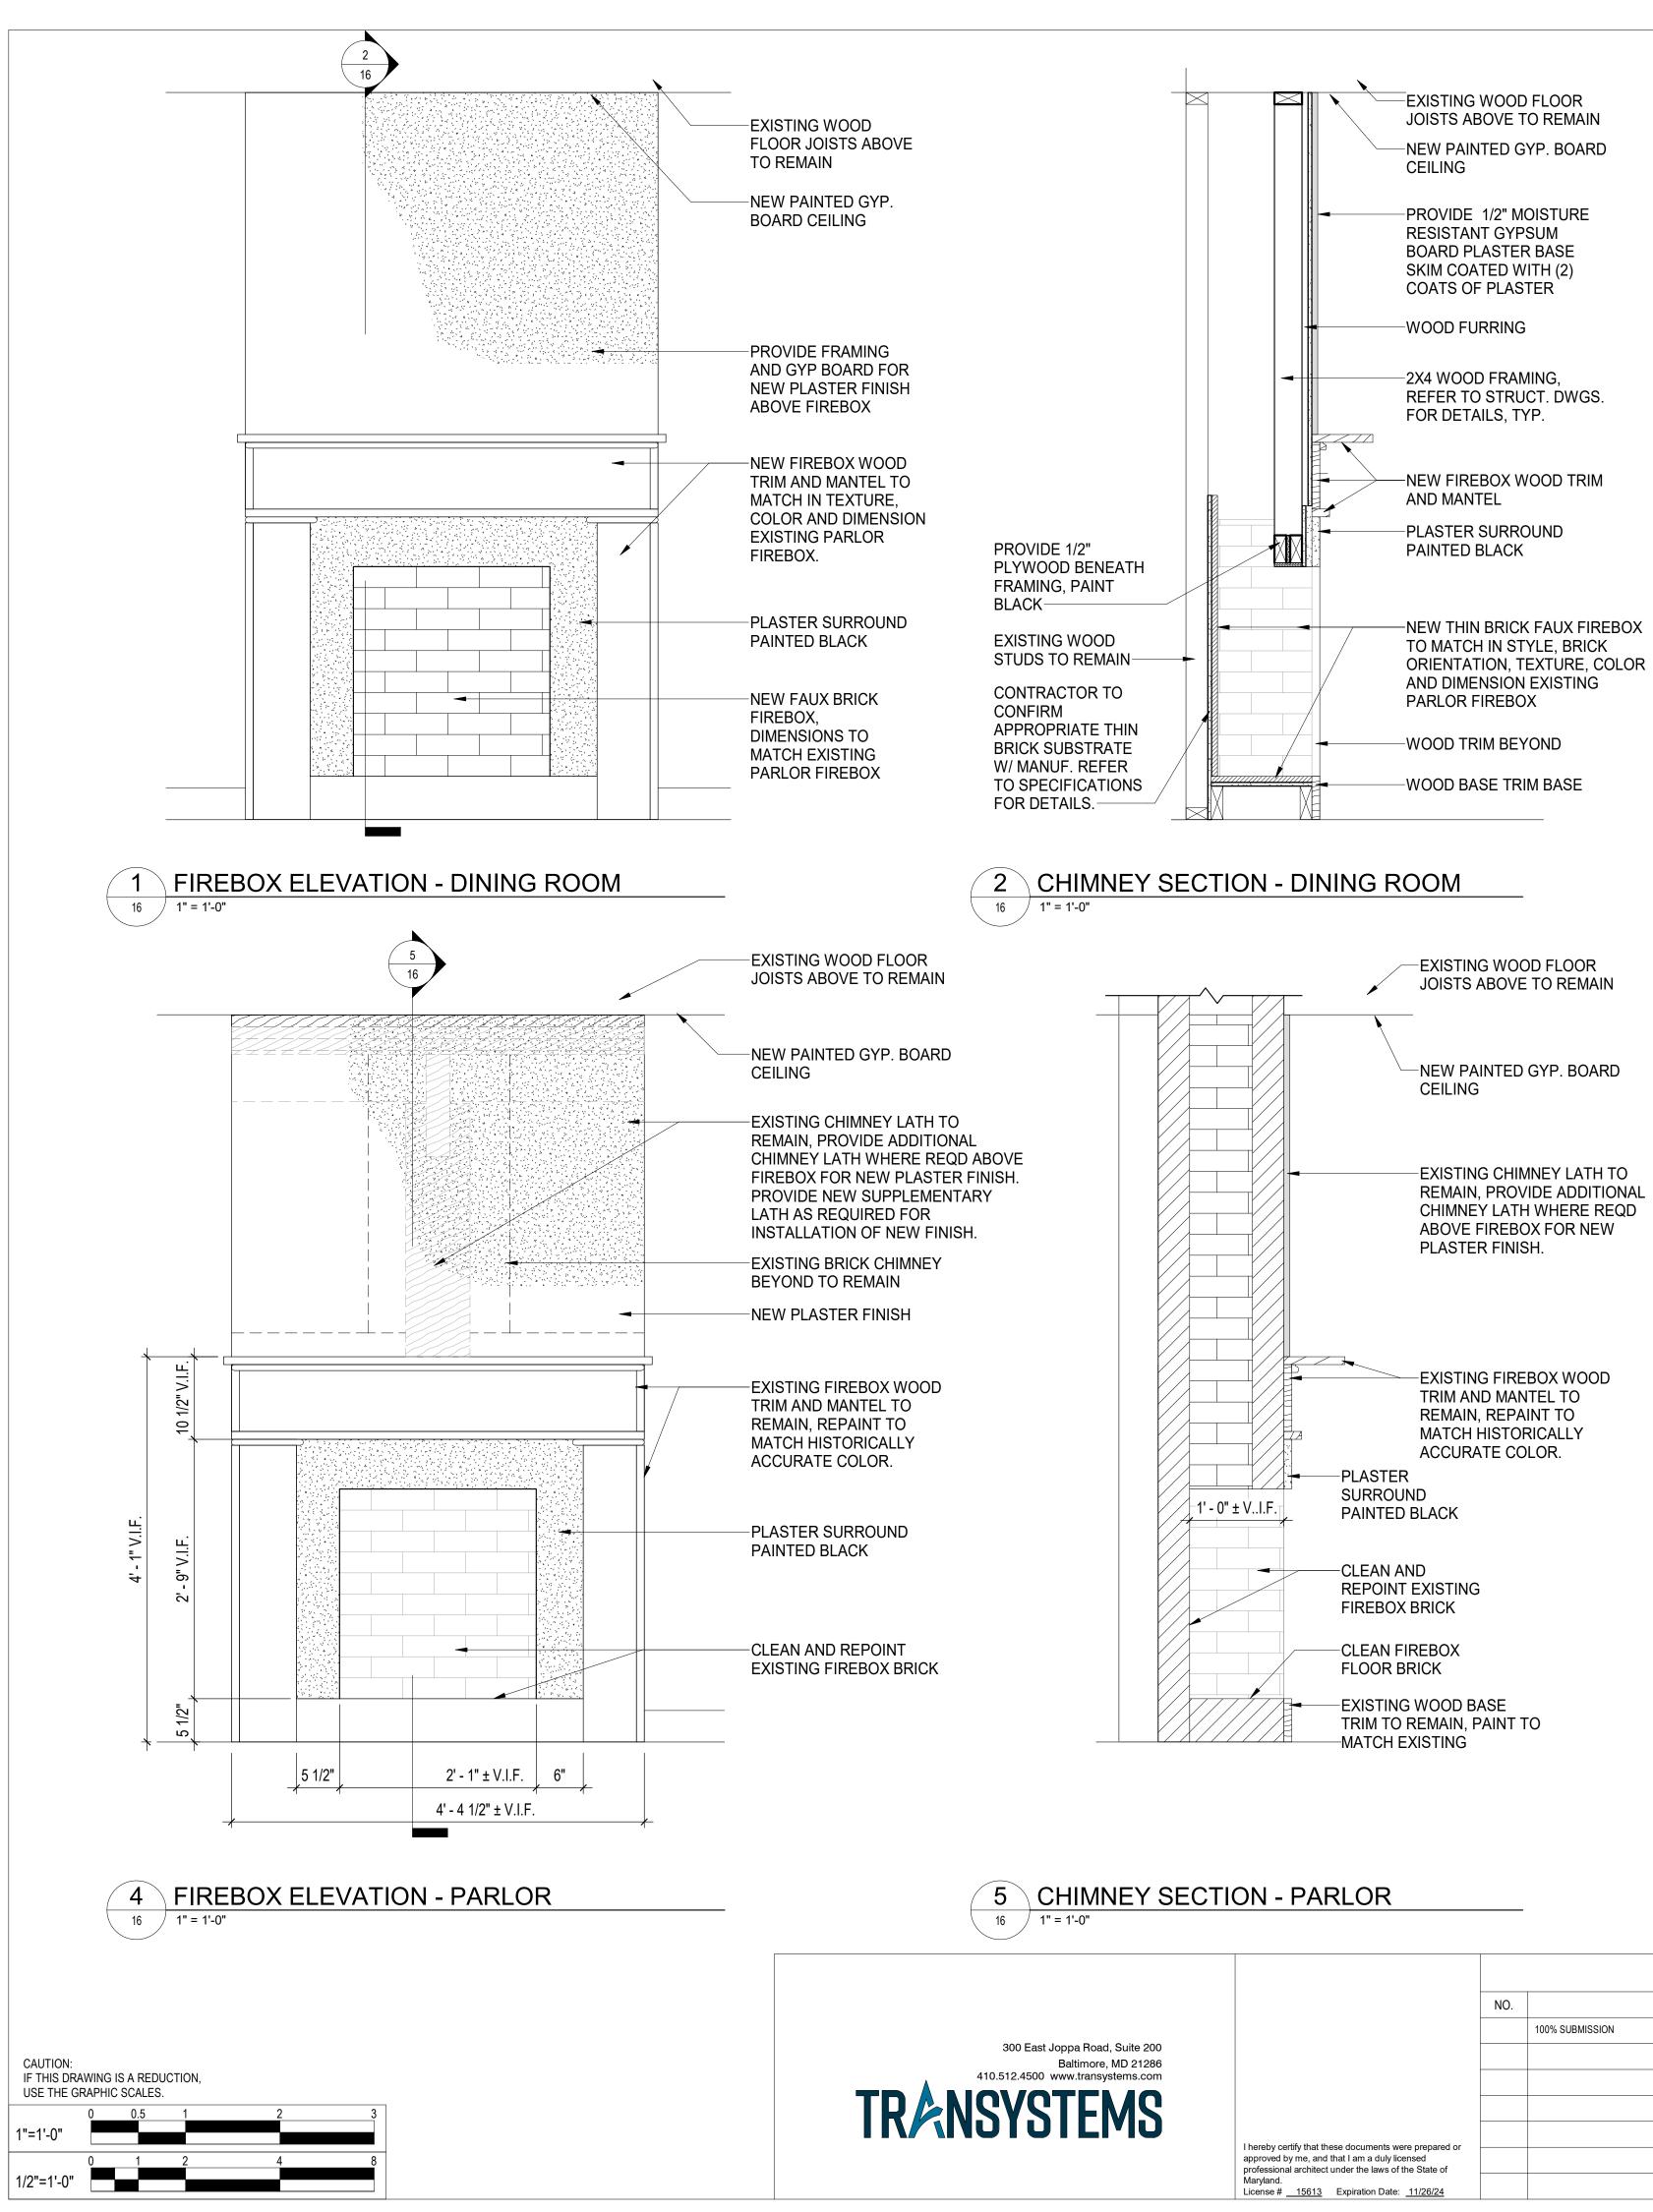




PHOTO - DINING ROOM FIREBOX 3 \ 16 / N.T.S. NOTE: PHOTO DEPICTS EXISTING CONDITION OF FIREBOX

IN DINING ROOM FOR REFERENCE.

-PROVIDE PLASTER ON EACH SIDE OF CHIMNEY

-EXISTING CHIMNEY LATH TO REMAIN, PROVIDE ADDITIONAL CHIMNEY LATH WHERE REQD ABOVE FIREBOX FOR NEW PLASTER FINISH. PROVIDE NEW SUPPLEMENTARY LATH AS **REQUIRED FOR INSTALLATION** OF NEW FINISH.

-EXISTING FIREBOX WOOD TRIM AND MANTEL TO REMAIN, REPAINT TO MATCH EXISTING COLOR AND FINISH

	NO.	DESCRIPTION	BY	DATE	
		100% SUBMISSION		08/01/24	APPROVED
					CHIEF ENGINEER
					APPROVED
ments were prepared or a duly licensed e laws of the State of					
ion Date: <u>11/26/24</u>					ASSISTANT CHIEF ENGINEE

6 PHOTO - PARLOR FIREBOX 16 N.T.S.

-REMOVE EXISTING FRAMING. PROVIDE NEW FRAMING AS INDICATED

GENERAL NOTES

- DRAWINGS FOR FIREPLACE ARE DIAGRAMMATIC AND INTENDED TO IDENTIFY TYPICAL FIREPLACE COMPONENTS. MATERIALS, DIMENSIONS, AND CONFIGURATIONS VARY AND SHOULD BE VERIFIED PRIOR TO BEGINNING WORK.
- FIREPLACE WORK IS INTENDED TO RESTORE HISTORIC APPEARANCE BUT 2. NOT RETURN FIRE PLACE TO OPERABLE CONDITION.
- DEMOLITION OF EXISTING INTERIOR FINISHES MAY REVEAL ADDITIONAL 3 INFORMATION ABOUT THE CHIMNEYS AND FIREPLACES THAT HISTORICALLY EXISTED IN THIS LOCATION. SHOULD EVIDENCE OF THE PREVIOUS CONSTRUCTION BE REVEALED, THE CONTRACTOR SHALL NOTIFY THE ARCHITECT AND CLIENT PRIOR TO COMMENCING OR CONTINUING WORK ON THE CHIMNEY.
- DINING ROOM FIREBOX TRIM TO MATCH EXISTING PARLOR TRIM IN 4 TEXTURE, COLOR AND DIMENSION. CONTRACTOR TO VERIFY DIMENSIONS OF PARLOR FIREBOX AND TRIM AND NOTIFY ARCHITECT OF ANY DISCREPANCIES.
- FOR NEW GYPSUM BOARD CEILINGS PROVIDE MOISTURE RESISTANT GYPSUM BOARD.

-EXISTING WOOD STUDS TO REMAIN

-EXISTING WOOD FLOOR JOISTS ABOVE TO REMAIN

-EXISTING BRICK CHIMNEY BEYOND TO REMAIN

-CLEAN AND REPOINT EXISTING FIREBOX BRICK




-EXISTING WOOD TRIM ON PARLOR FIREBOX TO REMAIN. CONTRACTOR TO MATCH NEW DINING ROOM TRIM DIMENSIONS AND PROFILES TO EXISTING PARLOR TRIM



ANNE ARUNDEL COUNTY

DEDARTMENT OF DURUC WORKS

	DATE	APPROVED	DATE	SCALE:	AS SHOWN	WILSON HOUSE RESTORATION
				DRAWN BY:	A.D.M.	HOT SOX FIELD AT WILSON PARK
		PROJECT MANAGER		CHECKED BY:	B.P.F.	
	DATE	APPROVED	DATE	SHEET NO.	16 of 29	
				PROJECT NO.:	P573200	FIREBOX DETAILS
IEER		CHIEF, RIGHT-OF-WAY		CONTRACT NO.:	P573201	

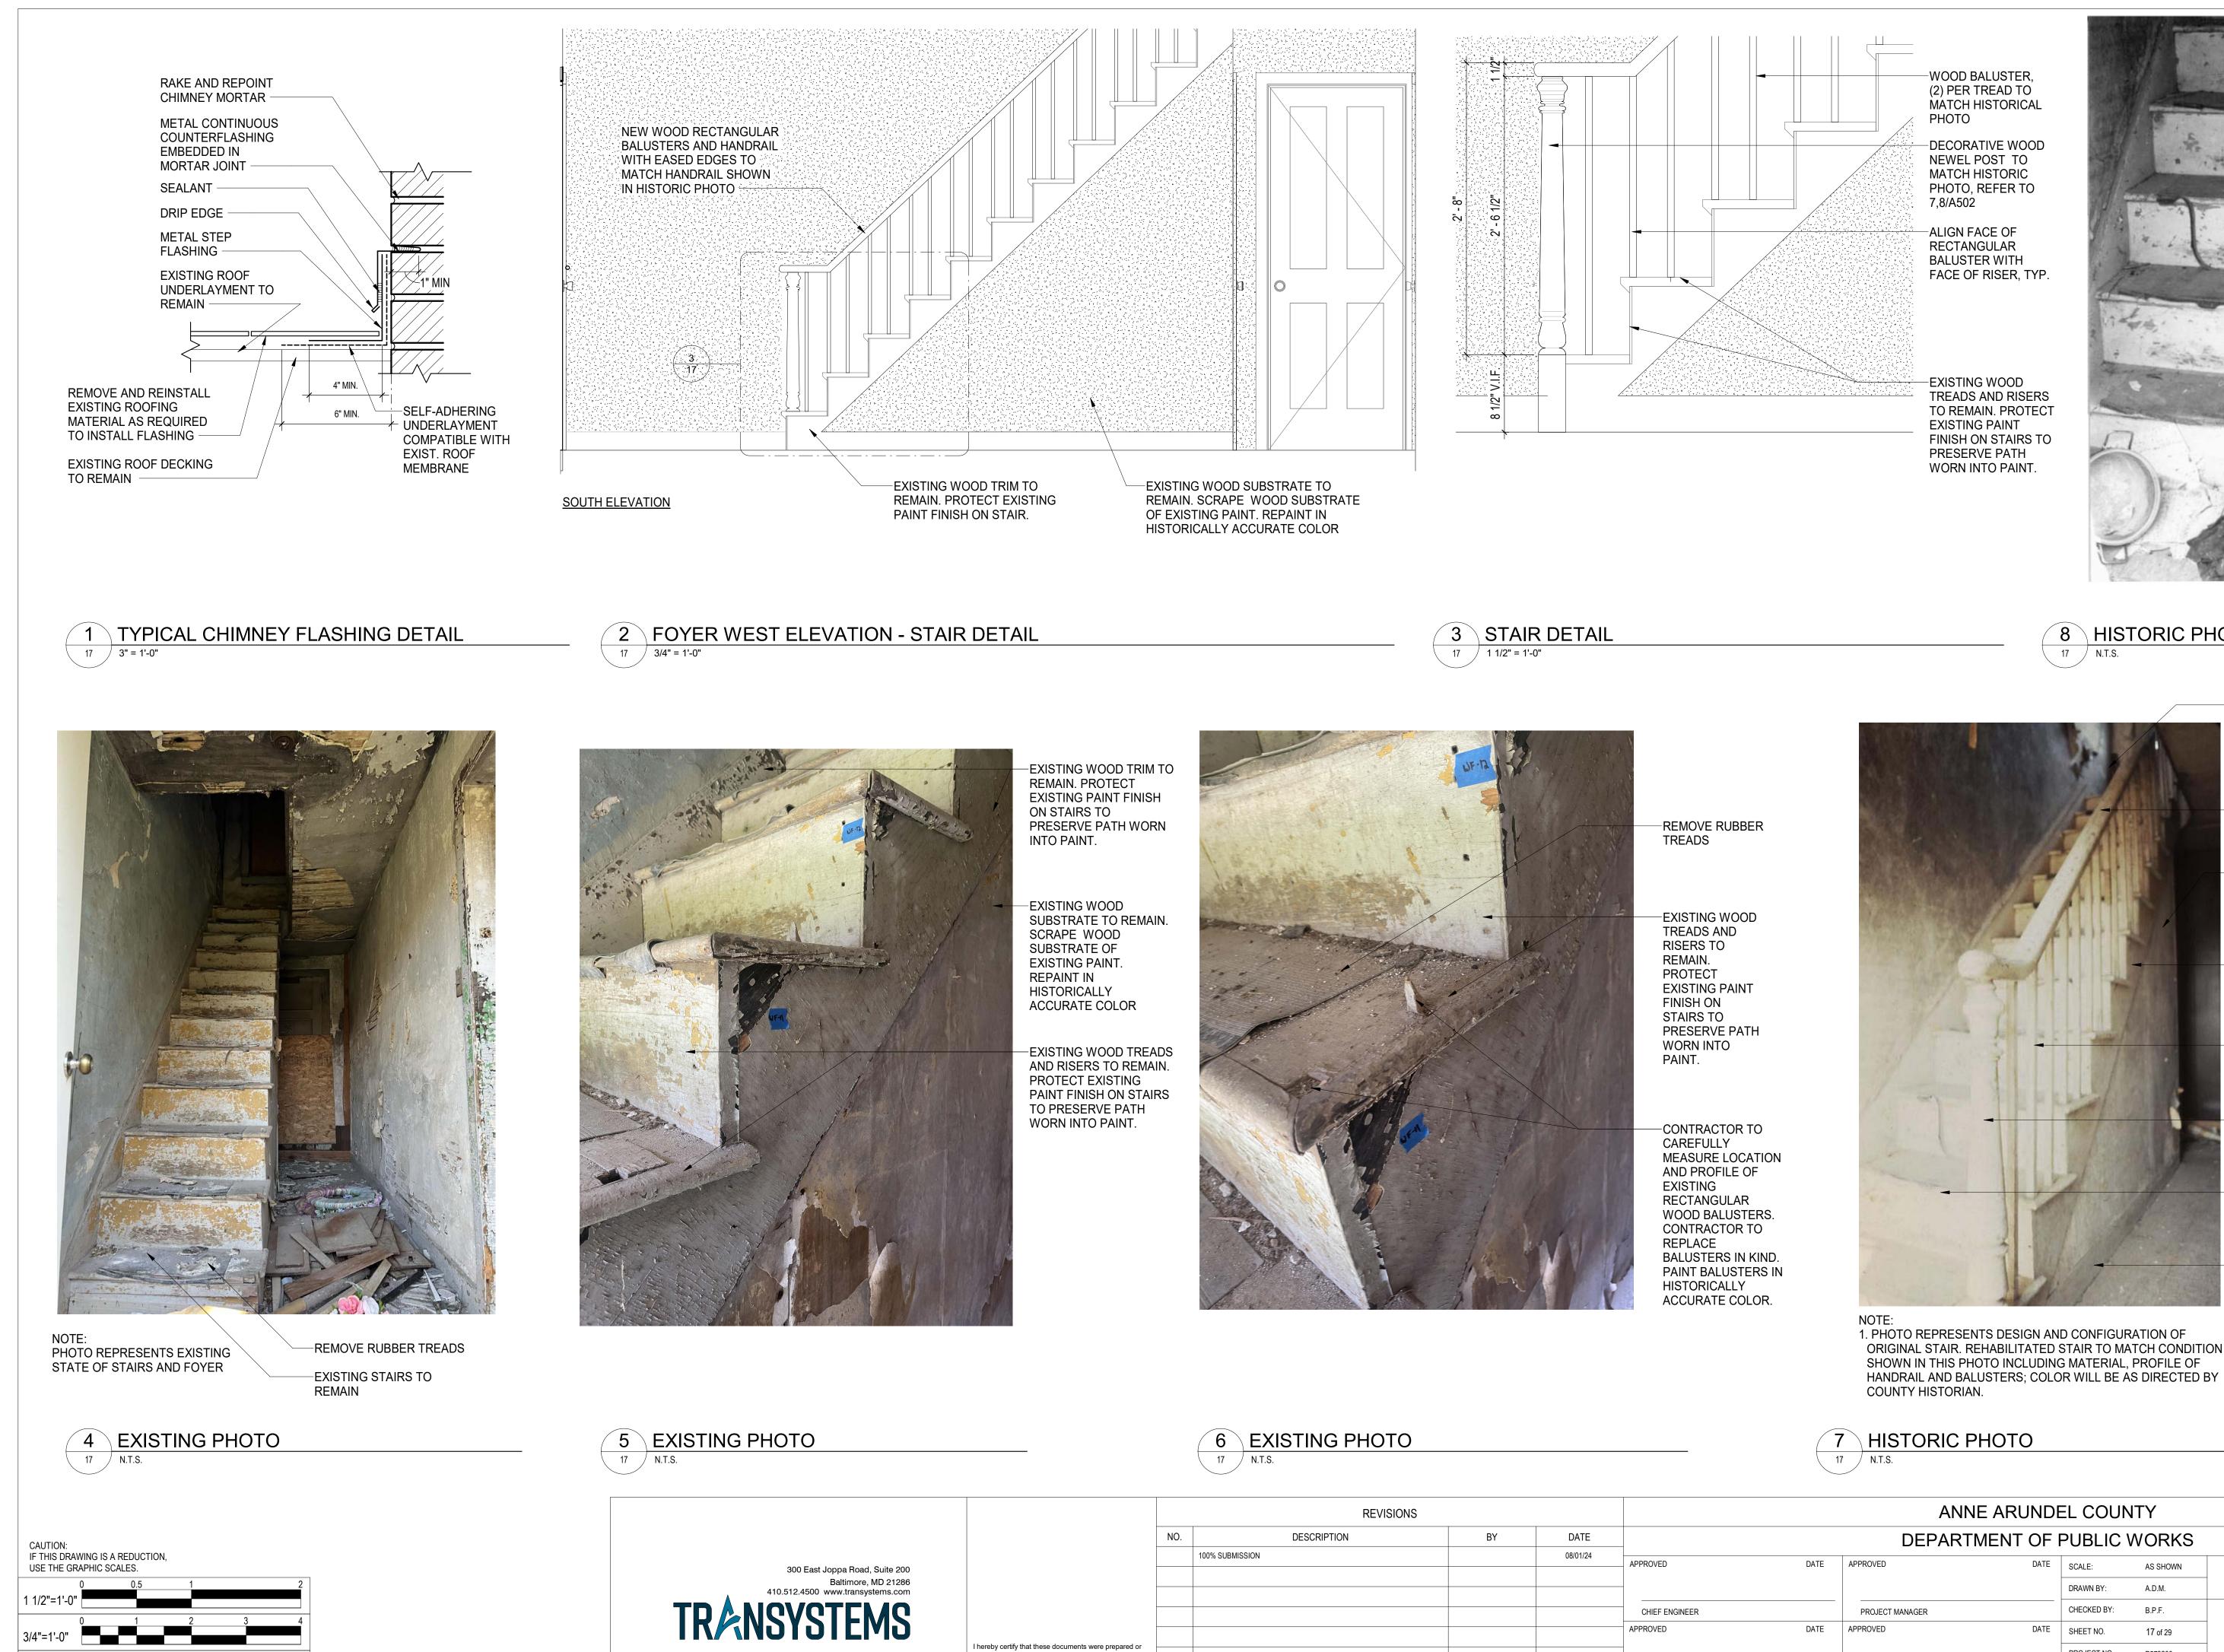

		REVISIONS			
	NO.	DESCRIPTION	BY	DATE	
		100% SUBMISSION		08/01/24	APPROVED
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					CHIEF ENGINEER
					APPROVED
re prepared or ensed he State of					
11/26/24					ASSISTANT CHIEF ENGINEE

I hereby certify that these documents were approved by me, and that I am a duly licens professional architect under the laws of the Maryland. License # <u>15613</u> Expiration Date:

3"=1'-0'





-AREA OF WORK ENDS AT SECOND FLOOR LEVEL

-PROVIDE NEW WOOD HANDRAIL, PAINT IN HISTORICALLY ACCURATE COLOR.

-EXISTING WOOD WALL SUBSTRATE TO REMAIN. SCRAPE WOOD SUBSTRATE OF EXISTING PAINT. REPAINT IN HISTORICALLY ACCURATE COLOR

-EXISTING WOOD TRIM TO REMAIN. PROTECT EXISTING PAINT FINISH ON STAIR.

-PROVIDE NEW WOOD RECTANGULAR BALUSTERS, PAINT IN HISTORICALLY ACCURATE COLOR

PROVIDE NEW WOOD NEWEL POST, PAINT IN HISTORICALLY ACCURATE COLOR

-PROTECT EXISTING PAINT FINISH ON STAIRS TO PRESERVE PATH WORN INTO PAINT.

-WOOD BASE TO REMAIN

	DEPARTMENT OF PUBLIC WORKS										
	DATE	APPROVED	DATE	SCALE:	AS SHOWN	WILSON HOUSE RESTORATION					
				DRAWN BY:	A.D.M.	HOT SOX FIELD AT WILSON PARK					
		PROJECT MANAGER		CHECKED BY:	B.P.F.						
	DATE	APPROVED	DATE	SHEET NO.	17 of 29	DETAILS					
				PROJECT NO.:	P573200	DETAILS					
R		CHIEF, RIGHT-OF-WAY		CONTRACT NO .:	P573201						
						© TRANSYSTEMS 2024					

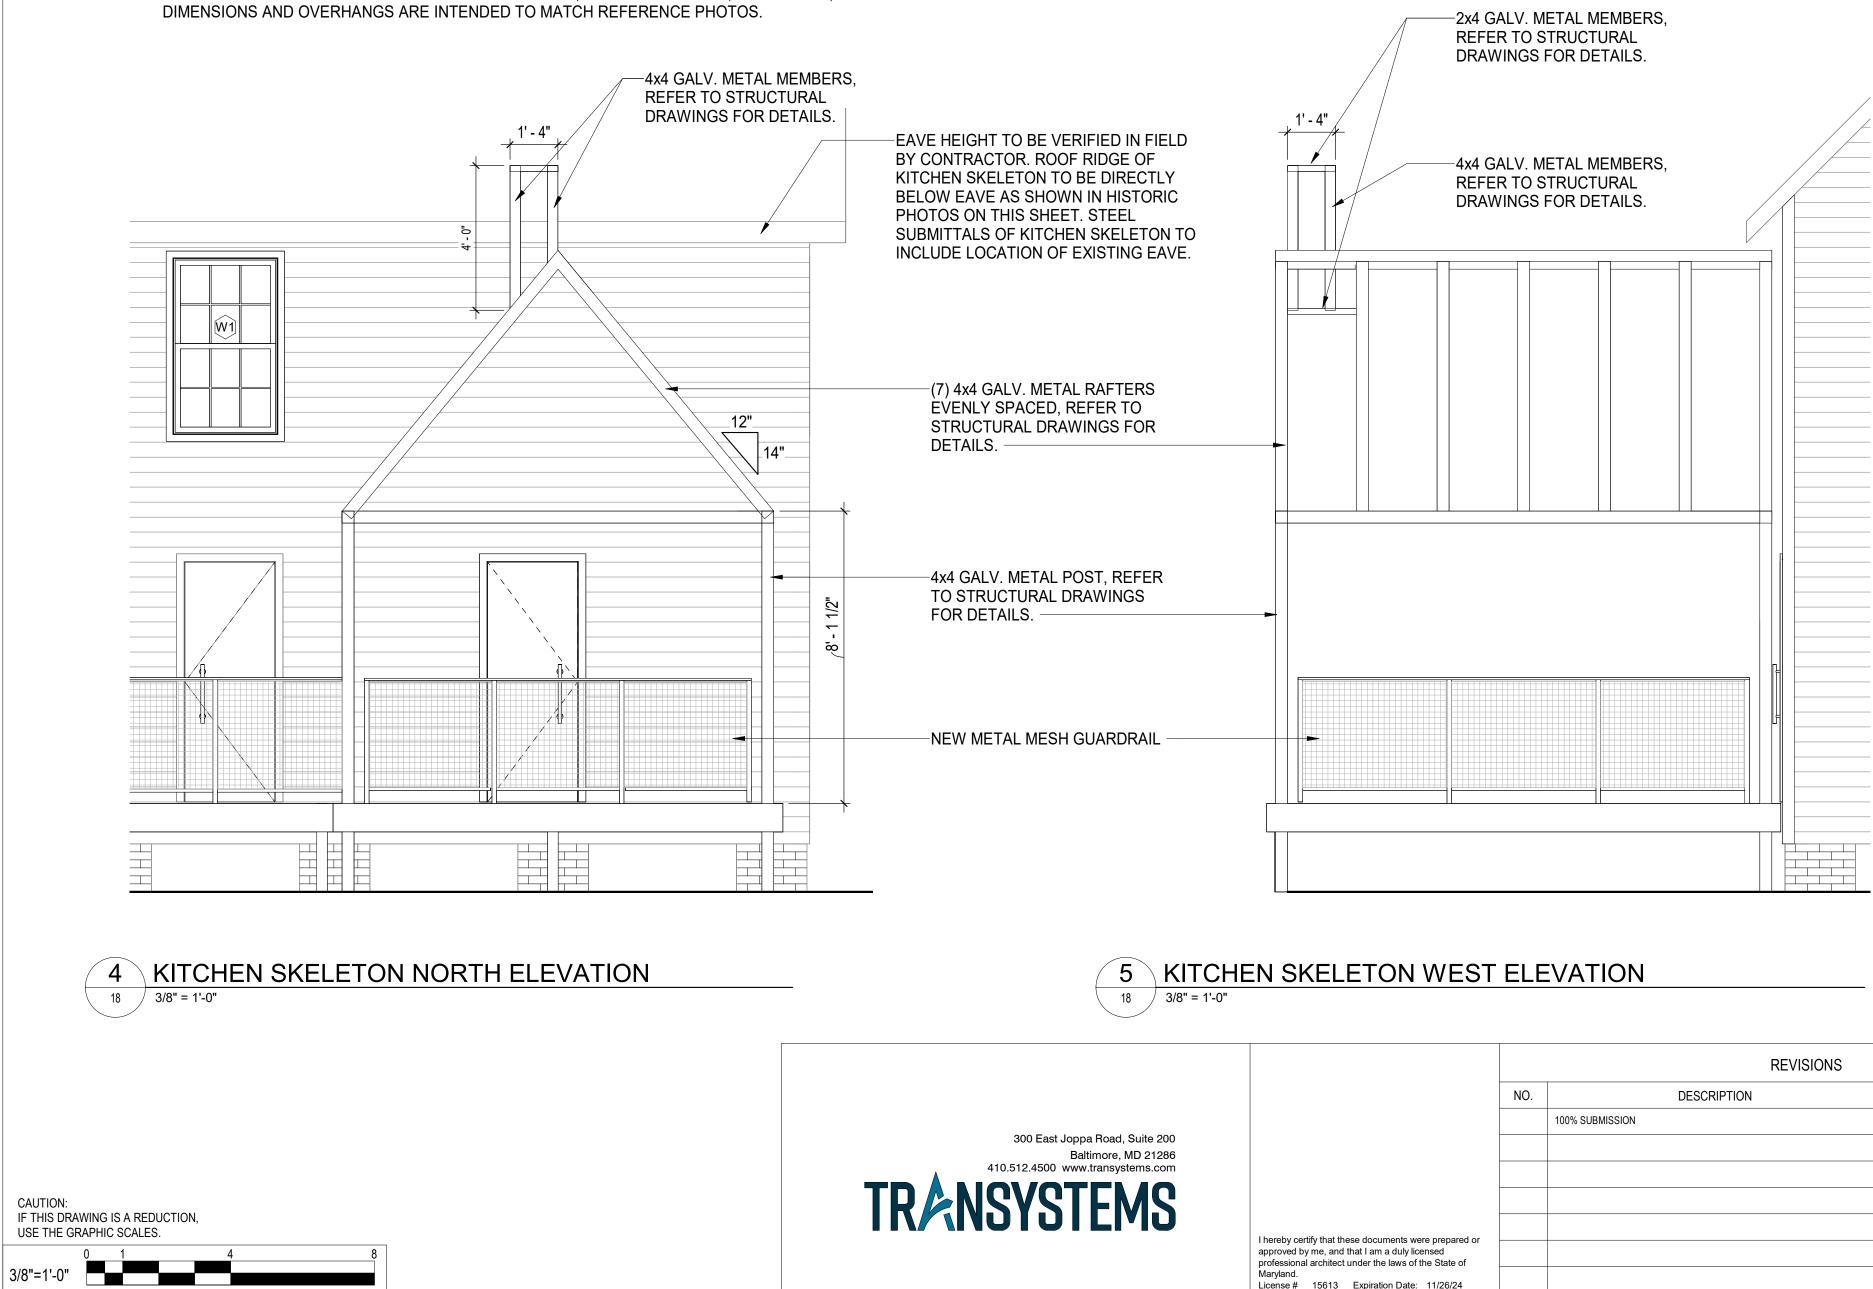




3/8"=1'-0"

1. HISTORIC PHOTOS FOUND ON THIS SHEET ARE FOR REFERENCE ONLY.

2. KITCHEN SKELETON DETAILED ON THIS SHEET IS INTENDED TO OUTLINE THE KITCHEN SHOWN IN THESE PHOTOGRAPHS. KITCHEN SKELETON, INCLUDING HEIGHT, ROOF PITCH, DIMENSIONS AND OVERHANGS ARE INTENDED TO MATCH REFERENCE PHOTOS.












NOTES:


2. AFTER REMOVING EXISTING SIDING, IF ANY KITCHEN FRAMING IS EXPOSED, NOTIFY ARCHITECT IMMEDIATELY. KITCHEN SKELETON BASED OFF OF EXISTING DOCUMENTS AND PHOTOS. EDGE OF KITCHEN SKELETON TO ALIGN WITH EDGE OF EXISTING EXTERIOR FRAMING.

		REVISIONS		ANNE ARUNDEL COUNTY									
	NO.	DESCRIPTION	BY	DATE		DEPARTMENT OF PUBLIC WORKS							
-	100%	SUBMISSION		08/01/24	APPROVED	DATE	APPROVED	DATE	SCALE: AS SHOWN		WILSON HOUSE RESTORATION		
_							DRAWN BY:	A.D.M.	HOT SOX FIELD AT WILSON PARK				
_					CHIEF ENGINEER		PROJECT MANAGER		CHECKED BY:	B.P.F.			
_					APPROVED	DATE	APPROVED DATE	DATE	SHEET NO.	18 of 29	KITCHEN SKELETON		
nts were prepared or uly licensed ws of the State of									PROJECT NO.:	P573200	DETAILS		
ion Date: <u>11/26/24</u>					ASSISTANT CHIEF ENGINEER		CHIEF, RIGHT-OF-WAY		CONTRACT NO.: P573201				
											© TRANSYSTEMS 20		

I hereby certify that these doc approved by me, and that I a professional architect under t Maryland. License # <u>15613</u> Expire

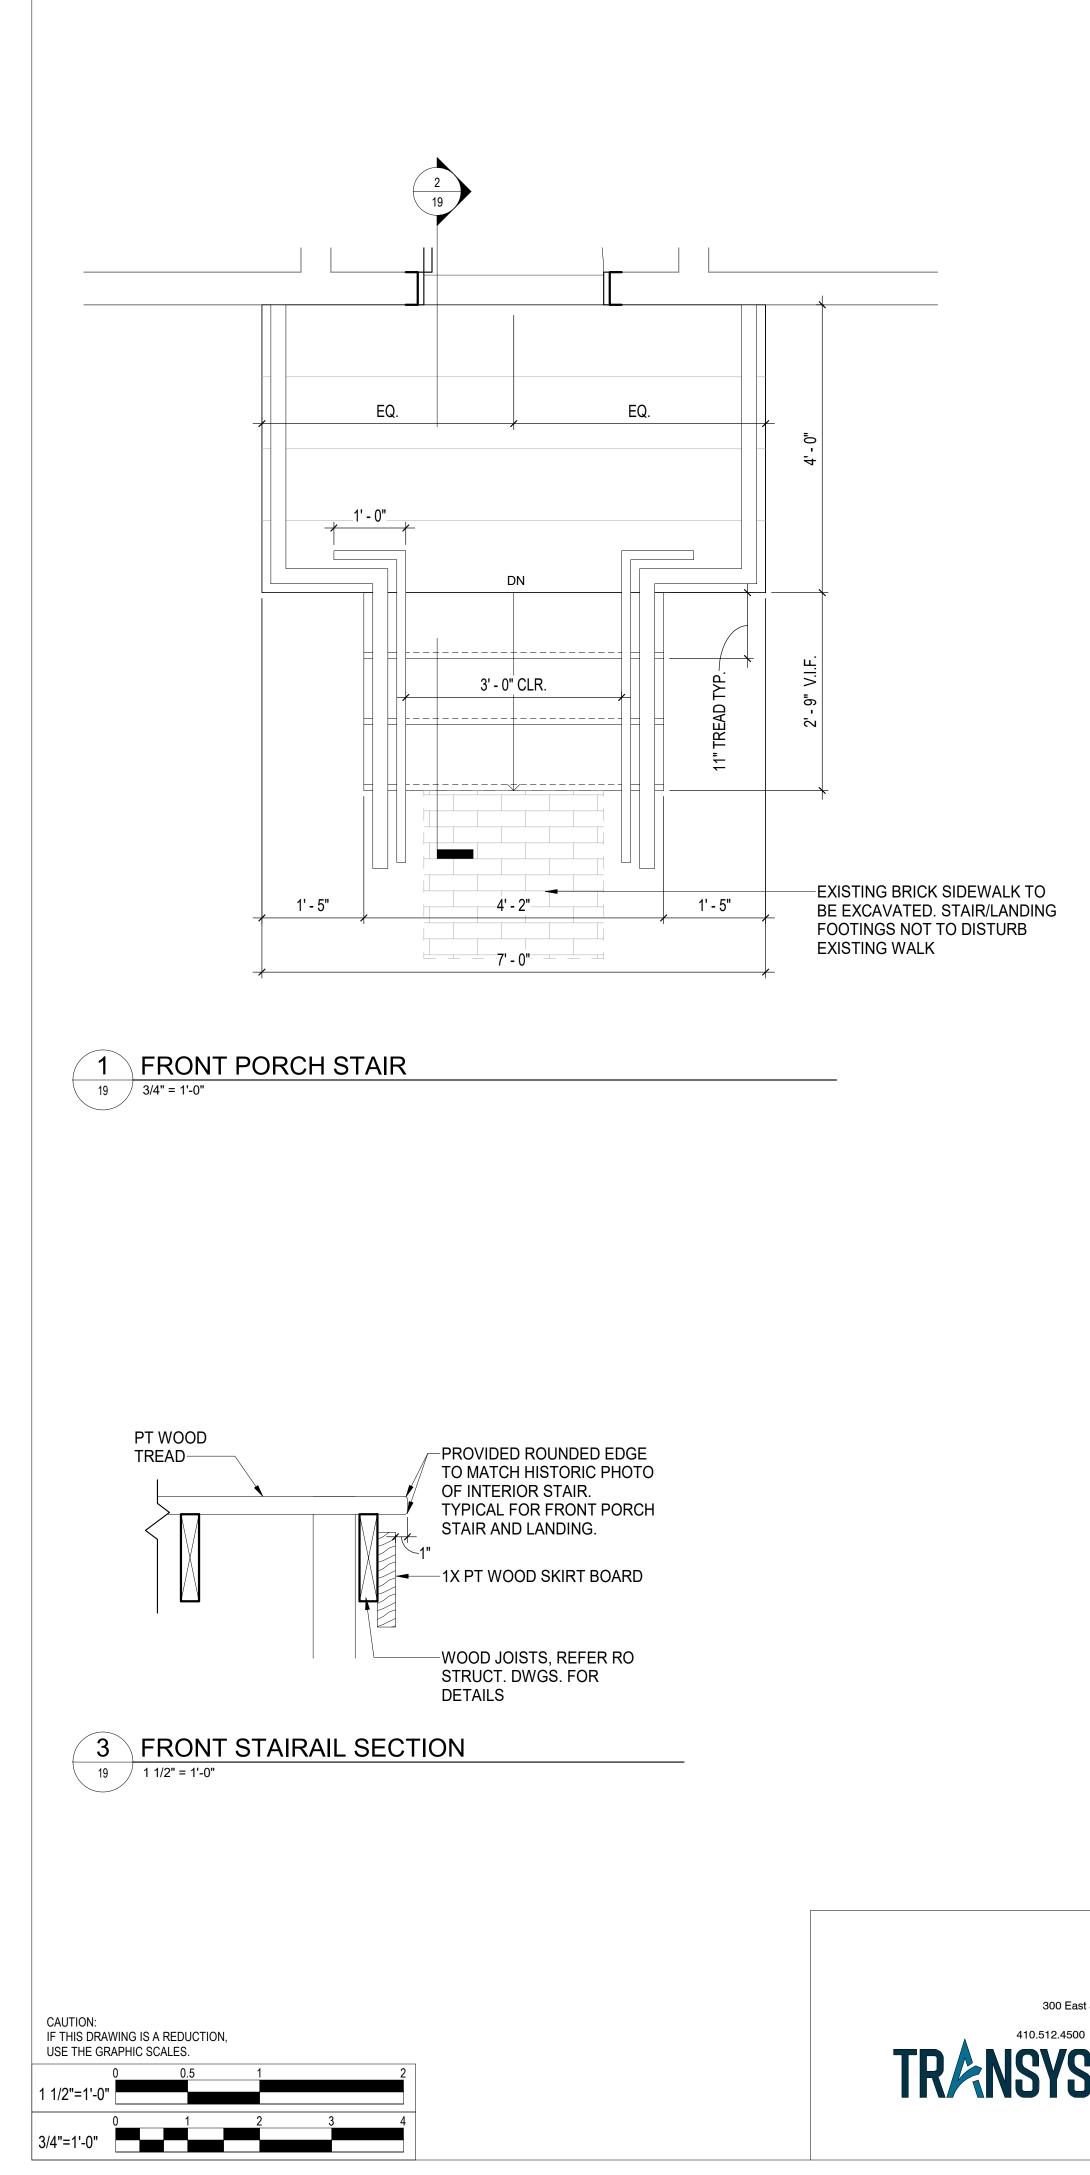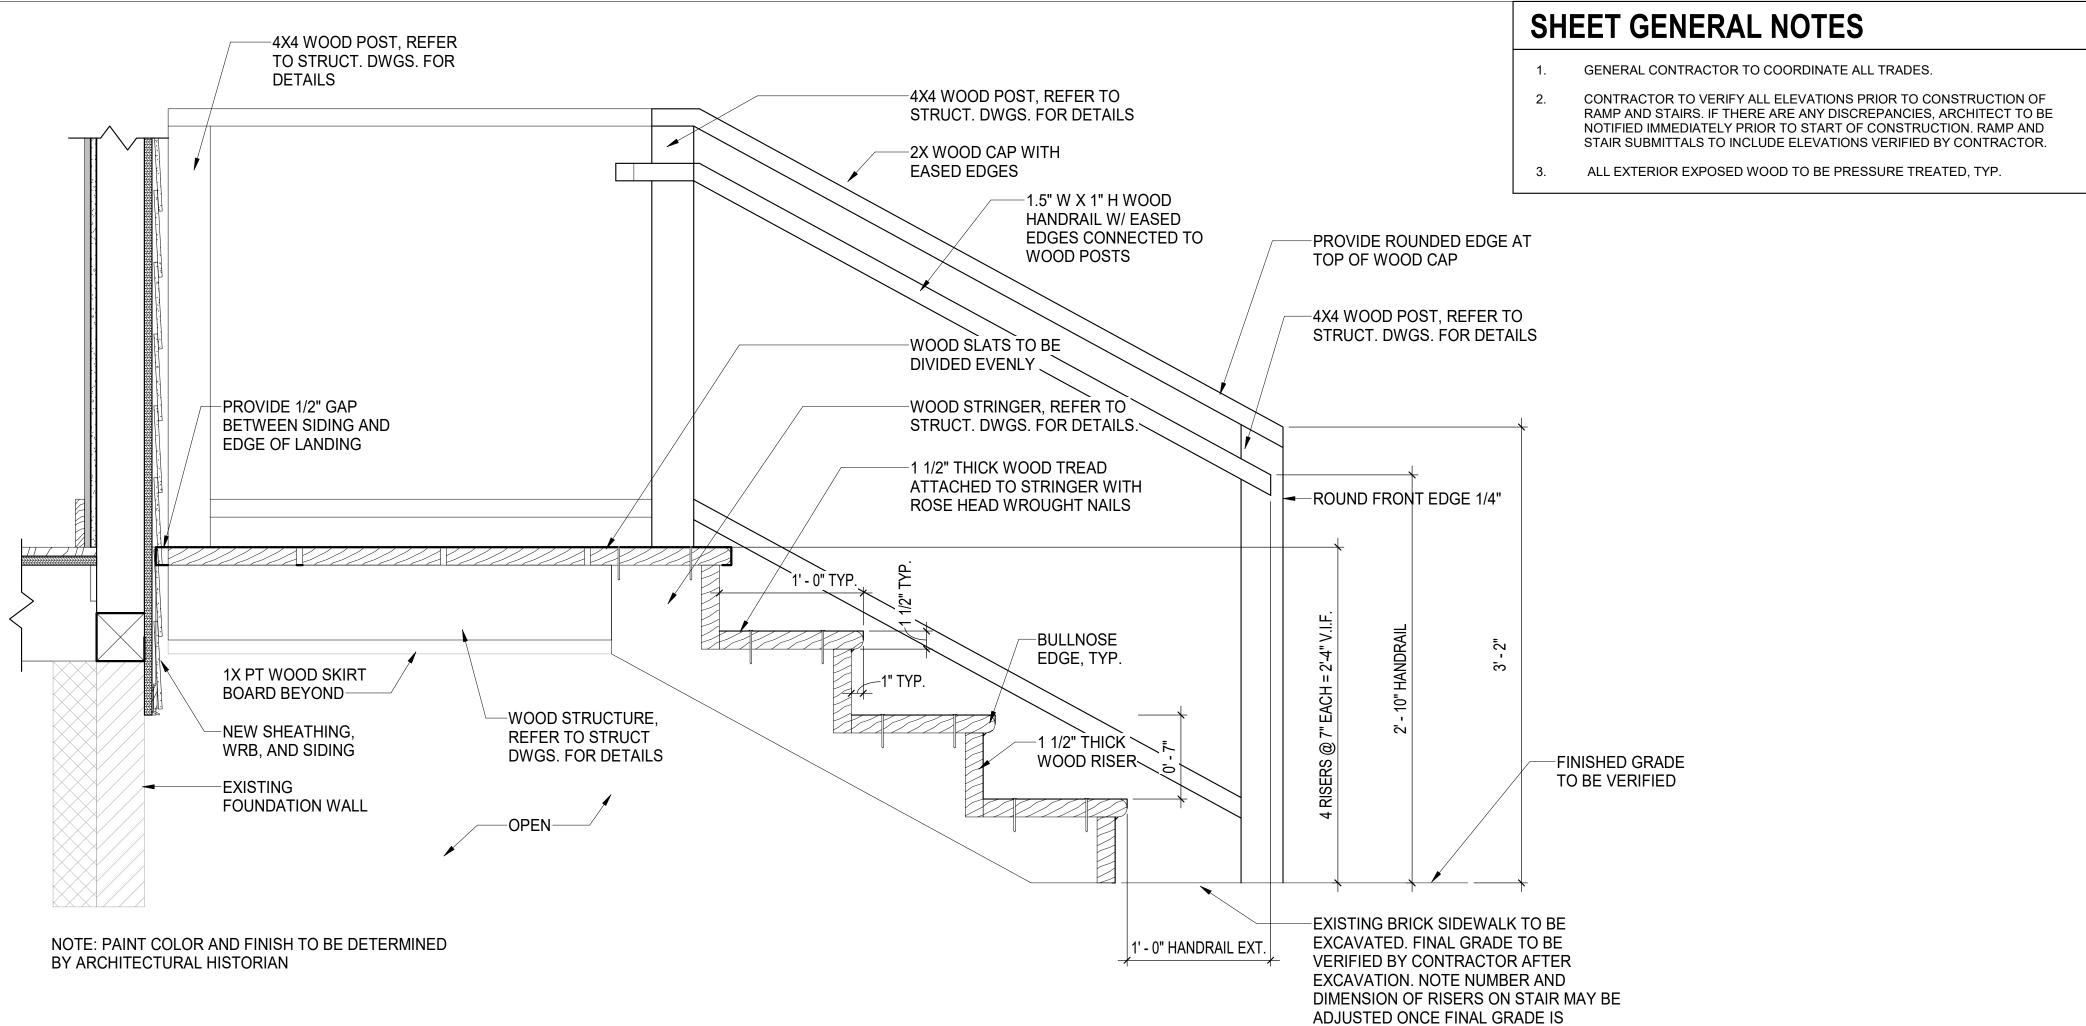1. KITCHEN SKELETON COMPONENTS TO BE GALV. AND PAINTED.











		REVISIONS								
	NO.	DESCRIPTION	BY							
		100% SUBMISSION		08/01/24	APPROVED					
					CHIEF ENGINEER					
					APPROVED					
I hereby certify that these documents were prepared or approved by me, and that I am a duly licensed professional architect under the laws of the State of										
Maryland. License # <u>15613</u> Expiration Date: <u>11/26/24</u>					ASSISTANT CHIEF ENGINEER					

ANNE ARUNDEL COUNTY

DETERMINED. NEW STAIR FOOTINGS NOT TO DISTURB EXISTING BRICK SIDEWALK.

	DEPARTMENT C	DF I	PUBLIC V	VORKS	
DATE	APPROVED D	DATE	SCALE:	AS SHOWN	WILSON HOUSE RESTORATION
			DRAWN BY:	A.D.M.	HOT SOX FIELD AT WILSON PARK
	PROJECT MANAGER		CHECKED BY:	B.P.F.	
DATE	APPROVED D	DATE	SHEET NO.	19 of 29	STAIR PLAN AND
			PROJECT NO .:	P573200	DETAILS
ER	CHIEF, RIGHT-OF-WAY		CONTRACT NO .:	P573201	

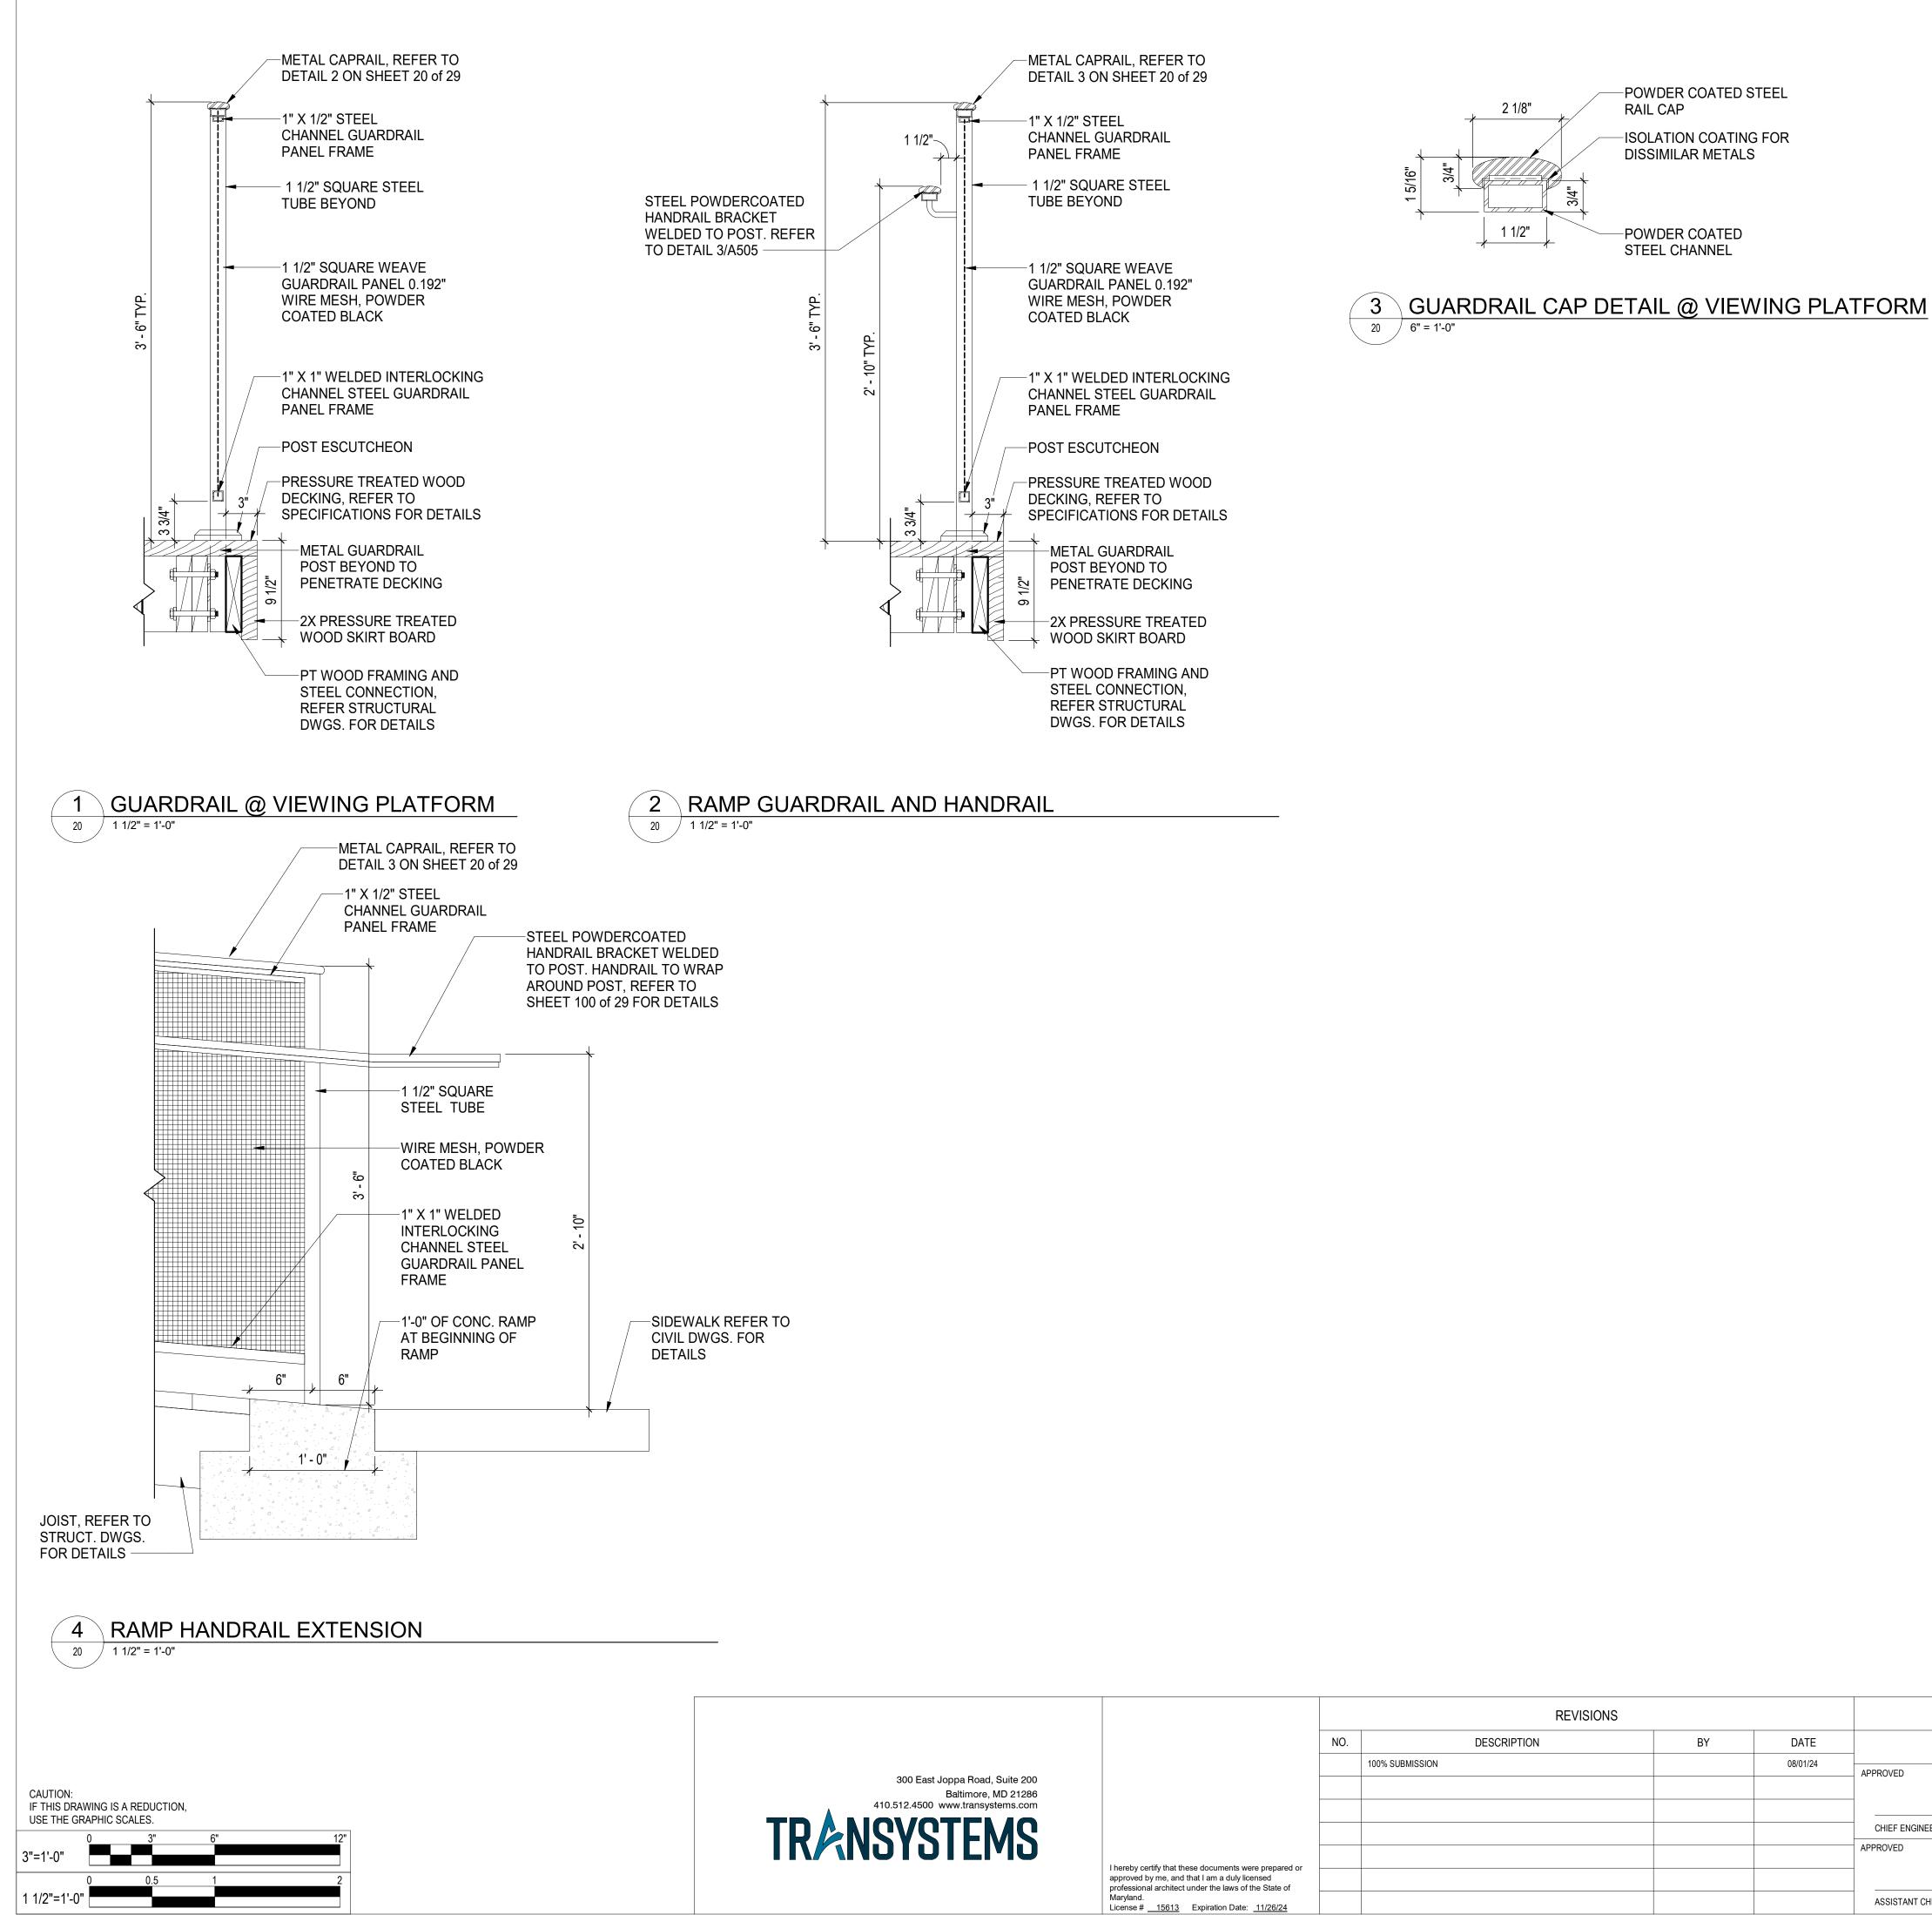

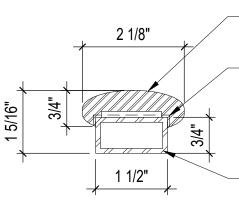

		REVISIONS									
	NO.	DESCRIPTION	BY	DATE							
		100% SUBMISSION		08/01/24	APPROVED						
					CHIEF ENGINEER						
					APPROVED						
ese documents were prepared or that I am a duly licensed under the laws of the State of											
Expiration Date: <u>11/26/24</u>					ASSISTANT CHIEF ENGINEER						

SHEET GENERAL NOTES


- 1. GENERAL CONTRACTOR TO COORDINATE ALL TRADES.
- CONTRACTOR TO VERIFY ALL ELEVATIONS PRIOR TO CONSTRUCTION OF 2. RAMP AND STAIRS. IF THERE ARE ANY DISCREPANCIES, ARCHITECT TO BE NOTIFIED IMMEDIATELY PRIOR TO START OF CONSTRUCTION. RAMP AND STAIR SUBMITTALS TO INCLUDE ELEVATIONS VERIFIED BY CONTRACTOR.
- 3. ALL EXTERIOR EXPOSED WOOD TO BE PRESSURE TREATED, TYP.
- 4. ALL METAL ON GUARDRAIL AND HANDRAIL TO BE POWDERCOATED.

ANNE ARUNDEL COUNTY


DEPARTMENT OF PUBLIC WORKS

DATE	APPROVED	DATE	SCALE:	AS SHOWN	WILSON HOUSE RESTORATION
			DRAWN BY:	A.D.M.	HOT SOX FIELD AT WILSON PARK
	PROJECT MANAGER		CHECKED BY:	B.P.F.	
DATE	APPROVED	DATE	SHEET NO.	20 of 29	RAMP AND VIEWING
			PROJECT NO.:	P573200	PLATFORM DETAILS
	CHIEF, RIGHT-OF-WAY		CONTRACT NO.:	P573201	
			1		© TRANSYSTEMS 2024

									OOR SCH					
DOOR					DOOR	2			F	RAME		DETAILS		_
DOOR #	To Room: Name	STYLE	MATERIAL	HEIGHT	WIDTH	THICKNESS	GLAZING	FINISH	STYLE	MATERIAL	HEAD DETAIL	JAMB DETAIL	THRESHOLD DETAIL	
101	FOYER	A	SCW	6' - 8"	2' - 6"	0' - 1 3/8"	-	PAINT	1	WOOD	5 on 21 of 29	7 on 21 of 29	9 on 21 of 29	EXIST
102	OYER	EXIST.	. EXIST.	6' - 8"	2' - 6"	0' - 1 3/8"	-	PAINT	EXIST.	EXIST.	6 on 21 of 29	8 on 21 of 29	0 10 on 21 of 29	EXIST
103	PARLOR	EXIST	EXIST.	6' - 8"	2' - 6"	0' - 1 3/8"	-	PAINT	EXIST.	EXIST.	-	-	-	EXIST
104	DINING ROOM	EXIST.	. EXIST.	6' - 8"	2' - 6"	0' - 1 3/8"	-	PAINT	EXIST.	EXIST.	-	-	-	EXIST
105	DINING ROOM	A	SCW	6' - 8"	2' - 6"	0' - 1 3/8"	-	PAINT	EXIST.	EXIST.	6 on 21 of 29	8 on 21 of 29	0 10 on 21 of 29	EXIST
106	FOYER	A	SCW	6' - 8"	1' - 6"	0' - 1 3/8"	-	PAINT	1	WOOD				PROV EXIST
107		В	GLASS	6' - 8"	2' - 6"	0' - 0 15/32"	FULL	N/A	2	ALUM.	6 on 21 of 29	8 on 21 of 29)	EXIST DOOR
108		В	GLASS	6' - 8"	2' - 6"	0' - 0 15/32"	FULL	N/A	2	ALUM.	6 on 21 of 29	8 on 21 of 29	0 10 on 21 of 29) EXIST
Grand total	: 8							Fir	nish Sc	hedule				
										inishes			0 "	
													Ceiling	Ce
Number	Name		Floor Finis	sh Ba	se Finis	sh No	orth	Soι	uth	East	W	est	Finish	He
101	FOYER	٦	FBD.	WD).	GYP. E (P-1)		GYP. B (P-1)	BD.	GYP. BD. (P-1)	GYP. (P-1)	-	YP. BD. -3)	EXIST
102	DINING ROOM	٦	ΓBD.	WD).	EXIST BD. (P	-	EXIST/ BD. (P-	-	EXIST/G BD. (P-1)	-	-	YP. BD. -3)	EXIST
103	PARLOR	٦	ΓBD.	WD).	GYP. E (P-1)		GYP. B (P-1)	BD.	GYP. BD. (P-1)	GYP. (P-1)	-	YP. BD. -3)	EXIST

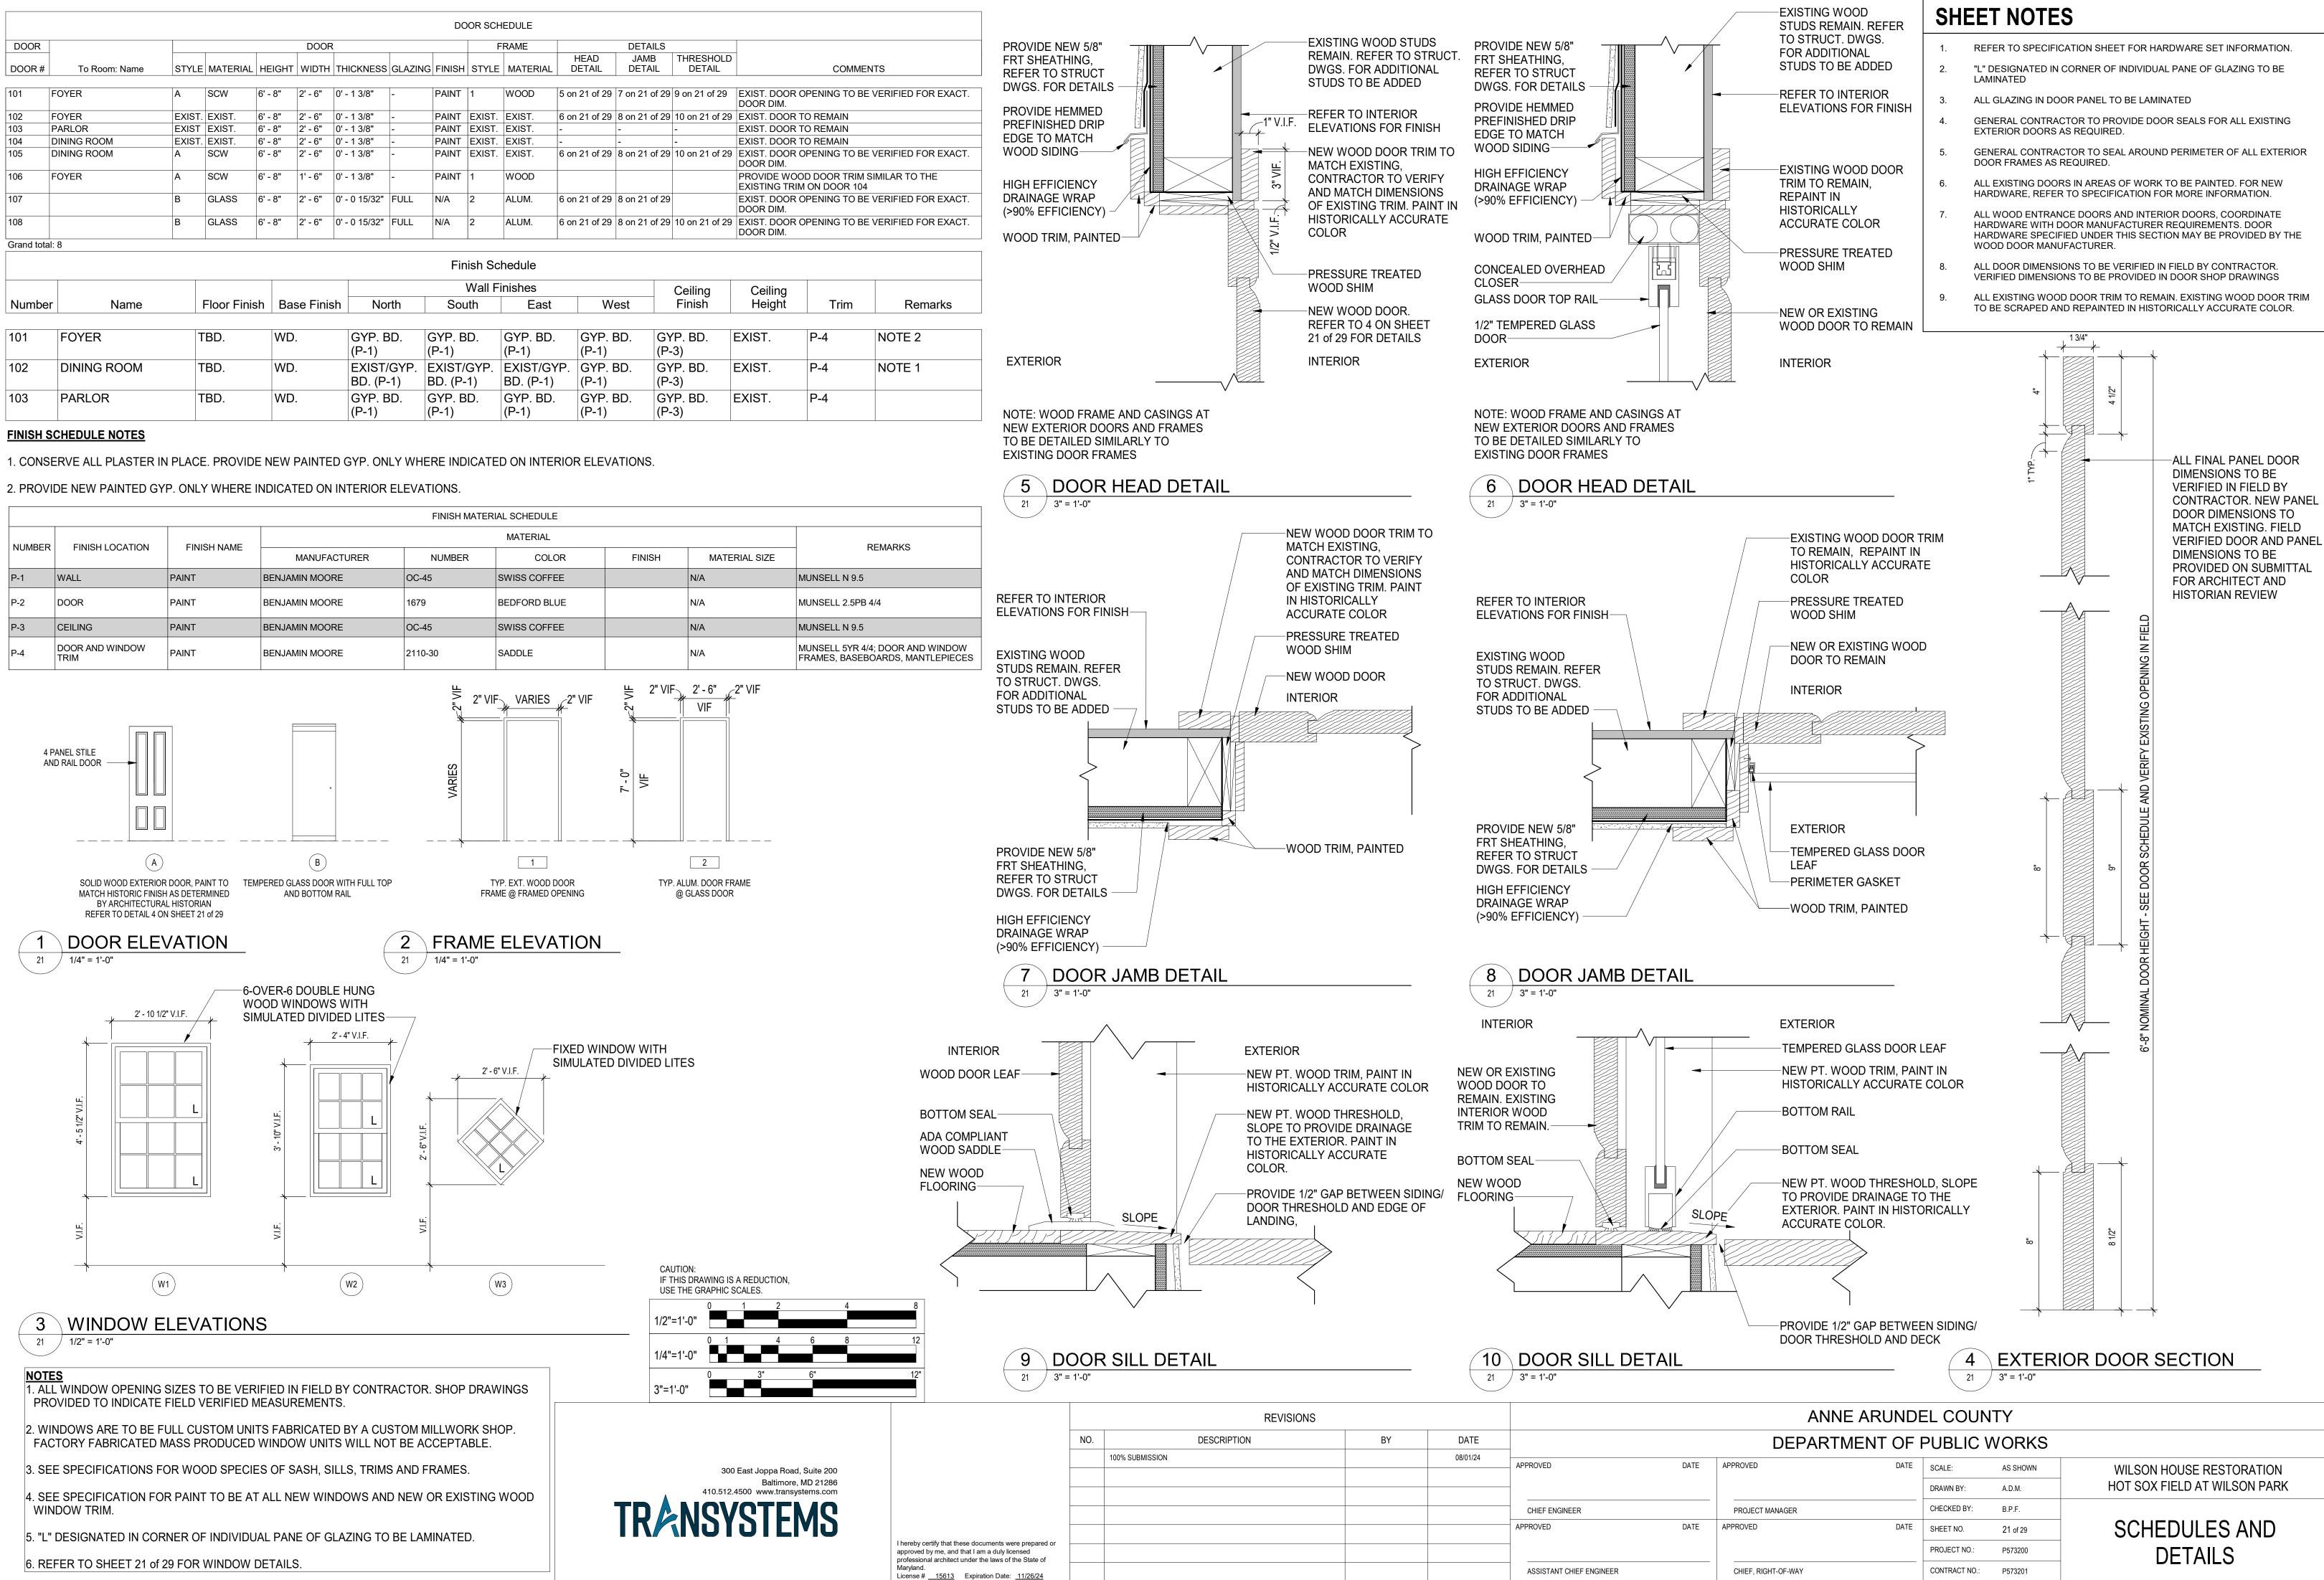

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		REVISIONS			
	NO.	DESCRIPTION	BY	DATE	
		100% SUBMISSION		08/01/24	APPROVED
					_
					CHIEF ENGINEER
nereby certify that these documents were prepared or					APPROVED
proved by me, and that I am a duly licensed ofessional architect under the laws of the State of aryland. cense # <u>15613</u> Expiration Date: <u>11/26/24</u>					ASSISTANT CHIEF ENGINEER
					-

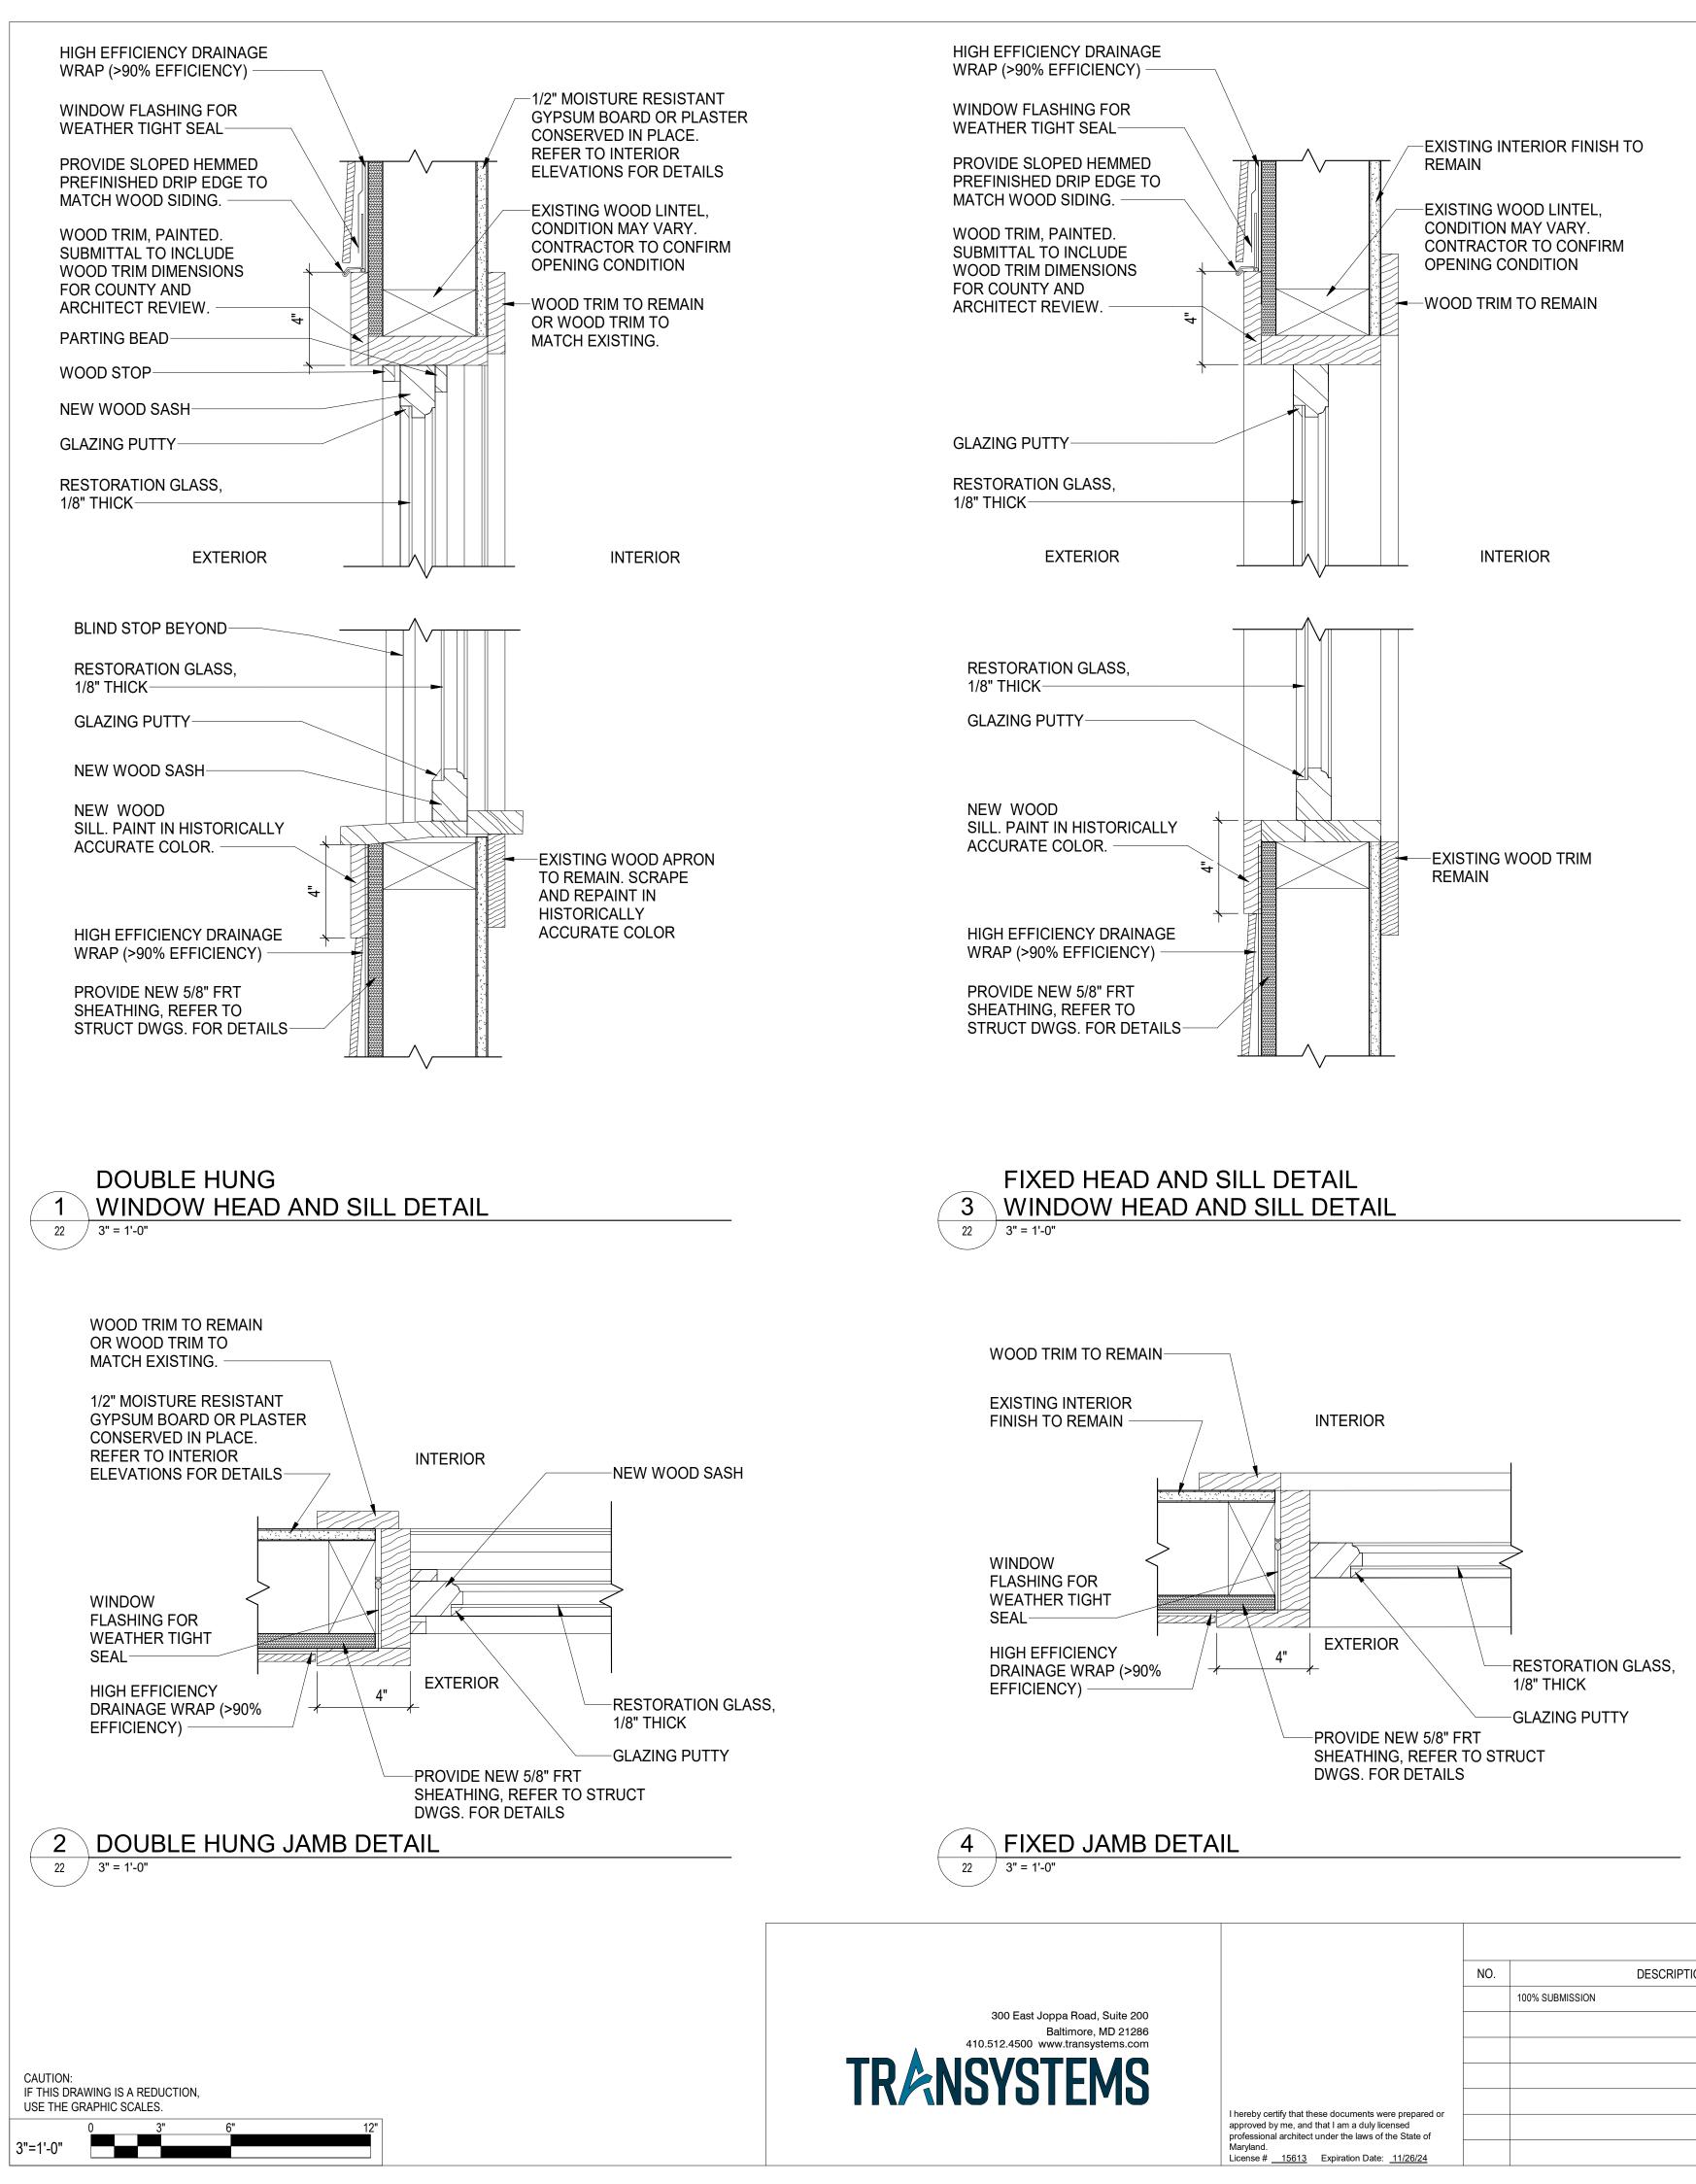REVISIONS

1. WINDOWS WILL HAVE SIMULATED DIVIDED LITES 2. MUNTINS TO MATCH TYPICAL 1870S PROFILE ILLUSTRATED IN THIS DRAWING.



EXTERIOR

NOTE:

SHEET GENERAL NOTES

- ROUGH OPENING AND DETAILS TO BE COORDINATED WITH MANUFACTURER REQUIREMENTS FOR OPENINGS AND WEATHER TIGHT SEALS.
- WOOD TRIM COLOR AND PROFILE TO BE COORDINATED WITH COUNTY 2. HISTORIAN.
- ALL WINDOWS TO HAVE LAMINATED GLASS AND SIMULATED DIVIDED 3. LITES. REFER TO WINDOW ELEVATIONS FOR DETAILS. COLOR AND PROFILE OF MUNTINS TO BE COORDINATED WITH COUNTY HISTORIAN.
- ALL EXISTING WOOD WINDOW FRAME AND TRIM DIMENSIONS AND 4. PROFILES TO BE VERIFIED BY CONTRACTOR AND PROVIDED IN SUBMITTAL FOR ARCHITECT AND HISTORIAN REVIEW.

114

1.75"

1870s

INTERIOR

ANNE ARUNDEL COUNTY

DEPARTMENT OF PUBLIC WORKS DATE APPROVED DATE SCALE: AS SHOWN WILSON HOUSE RESTORATION HOT SOX FIELD AT WILSON PARK DRAWN BY: A.D.M. CHECKED BY: B.P.F. PROJECT MANAGER DATE APPROVED DATE SHEET NO. 22 of 29 WINDOW DETAILS PROJECT NO .: P573200 CHIEF, RIGHT-OF-WAY CONTRACT NO .: P573201 © TRANSYSTEMS 2024

GENERAL NOTES

I. CODE

A. ALL CONSTRUCTION SHALL CONFORM TO 2021 INTERNATIONAL BUILDING CODE, AND ANNE ARUNDEL COUNTY LOCAL AMENDMENTS.

II. DESIGN LOADING

A. THE DESIGN DEAD LOADS ARE THE FOLLOWING:

DECK FRAMING = 10 PSF

B. THE DESIGN LIVE LOADS ARE THE FOLLOWING:

DECK FRAMING = 100 PSF

ROOF LIVE LOAD = 30 PSF

ROOF SNOW LOAD:

- GROUND SNOW LOAD (PC) = 30 PSF FLAT SNOW LOAD (P_F) = 22.7 PSF SNOW EXPOSURE FACTOR (C_{E}) = 0.9 SNOW LOAD IMPORTANCE FACTOR (I) = 1.0 THERMAL FACTOR $(C_T) = 1.2$ SLOPE FACTOR (CS) = 0.5SLOPED SNOW LOAD (PS) = 12 PSF
- IBC 1603.1.4 WIND LOAD
 - ULTIMATE DESIGN WIND SPEED $(V_{I \parallel T}) = 115 \text{ MPH}$ NOMINAL DESIGN WIND SPEED $(V_{ASD}) = 89 \text{ MPH}$ RISK CATEGORY = II WIND EXPOSURE = C
 - INTERNAL PRESSURE COEFFICIENT = ±0.18
- IBC 1603.1.5 EARTHQUAKE DESIGN DATA RISK CATEGORY = II
 - SEISMIC IMPORTANCE FACTOR $(I_{E}) = 1.0$
 - MAPPED SPECTRAL RESPONSE ACCELERATION PARAMETERS:
 - S_S = 0.125 G
 - $S_1 = 0.042 G$
 - SITE CLASS = D DESIGN SPECTRAL RESPONSE ACCELERATION PARAMETERS; S_{DS} = 0.133 G
 - $S_{D1}^{-1} = 0.067 G$ SEISMIČ DESIGN CATEGORY = B
- C. ALL STRUCTURAL COMPONENTS HAVE BEEN DESIGNED FOR THE DEAD LOADS LIVE LOADS SHOWN ABOVE. IT IS THE CONTRACTOR'S RESPONSIBILITY TO DETERMINE ALLOWABLE CONSTRUCTION LOADS AND TO PROVIDE PROPER DESIGN AND CONSTRUCTION OF THOSE ITEMS NECESSARY TO FACILITATE CONSTRUCTION INCLUDING BUT NOT LIMITED TO FALSEWORK, FORMWORK, STAGING, BRACING, SHEETING AND SHORING, ETC.
- D. THE STABILITY OF THE EXISTING STRUCTURE IS DEPENDENT UPON THE DIAPHRAGM ACTION OF THE ROOFS & WALLS. WHILE REMOVING EXISTING SIDING, THE CONTRACTOR IS COMPLETELY RESPONSIBLE FOR THE METHODS OF CONSTRUCTIONS AND SHALL PROVIDE ALL GUYS, BRACING AND SHORING REQUIRED TO ACCOMMODATE ALL INTERIM LOADING CONDITIONS THROUGHOUT THE CONSTRUCTION PHASE.

III. GENERAL

- A. THE CONTRACTOR SHALL FIELD CHECK AND VERIFY ALL DIMENSIONS AND ELEVATIONS OF EXISTING WORK PRIOR TO FABRICATION OF ANY NEW MATERIALS.
- B. THE CONTRACTOR IS ADVISED THAT ALL PLANS, DIMENSIONS, AND DETAILS DEPICT FIELD CONDITION AS SHOWN. MINOR VARIATIONS ARE TO BE EXPECTED AND ANY DEVIATIONS FROM THE CONTRACT DOCUMENTS SHALL BE APPROVED BY THE ARCHITECT IN WRITING PRIOR TO PROCEEDING.
- C. IT IS THE CONTRACTOR'S RESPONSIBILITY TO SATISFY HIMSELF AS TO THE LOCATION OF ANY UTILITIES IN THE IMMEDIATE VICINITY OF CONSTRUCTION SO AS TO PREVENT DAMAGE TO THEM. SHOULD ANY DAMAGE TO SUCH UTILITIES OCCUR THE CONTRACTOR SHALL BE REQUIRED TO REPAIR SUCH DAMAGE AT HIS OWN EXPENSE AND TO THE SATISFACTION OF THE OWNER.
- D. CONSULT THE ARCHITECTURAL, MECHANICAL AND ELECTRICAL DRAWINGS FOR VERIFICATION OF LOCATION AND DIMENSION OF CHASES, INSERTS, OPENINGS, SLEEVES, WASHERS, DRIPS, REVEALS, DEPRESSIONS AND OTHER PROJECT REQUIREMENTS.
- E. ALL WORK SPECIFIED HEREIN SHALL BE INSPECTED IN ACCORDANCE WITH THE BUILDING CODE AND ALL LOCAL ORDINANCES. THE CONTRACTOR SHALL HIRE AN EXPERIENCED, QUALIFIED INSPECTOR TO PERFORM ALL THE REQUIRED INSPECTION WORK. THE ENGINEER WILL NOT PERFORM THE REQUIRED INSPECTION AS A PART OF THEIR DESIGN SERVICES. THE ENGINEER MAY VISIT THE SITE TO ASCERTAIN GENERAL CONFORMANCE WITH THE CONTRACT DOCUMENTS. SUCH SITE VISITS ARE NOT TO BE CONSTRUED AS MEETING ANY INSPECTION REQUIREMENTS UNLESS THE ENGINEER SPECIFICALLY SO STATES IN WRITING.
- F. METAL GUARDRAILS SHALL BE DESIGNED FOR ALL APPLICABLE DEAD LOADS AND FOR ALL LIVE LOADS AS SPECIFIED IN THE LOCAL BUILDING CODE. SHOP DRAWINGS AND CALCULATIONS SHALL BE SIGNED AND SEALED BY A STRUCTURAL ENGINEER LICENSED IN THE STATE OF MARYLAND (AND RETAINED BY THE CONTRACTOR) AND SHALL BE SUBMITTED TO THE ARCHITECT FOR REVIEW.
- G. ANY REVIEW OF STRUCTURAL ITEM SHOP DRAWINGS BY (THE STRUCTURAL ENGINEER) IS FOR GENERAL CONFORMANCE WITH THE DESIGN CONCEPT AS PRESENTED BY THE CONTRACT DOCUMENTS. NO DETAILED CHECK OF QUANTITIES OR DIMENSIONS WILL BE MADE.

- H. AT THE TIME OF SHOP DRAWING SUBMISSION, THE CONTRACTOR SHALL STATE IN WRITING ANY DEVIA OMISSIONS FROM THE CONTRACT DOCUMENTS. TI CONTRACTOR SHALL REVIEW ALL SHOP DRAWINGS SUBMISSION AND MAKE ALL CORRECTIONS AS HE I NECESSARY.
- I. THE STRUCTURAL CONTRACT DOCUMENTS ARE NOT TO BE REPRODUCED FOR USE AS SHOP DRAWINGS.
- J. SHOP DRAWINGS FOR ALL STRUCTURAL ELEMENTS SHOWN ON THE CONTRACT DOCUMENTS MUST BE SUBMITTED BY THE GENERAL CONTRACTOR. IF A CONTRACTOR OR OWNER FAILS TO SUBMIT THE SHOP DRAWINGS, THE ENGINEER WILL NOT BE RESPONSIBLE FOR THE STRUCTURAL CERTIFICATION OR FOR THE DESIGN OF THE PROJECT.

IV. FOUNDATIONS

- A. BOTTOM OF ALL EXTERIOR FOOTINGS SHALL BE A MINIMUM OF 2'-6" BELOW FINISH GRADE OR 2'-0" BELOW EXISTING GRADE, WHICHEVER IS GREATER, UNLESS NOTED OTHERWISE ON THE DRAWINGS. SEE SITE PLANS FOR EXISTING AND FINISHED GRADES.
- B. ALL FOOTINGS HAVE BEEN DESIGNED FOR AN ASSUMED NET SOIL BEARING PRESSURE OF 2,500 PSF. IT SHALL BE THE CONTRACTOR'S RESPONSIBILITY TO SECURE THE SERVICES OF A GEOTECHNICAL ENGINEER FOR FIELD VERIFICATION OF THE ASSUMED SOIL BEARING PRESSURES. SHOULD THE SOIL BEARING PRESSURE BE FOUND TO BE LESS THAN THIS VALUE THE CONTRACTOR SHALL IMMEDIATELY NOTIFY THE ENGINEER. IN THIS CASE, THE FOOTINGS WILL EITHER HAVE TO BE DEEPER OR RE-DESIGNED. CONTRACTOR SHALL RECEIVE THE APPROVAL OF THE TESTING AGENCY PRIOR TO PLACING ALL FOUNDATION CONCRETE.

V. CAST-IN-PLACE CONCRETE

A. ALL CONCRETE WORK SHALL CONFORM TO THE LATEST APPROVED (BY LOCAL GOVERNMENT) EDITIONS OF THE FOLLOWING A.C.I. AND A.S.T.M. DOCUMENTS:

ACI-318	BLDG CODE REQUIREMENTS FOR
ACI-214	COMPRESSION TESTS
ACI-306	COLD WEATHER
ACI-347	FORMWORK
ACI-305	HOT WEATHER
ACI-211	PROPORTIONS OF CONCRETE
ACI-304	PLACING CONCRETE
ASTM C94	READY-MIX CONCRETE

B. ALL FIELD AND LAB TESTING OF CONCRETE SHALL CONFORM TO THE LATEST APPROVED (BY LOCAL GOVERNMENT) EDITIONS OF ASTM:

ASTM	C31	FIELD CYLINDER SPECIMENS
ASTM	C143	SLUMP TEST
ASTM	C231	AIR CONTENT (WHEN REQU
ASTM	C39	LAB TESTING CYLINDERS
ASTM	C172	SAMPLING FRESH CONCRET

- C. THE CONTRACTOR IS CAUTIONED THAT THE SCHEDULED CONSTRUCTION SEQUENCE FOR THE CONCRETE WORK MAY REQUIRE HIGHER CONCRETE STRENGTHS FOR SUPPORT OF CONSTRUCTION LOADINGS. CONCRETE MEMBERS CANNOT CARRY THEIR DESIGN LOADING UNTIL THE SPECIFIED 28-DAY COMPRESSIVE STRENGTHS ARE OBTAINED. CONTRACTOR SHALL INCREASE CONCRETE STRENGTHS AS REQUIRED.
- D. ALL CONCRETE SHALL BE STONE AGGREGATE CONCRETE HAVING A MINIMUM COMPRESSIVE STRENGTH OF 4000 PSI AT 28 DAYS. ALL CONCRETE SHALL HAVE AN AIR ENTRAINMENT OF 5%±1%. NO ADMIXTURES CONTAINING CALCIUM CHLORIDE SHALL BE PERMITTED. MAXIMUM AGGREGATE SIZE FOR CONCRETE SHALL BE 1", AND MAXIMUM SLUMP SHALL BE 4". ALL CONCRETE SHALL CONTAIN A WATER REDUCING ADMIXTURE.
- E. ALL CONCRETE MIX DESIGNS AND ADMIXTURES SHALL BE APPROVED BY THE ENGINEER 30 DAYS PRIOR TO INITIATION OF FIRST POUR.
- F. ALL REINFORCING BARS SHALL CONFORM TO ASTM A-615 GRADE 60.
- G. ALL CONCRETE SHALL BE SAMPLED AND TESTED BY AN AGENCY RETAINED BY THE CONTRACTOR. THE CONTRACTOR SHALL NOTIFY THE TESTING AGENCY 48 HOURS PRIOR TO THE POURING OF ANY CONCRETE.
- H. TESTING FREQUENCY: OBTAIN ONE CONCRETE SAMPLE FOR EACH DAY'S POUR.
 - a. CAST AND LABORATORY CURE TWO SETS OF TWO STANDARD CYLINDER
 - b. CAST AND FIELD CURE TWO SETS OF TWO STANDARD CYLINDER
- I. COMPRESSIVE STRENGTH TESTS: ASTM C39/C 39M; TEST ONE SET OF TWO LABORATORY CURED SPECIMENS AT 7 DAYS AND ONE SET OF TWO SPECIMENS AT 28 DAYS.
 - a. TEST ONE SET OF TWO FIELD-CURED SPECIMENS AT 7 DAYS AND ONE SET OF TWO SPECIMENS AT 28 DAYS.
 - b. A COMPRESSIVE-STRENGTH TEST SHALL BE THE AVERAGE COMPRESSIVE STRENGTH FROM A SET OF TWO SPECIMENS OBTAINED FROM SAME COMPOSITE SAMPLE AND TESTED AT AGE INDICATED.




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Joppa Road Suite 200 Baltimore, MD 21286 www.transystems.com			100% SUBMISSION	M.W.S.	08/01/24	APPROVED
FMS						 CHIEF ENGINEER
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	License #200461 Expiration Date: <u>09/02/25</u>					ASSISTANT CHIEF ENGINE

- VI. STRUCTURAL STEEL
- A. ALL STRUCTURAL AND MISCELLANEOUS STEEL SHALL CONFORM TO THE SIXTEENTH EDITION OF THE AISC "SPECIFICATION FOR STRUCTURAL STEEL BUILDINGS" AND ALL ITS SUPPLEMENTS, AND TO THE AISC "CODE OF STANDARD PRACTICE FOR STEEL BUILDINGS AND BRIDGES."
- B. ALL STRUCTURAL STEEL SHALL BE AS FOLLOWS:
- MISCELLANEOUS STEEL.....ASTM A36, FY = 36,000 PSI RECTANGULAR/SQUARE HSS.....ASTM A500 GRADE C, FY = 50,000 PSI
- C. ALL WELDED CONNECTIONS SHALL BE DONE WITH E70XX ELECTRODES. SHOP AND FIELD WELDS SHALL BE MADE BY APPROVED CERTIFIED WELDERS AND SHALL CONFORM TO THE AMERICAN WELDING SOCIETY CODE FOR BUILDINGS AWS D1.1.
- D. SHOP AND FIELD WELDS SHALL BE MADE BY APPROVED CERTIFIED WELDERS AND SHALL CONFORM TO THE AMERICAN WELDING SOCIETY CODE FOR BUILDINGS AWS D1.1.
- E. EXPOSED STRUCTURAL STEEL SHALL CONFORM TO THE "SPECIFICATION FOR ARCHITECTURALLY EXPOSED STRUCTURAL STEEL" AISC. GRIND ALL EXPOSED BUTT OR PENETRATION WELDS FLUSH WITH SURFACES.
- F. THE USE OF A GAS-CUTTING TORCH IN THE FIELD FOR CUTTING HOLES OR FOR CORRECTIONS FABRICATION ERRORS WILL NOT BE PERMITTED ON NEW STRUCTURAL FRAMING MEMBERS EXCEPT WITH THE WRITTEN APPROVAL OF THE ARCHITECT FOR EACH SPECIFIC CONDITION.
- G. ALL STRUCTURAL STEEL SHALL BE HOT-DIPPED GALVANIZED IN ACCORDANCE WITH ASTM A123. SEE ARCHITECTURAL DRAWINGS AND SPECIFICATIONS FOR PAINTING OF GALVANIZED STEEL.
- H. FIELD STRUCTURAL STEEL TO BE INSPECTED BY QUALIFIED INSPECTORS RETAINED BY THE CONTRACTOR. FIELD INSPECTION REPORTS TO BE FILED WITH THE STRUCTURAL ENGINEER WITHIN 5 DAYS OF TIME OF ACTUAL INSPECTION. INSPECTORS MUST BE NOTIFIED OF ALL PHASES OF CONSTRUCTION AND WELDING BY GENERAL CONTRACTOR.
- I. AN INDEPENDENT INSPECTION AGENCY SHALL BE EMPLOYED BY THE CONTRACTOR AND APPROVED BY THE ENGINEER TO INSPECT THE STRUCTURAL STEEL IN THE FIELD AND VERIFY THAT IT CONFORMS TO THE REQUIREMENTS OF THE CONTRACT DOCUMENTS.
- VII. EXTERIOR WOOD FRAMING (PRESSURE-TREATED)
- A. ALL FABRICATION, ERECTION, OTHER PROCEDURES, AND MINIMUM UNIT STRESSES SHALL CONFORM TO THE CURRENT "NATIONAL DESIGN SPECIFICATION FOR WOOD CONSTRUCTION".
- B. ALL WOOD FRAMING SHALL BE FABRICATED AND ERECTED IN ACCORDANCE WITH THE AMERICAN INSTITUTE OF TIMBER CONSTRUCTION SPECIFICATION AITC 105 "RECOMMENDED PRACTICE FOR THE ERECTION OF STRUCTURAL TIMBER FRAMING, AITC 106," "CODE OF STANDARD PRACTICE", AND "THE NATIONAL DESIGN SPECIFICATION FOR WOOD CONSTRUCTION", LATEST EDITION, AS PUBLISHED BY THE NATIONAL FOREST PRODUCTS ASSOCIATION.
- C. STRUCTURAL SOLID WOOD JOISTS, BEAMS, AND POSTS SHALL BE GROUND CONTACT PRESSURE-TREATED SOUTHERN YELLOW PINE, #2 OR BETTER.
- D. STRUCTURAL SOLID WOOD DECKING SHALL BE PRESSURE-TREATED SOUTHERN YELLOW PINE, #1 OR BETTER.
- E. ALL DOUBLE JOISTS SHALL BE SPIKED TOGETHER WITH (2) 10D GALV. NAILS @ 16" O/C.
- F. ALL WOOD BEAMS MADE UP OF 3 OR MORE 2X'S SHALL BE BOLTED TOGETHER WITH (2) ROWS OF 1/2" DIAMETER GALVANIZED A307 THROUGH-BOLTS @ 18" O/C.
- G. ALL HARDWARE, UNLESS NOTED OTHERWISE AS STAINLESS STEEL, SHALL BE HOT-DIPPED GALVANIZED.
- VIII. WOOD FRAMING FOR WILSON HOUSE REPAIRS
- A. ALL FABRICATION, ERECTION, OTHER PROCEDURES, AND MINIMUM UNIT STRESSES SHALL CONFORM TO THE CURRENT "NATIONAL DESIGN SPECIFICATION FOR WOOD CONSTRUCTION".
- B. ALL WOOD FRAMING SHALL BE FABRICATED AND ERECTED IN ACCORDANCE WITH THE AMERICAN INSTITUTE OF TIMBER CONSTRUCTION SPECIFICATION AITC 105 "RECOMMENDED PRACTICE FOR THE ERECTION OF STRUCTURAL TIMBER FRAMING, AITC 106," "CODE OF STANDARD PRACTICE", AND "THE NATIONAL DESIGN SPECIFICATION FOR WOOD CONSTRUCTION", LATEST EDITION, AS PUBLISHED BY THE NATIONAL FOREST PRODUCTS ASSOCIATION.
- C. ALL LUMBER FOR REPAIRS SHALL BE NO. 2 HEM FIR, DOUGLAS FIR, OR SOUTHERN PINE SURFACE DRY WITH A 19% MAXIMUM MOISTURE CONTENT OR BETTER.

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DATE	APPROVED DATE	SCALE: AS SHOWN	WILSON HOUSE RESTORATION					
		DRAWN BY: D.E.F.	HOT SOX FIELD AT WILSON PARK					
	PROJECT MANAGER	CHECKED BY: M.W.S.						
DATE	APPROVED DATE	SHEET NO. 23 OF 29	GENERAL NOTES					
		PROJECT NO.: P573200	GENERAL NUTES					
R	CHIEF, RIGHT-OF-WAY	CONTRACT NO.: P573201						
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TEMS						CHIEF ENGINEER
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	License #200461 Expiration Date: <u>09/02/25</u>					ASSISTANT CHIEF ENGINEE



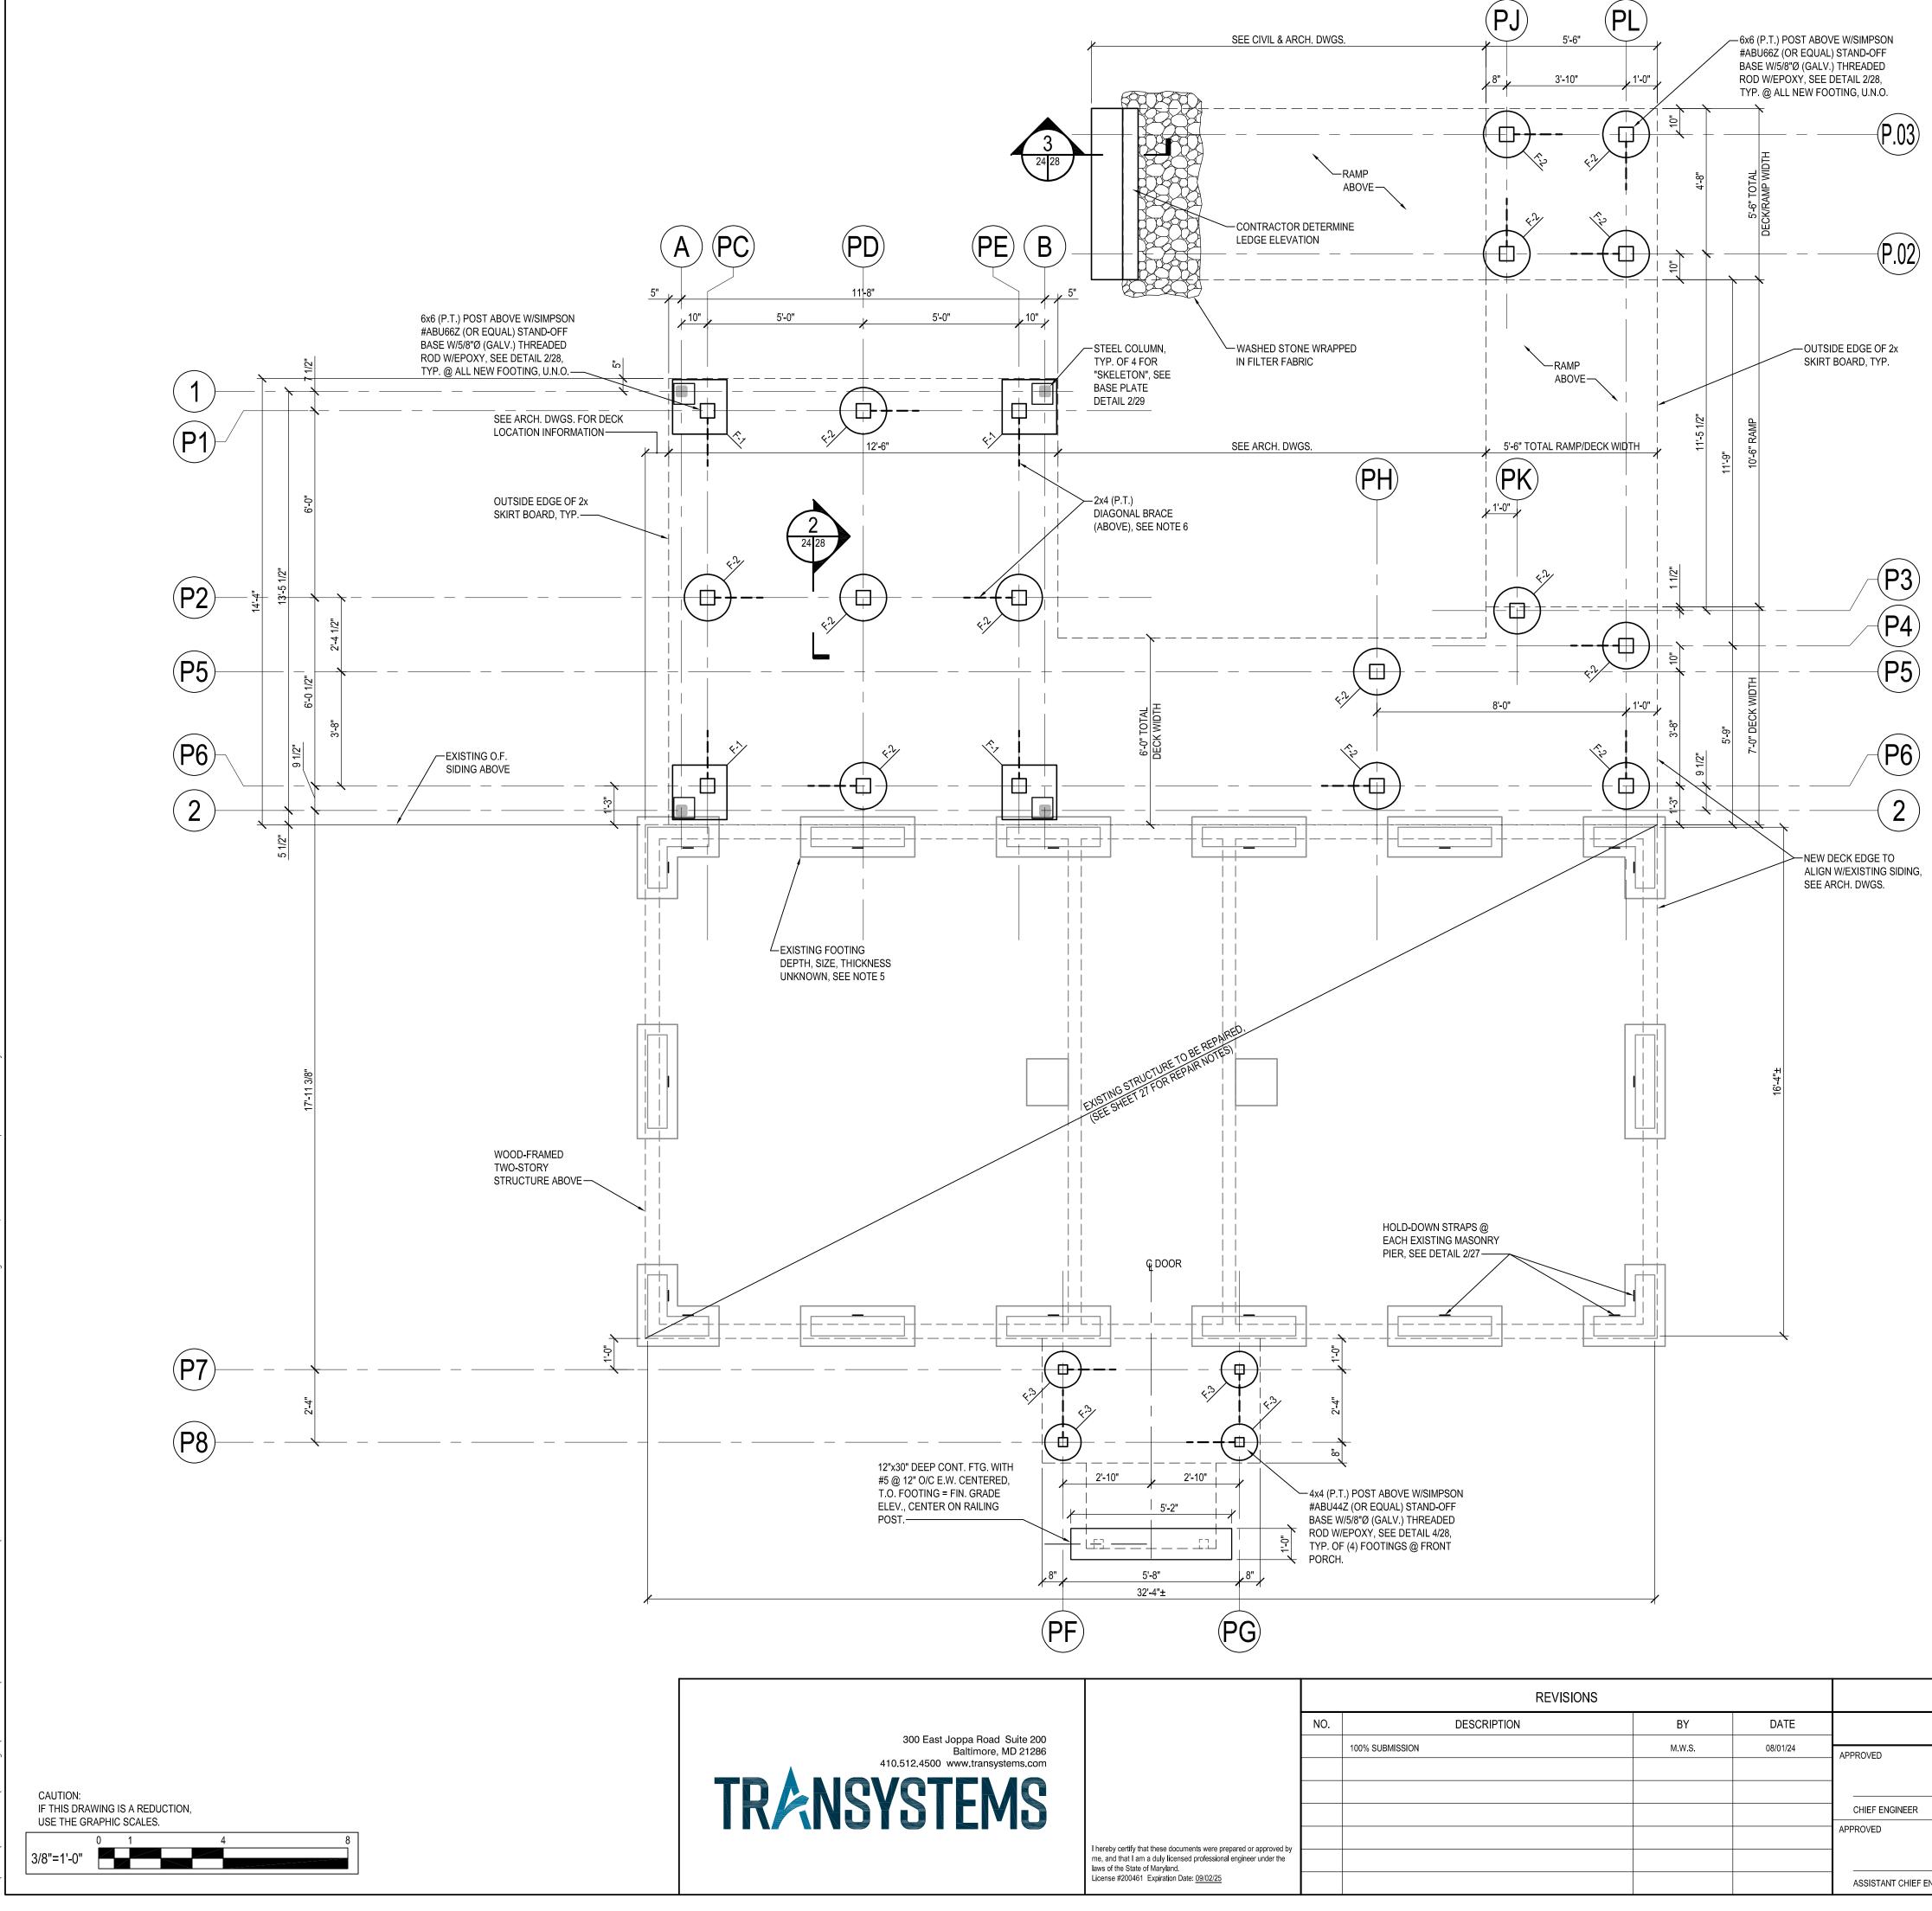
FOUNDATION PLAN

FOUNDATION PLAN NOTES:

- 1. FOOTINGS HAVE BEEN DESIGNED FOR AN ASSUMED SOIL BEARING PRESSURE OF 2,500 PSF. CONTRACTOR VERIFY SOIL CONDITIONS, SEE GENERAL NOTES.
- 2. BOTTOM OF NEW FOOTINGS SHALL BE 30" BELOW FINISHED GRADE, MIN. TOP OF NEW FOOTINGS SHALL BE 4" (±1") ABOVE FINISHED GRADE, UNLESS NOTED OTHERWISE. FORM AS REQUIRED.
- 3. SEE ARCHITECTURAL DRAWINGS FOR DIMENSIONS NOT SHOWN. 4. FOOTINGS ARE NOTED F-X. SEE FOOTING SCHEDULE ON THIS SHEET.
- 5. FOR EXISTING FOOTINGS ADJACENT TO GRID LINE PRIOR TO CONSTRUCTION OF NEW FOOTINGS THE EXISTING BOTTOM OF FOOTINGS & FOOTING PROJECTION SHALL BE DETERMINED BY THE CONTRACTOR, TO DETERMINE WHETHER UNDERPINNING OF THE EXISTING FOOTINGS WILL BE NECESSARY. PROVIDE DEPTH
- AND EXISTING FOOTING THICKNESS & PROJECTION INFORMATION TO ARCHITECT/STRUCTURAL ENGINEER FOR REVIEW, PRIOR TO STEEL REINFORCING SHOP DRAWING SUBMISSION.
- 6. DIAGONAL BRACE FROM TOP OF POST TO DECK FRAMING (JOISTS OR F.F. BEAM), AT LOCATIONS INDICATED ON PLAN.

FOOTING SCHEDULE							
MARK SIZE REINFORCING REMARK							
F-1	21"x21"	(12) #4 VERT. W/#3 TIES @ 12" O/C	SEE DETAIL 2/28 & B/29				
F-2	18" DIAMETER	(7) #4 VERT. W/#3 TIES @ 12" O/C	SEE DETAIL 2/28 & A/28				
F-3 14" DIAMETER		(5) #4 VERT. W/#3 TIES @ 12" O/C	SEE DETAIL 2/28 & A/28				
 FOOTING NOTES: ALL FOOTINGS ARE DESIGNED FOR AN ALLOWABLE SOIL BEARING PRESSURE OF 2,500 PSF, WHICH SHALL BE FIELD-VERIFIED BY A MARYLAND LICENSED GEOTECHNICAL ENGINEER HIRED BY THE CONTRACTOR. 							

	ANNE ARUND	EL COUNTY	
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DATE	APPROVED DATE	SCALE: AS SHOWN	WILSON HOUSE RESTORATION
		DRAWN BY: D.E.F.	HOT SOX FIELD AT WILSON PARK
	PROJECT MANAGER	CHECKED BY: M.W.S.	
DATE	APPROVED DATE	SHEET NO. 24 OF 29	FOUNDATION PLAN
		PROJECT NO.: P573200	FOUNDATION FLAN
R	CHIEF, RIGHT-OF-WAY	CONTRACT NO.: P573201	
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FRAMING PLAN

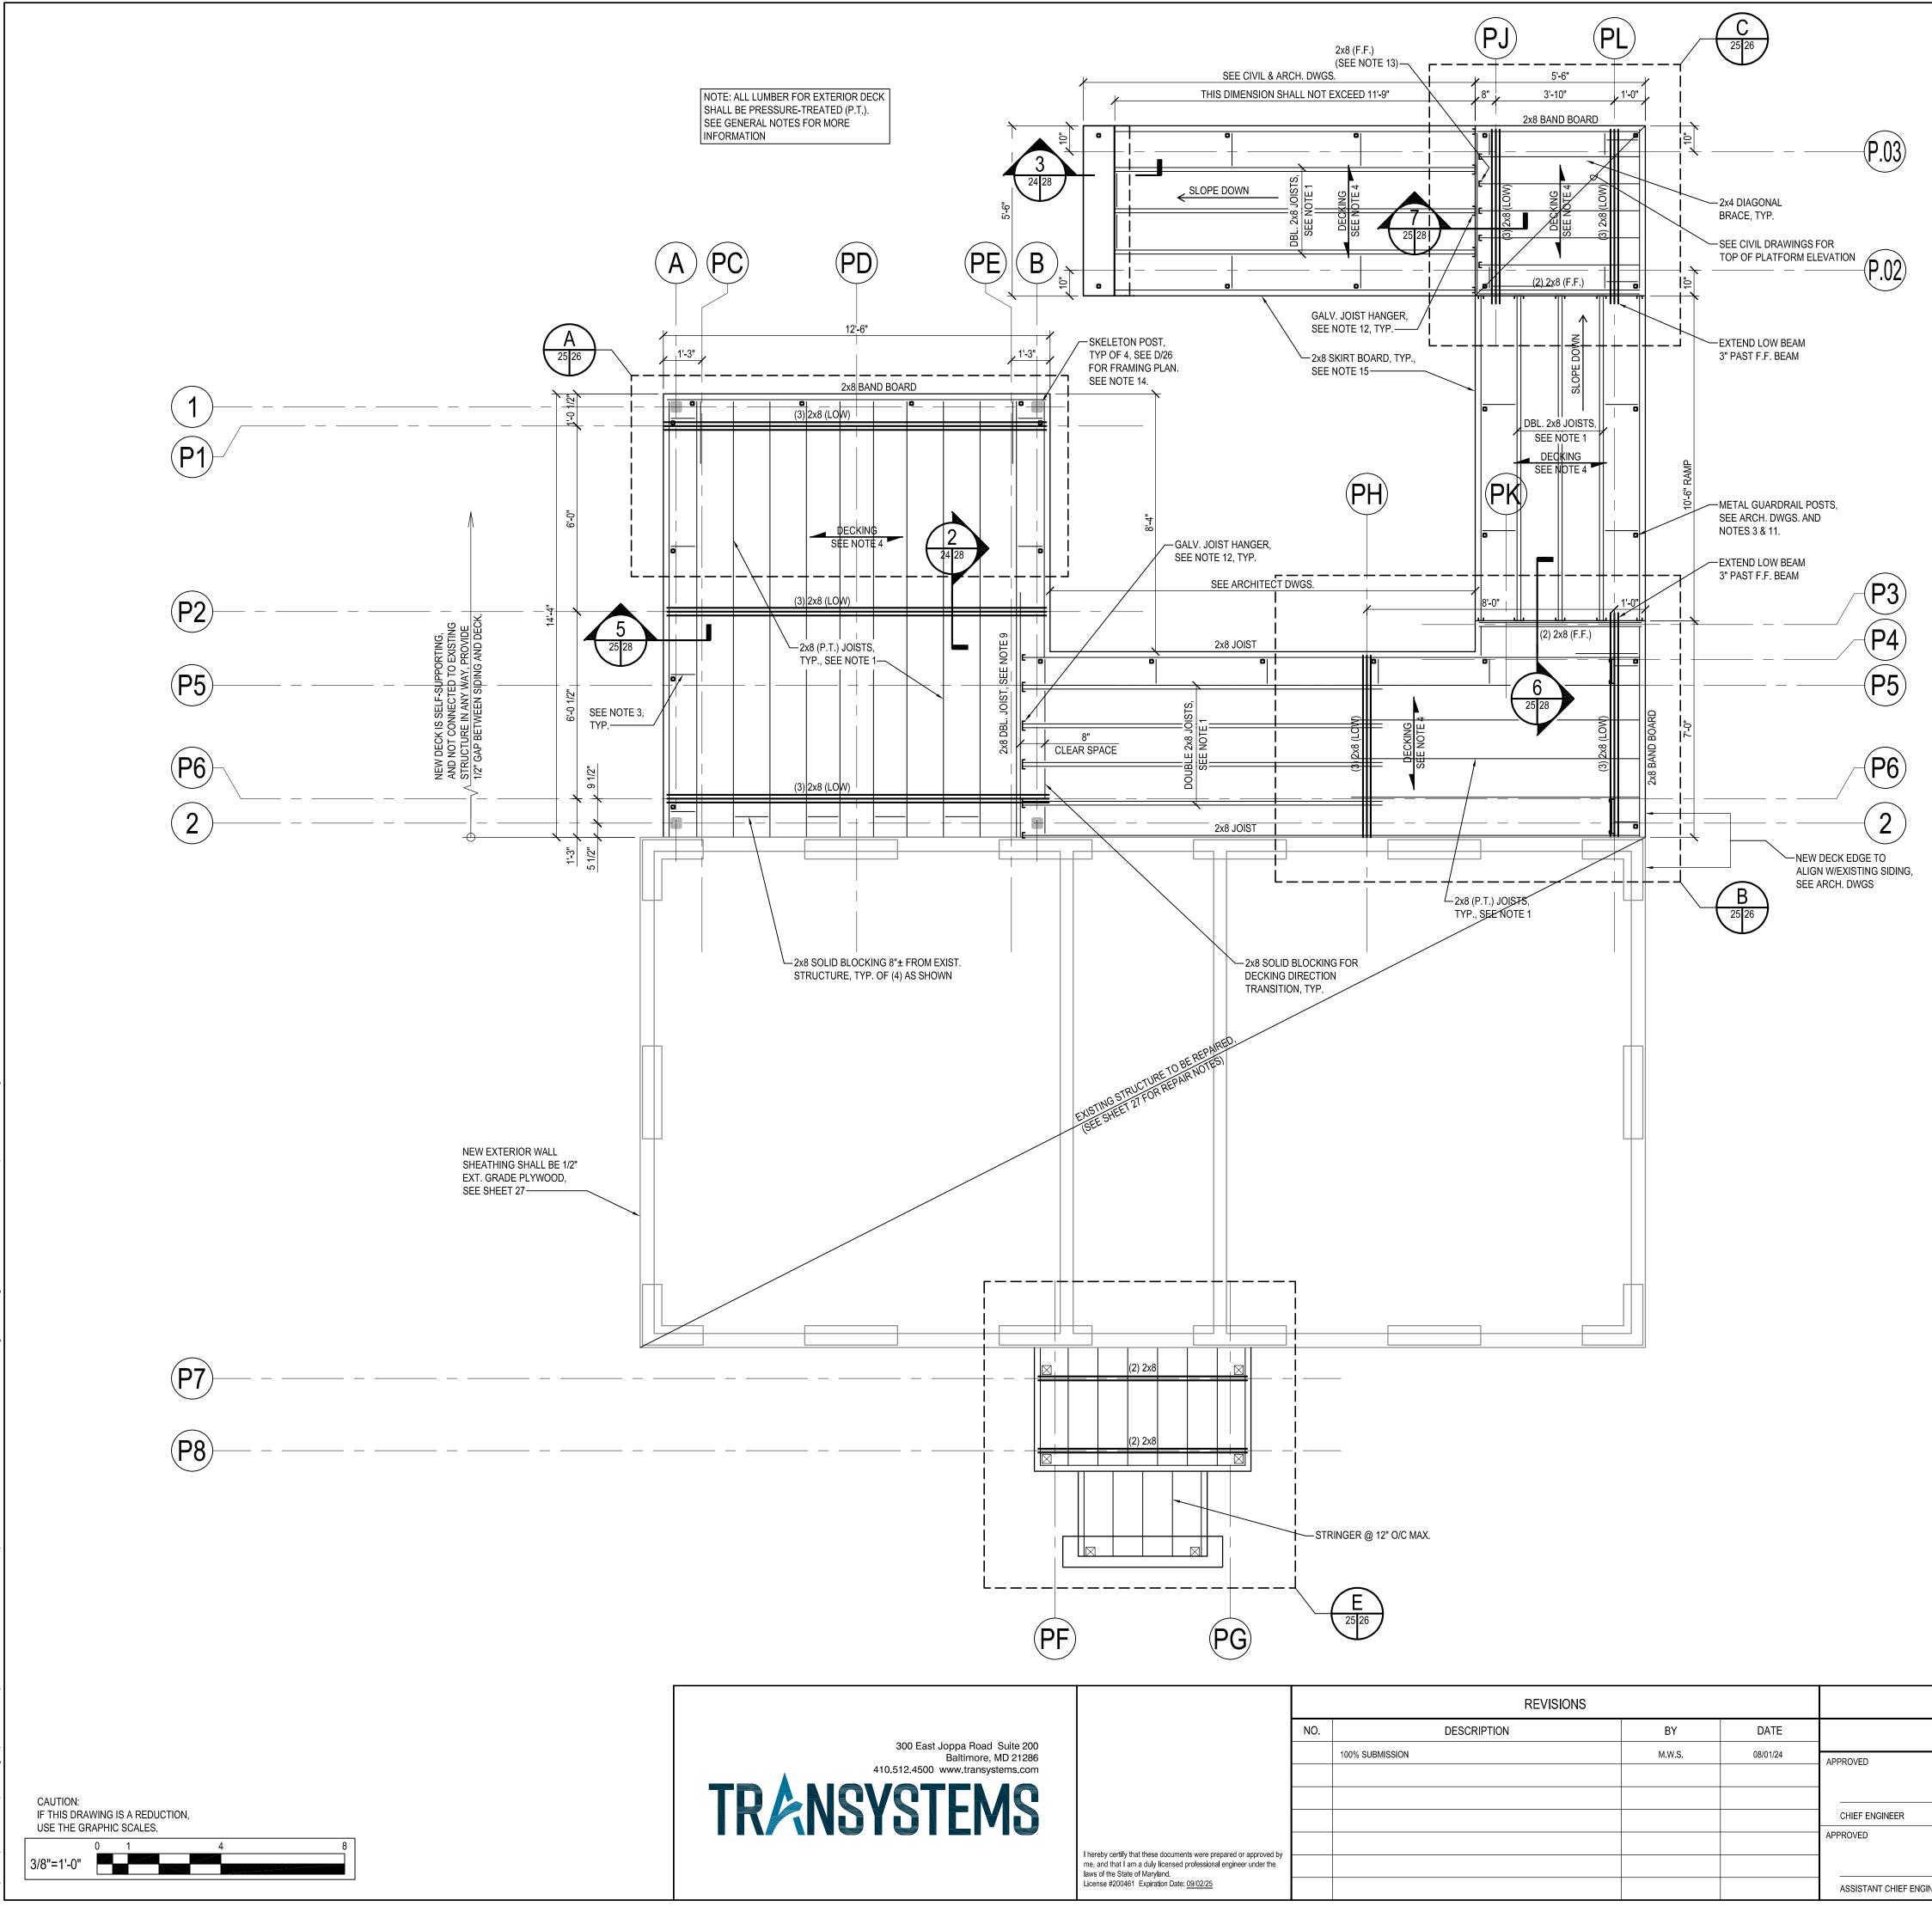
SCALE: 3/8" = 1'-0" FRAMING PLAN NOTES:

- 1. SEE ENLARGED PART PLANS FOR SPECIFIC LOCATIONS OF CERTAIN JOISTS AS REQUIRED FOR GUARDRAIL POST SUPPORT, AND FOR TYP. JOIST SPACING.
- 2. 📑; INDICATES SKELETON STRUCTURE POSTS. SEE ARCHITECTURAL DRAWINGS & SKELETON FRAMING PLAN. 3. -----; INDICATES SOLID BLOCKING (2x8) @ STEEL RAILING POSTS. SEE ENLARGED PARTIAL FRAMING PLANS FOR DETAILS. SEE ARCH. DWGS. FOR GUARDRAIL POST LOCATIONS. NOTE: LOCATION OF BLOCKING IS EXTREMELY IMPORTANT FOR PROPER LOCATION OF RAILING POSTS.
- 4. 2x6 PRESSURE-TREATED DECKING SHALL BE CONTINUOUS (NO JOINTS). DECKING SHALL BE ATTACHED TO EACH JOIST/DOUBLE JOIST/F.F. BEAM W/(2) #10 x 3 1/2" STAINLESS STEEL SCREWS.
- 5. SEE CIVIL & ARCHITECTURAL DRAWINGS FOR DECK & LANDING ELEVATIONS. 6. (LOW); INDICATES BEAM IS DIRECTLY BELOW JOISTS SUPPORTED.
- 7. (F.F.); INDICATES FLUSH-FRAMED BEAM WHERE TOP OF BEAM EQUALS TOP OF JOISTS SUPPORTED. 8. GUARDRAIL POST CONNECTION COMPONENTS SHALL BE SHOWN ON GUARDRAIL SHOP DRAWINGS PER
- LOCATIONS AS SHOWN ON THE ARCHITECTURAL DRAWINGS. 9. ALL DOUBLE JOIST SHALL BE SPIKED TOGETHER W/(2) ROWS OF 10d GALV. NAILS @ 16" O/C. 10. ALL BEAMS MADE UP OF (3) 2x'S SHALL BE BOLTED TOGETHER WITH (2) ROWS OF 1/2"Ø A307 (GALV.)


THROUGH-BOLTS @ 18" O/C. 11. SHOP DRAWINGS AND CALCULATIONS FOR METAL GUARDRAILS SHALL BE SIGNED & SEALED BY AN ENGINEER LICENSED IN THE STATE OF MARYLAND, AND RETAINED BY THE CONTRACTOR. 12. SEE DETAIL 1/29 FOR TYPE OF JOIST HANGER TO BE USED WHEN JOISTS FRAME INTO SIDE OF DOUBLE JOIST

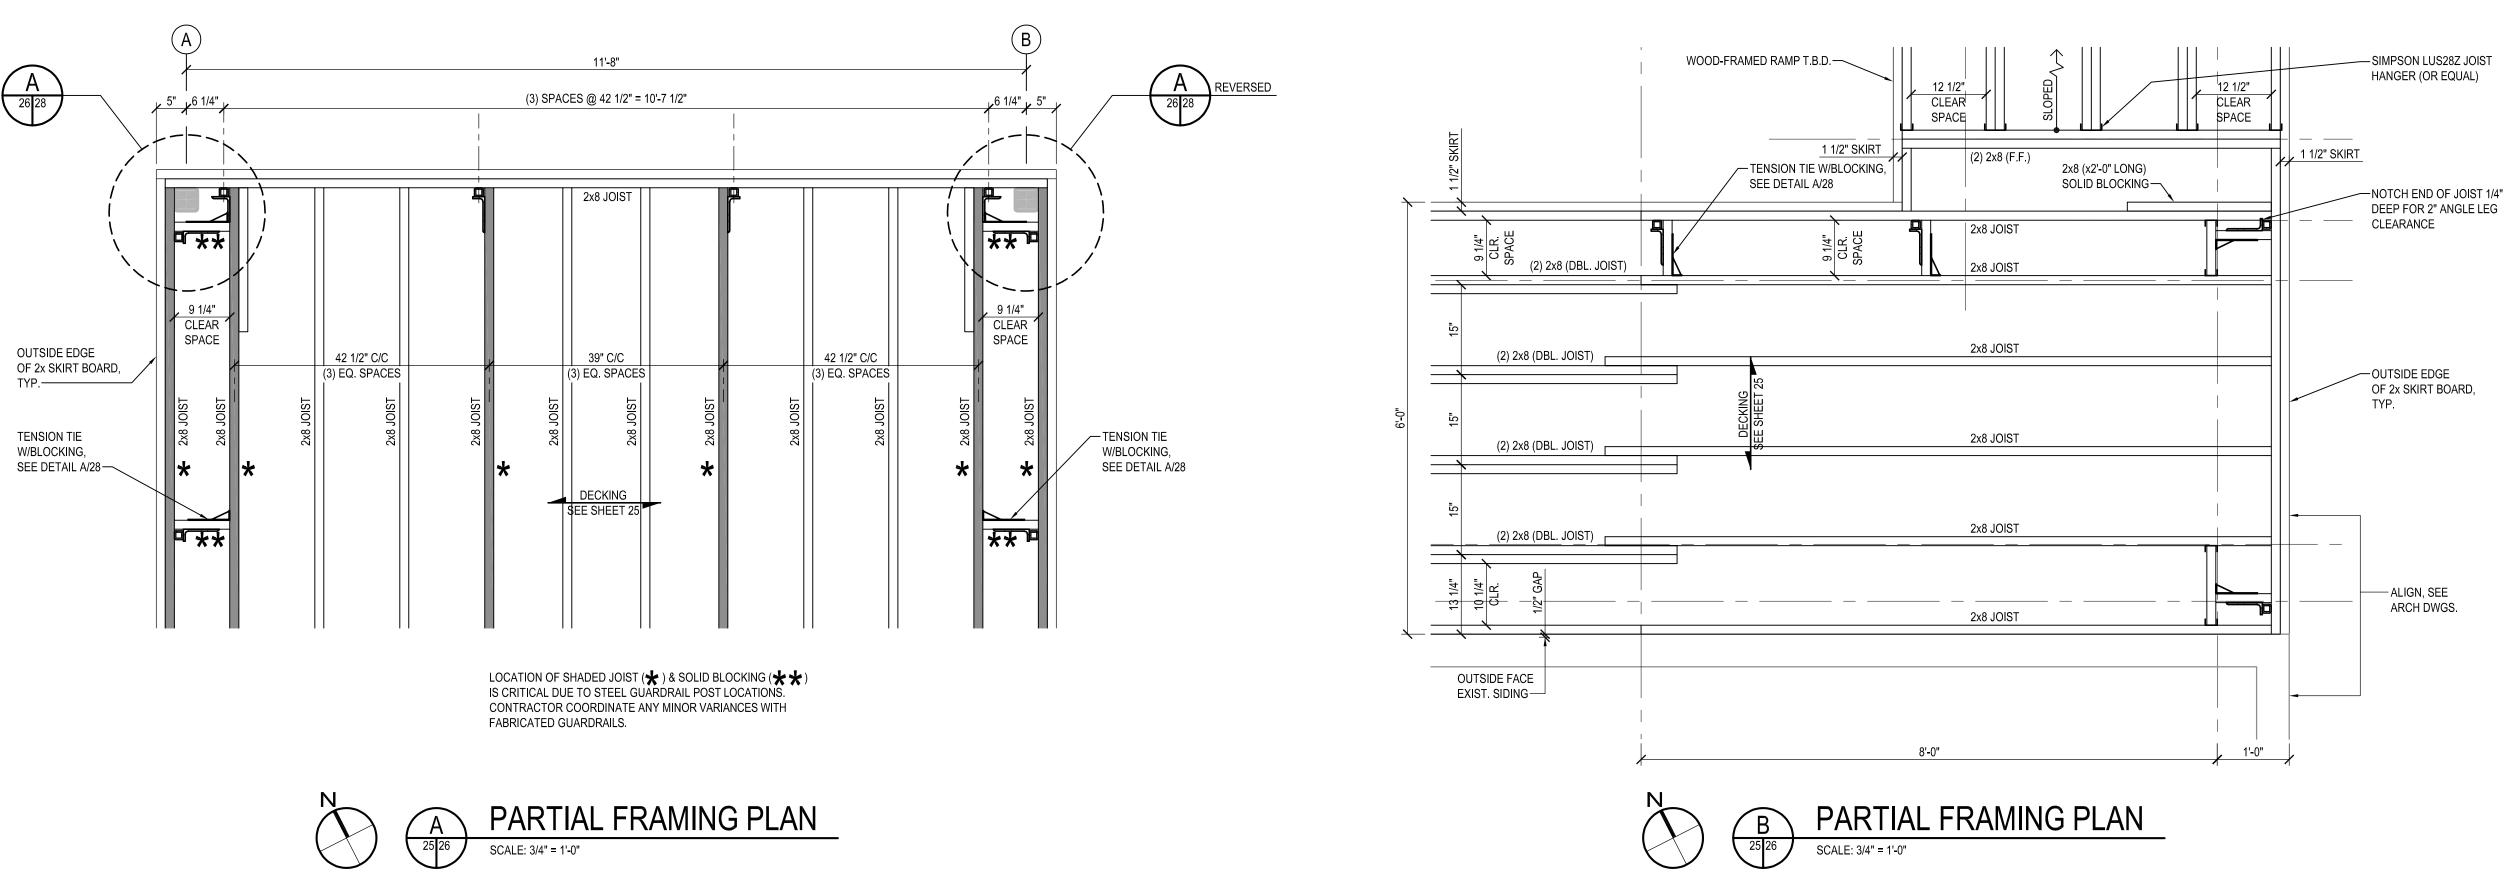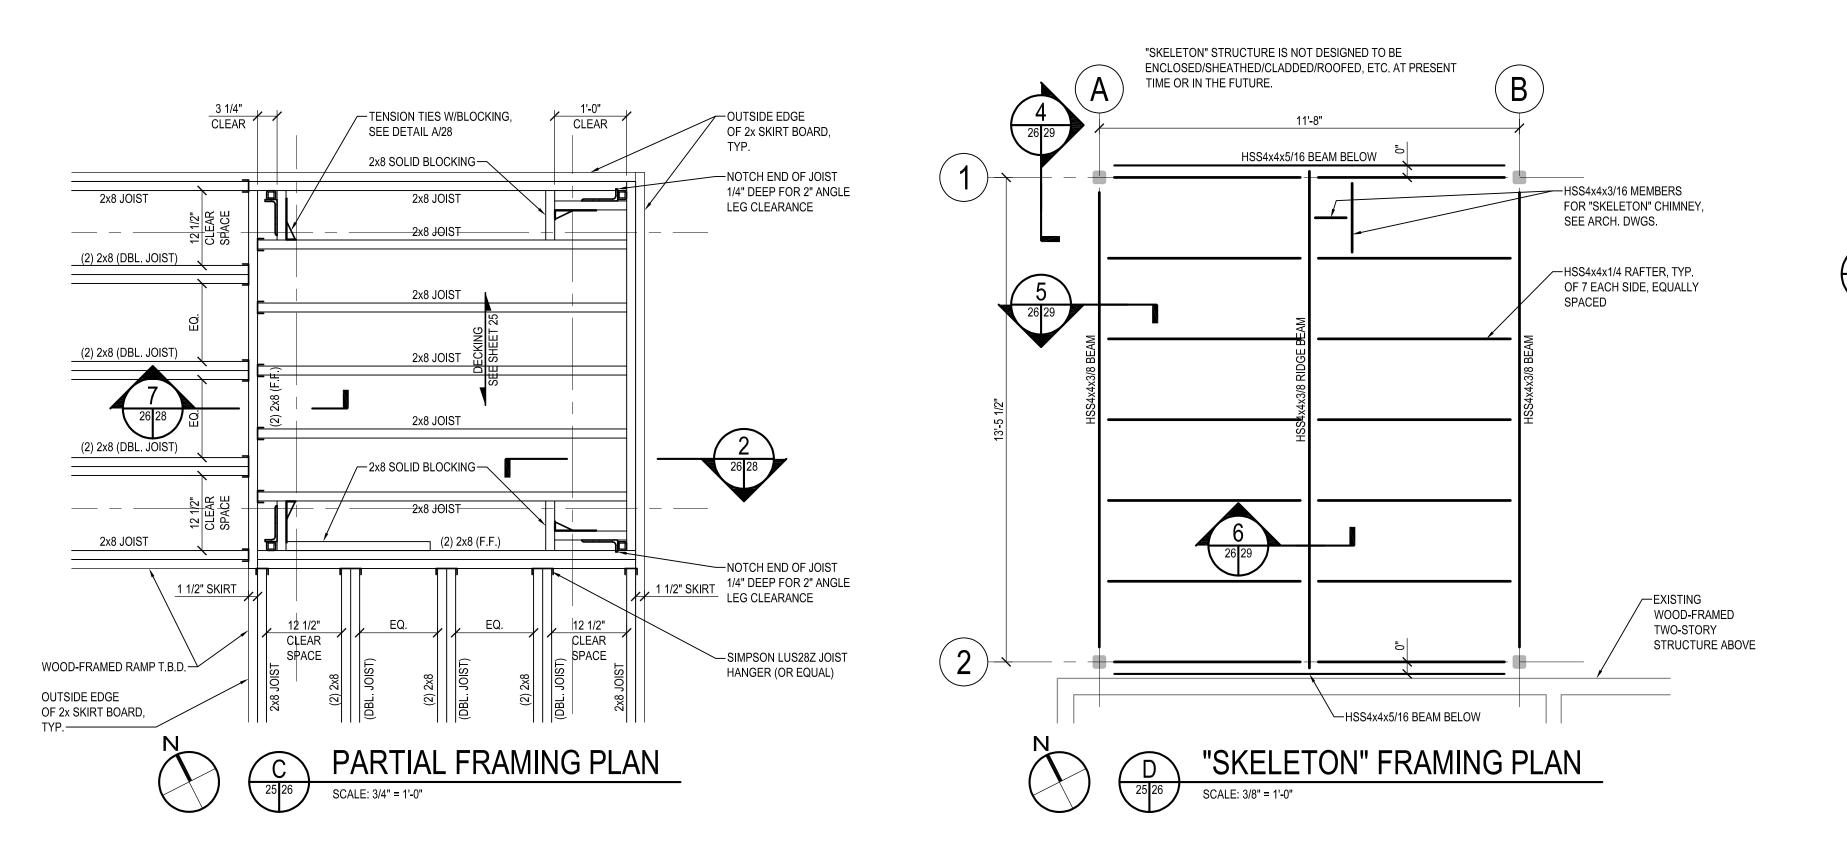- OR FLUSH-FRAMED (F.F.) BEAM. 13. STRAP OVER END OF FLAT JOISTS AND WRAP ON OUTSIDE OF 2x8 F.F., SEE SECTION 7/28.
- 14. "SKELETON" STRUCTURE IS NOT DESIGNED TO BE ENCLOSED/SHEATHED/CLADDED/ROOFED, ETC. AT PRESENT TIME OR IN THE FUTURE.
- 15. ATTACH SKIRT BOARD (2x8 P.T.) WITH #10 x 3" LONG STAINLESS STEEL SCREWS PER PATTERN SHOWN ON DETAIL 7/29. SKIRT BOARD SHALL BE FULL LENGTH WITH JOINTS ONLY AT CORNERS AND CHANGE IN SLOPE.

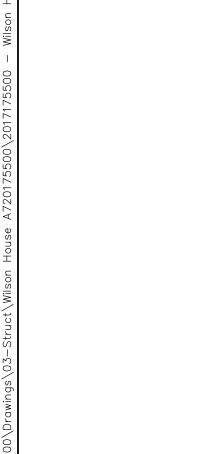
DEPARTMENT OF PUBLIC WORKS					
DATE APPROVED DATE		SCALE: AS SHOWN	WILSON HOUSE RESTORATION		
		DRAWN BY: D.E.F.	HOT SOX FIELD AT WILSON PARK		
	PROJECT MANAGER	CHECKED BY: M.W.S.			
DATE	APPROVED DATE	SHEET NO. 25 OF 29	FRAMING PLAN		
		PROJECT NO.: P573200			
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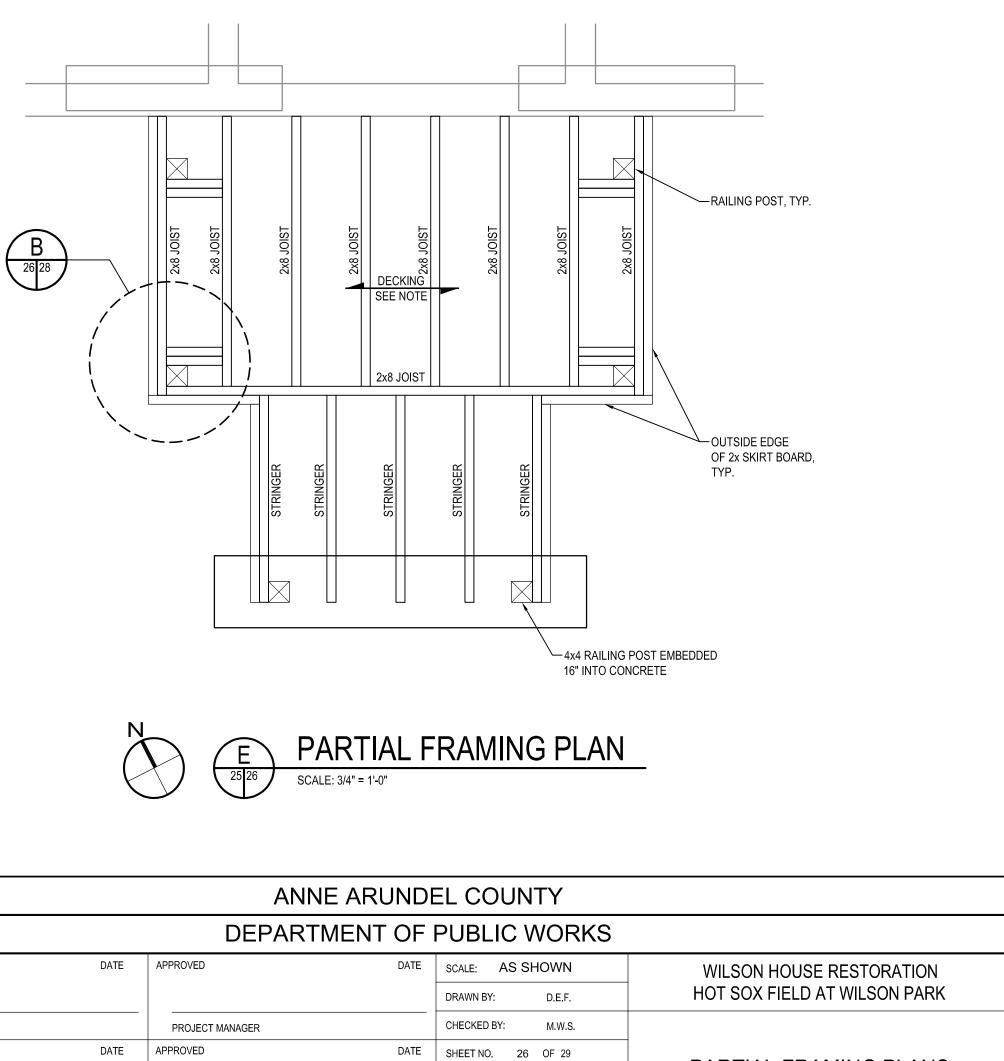






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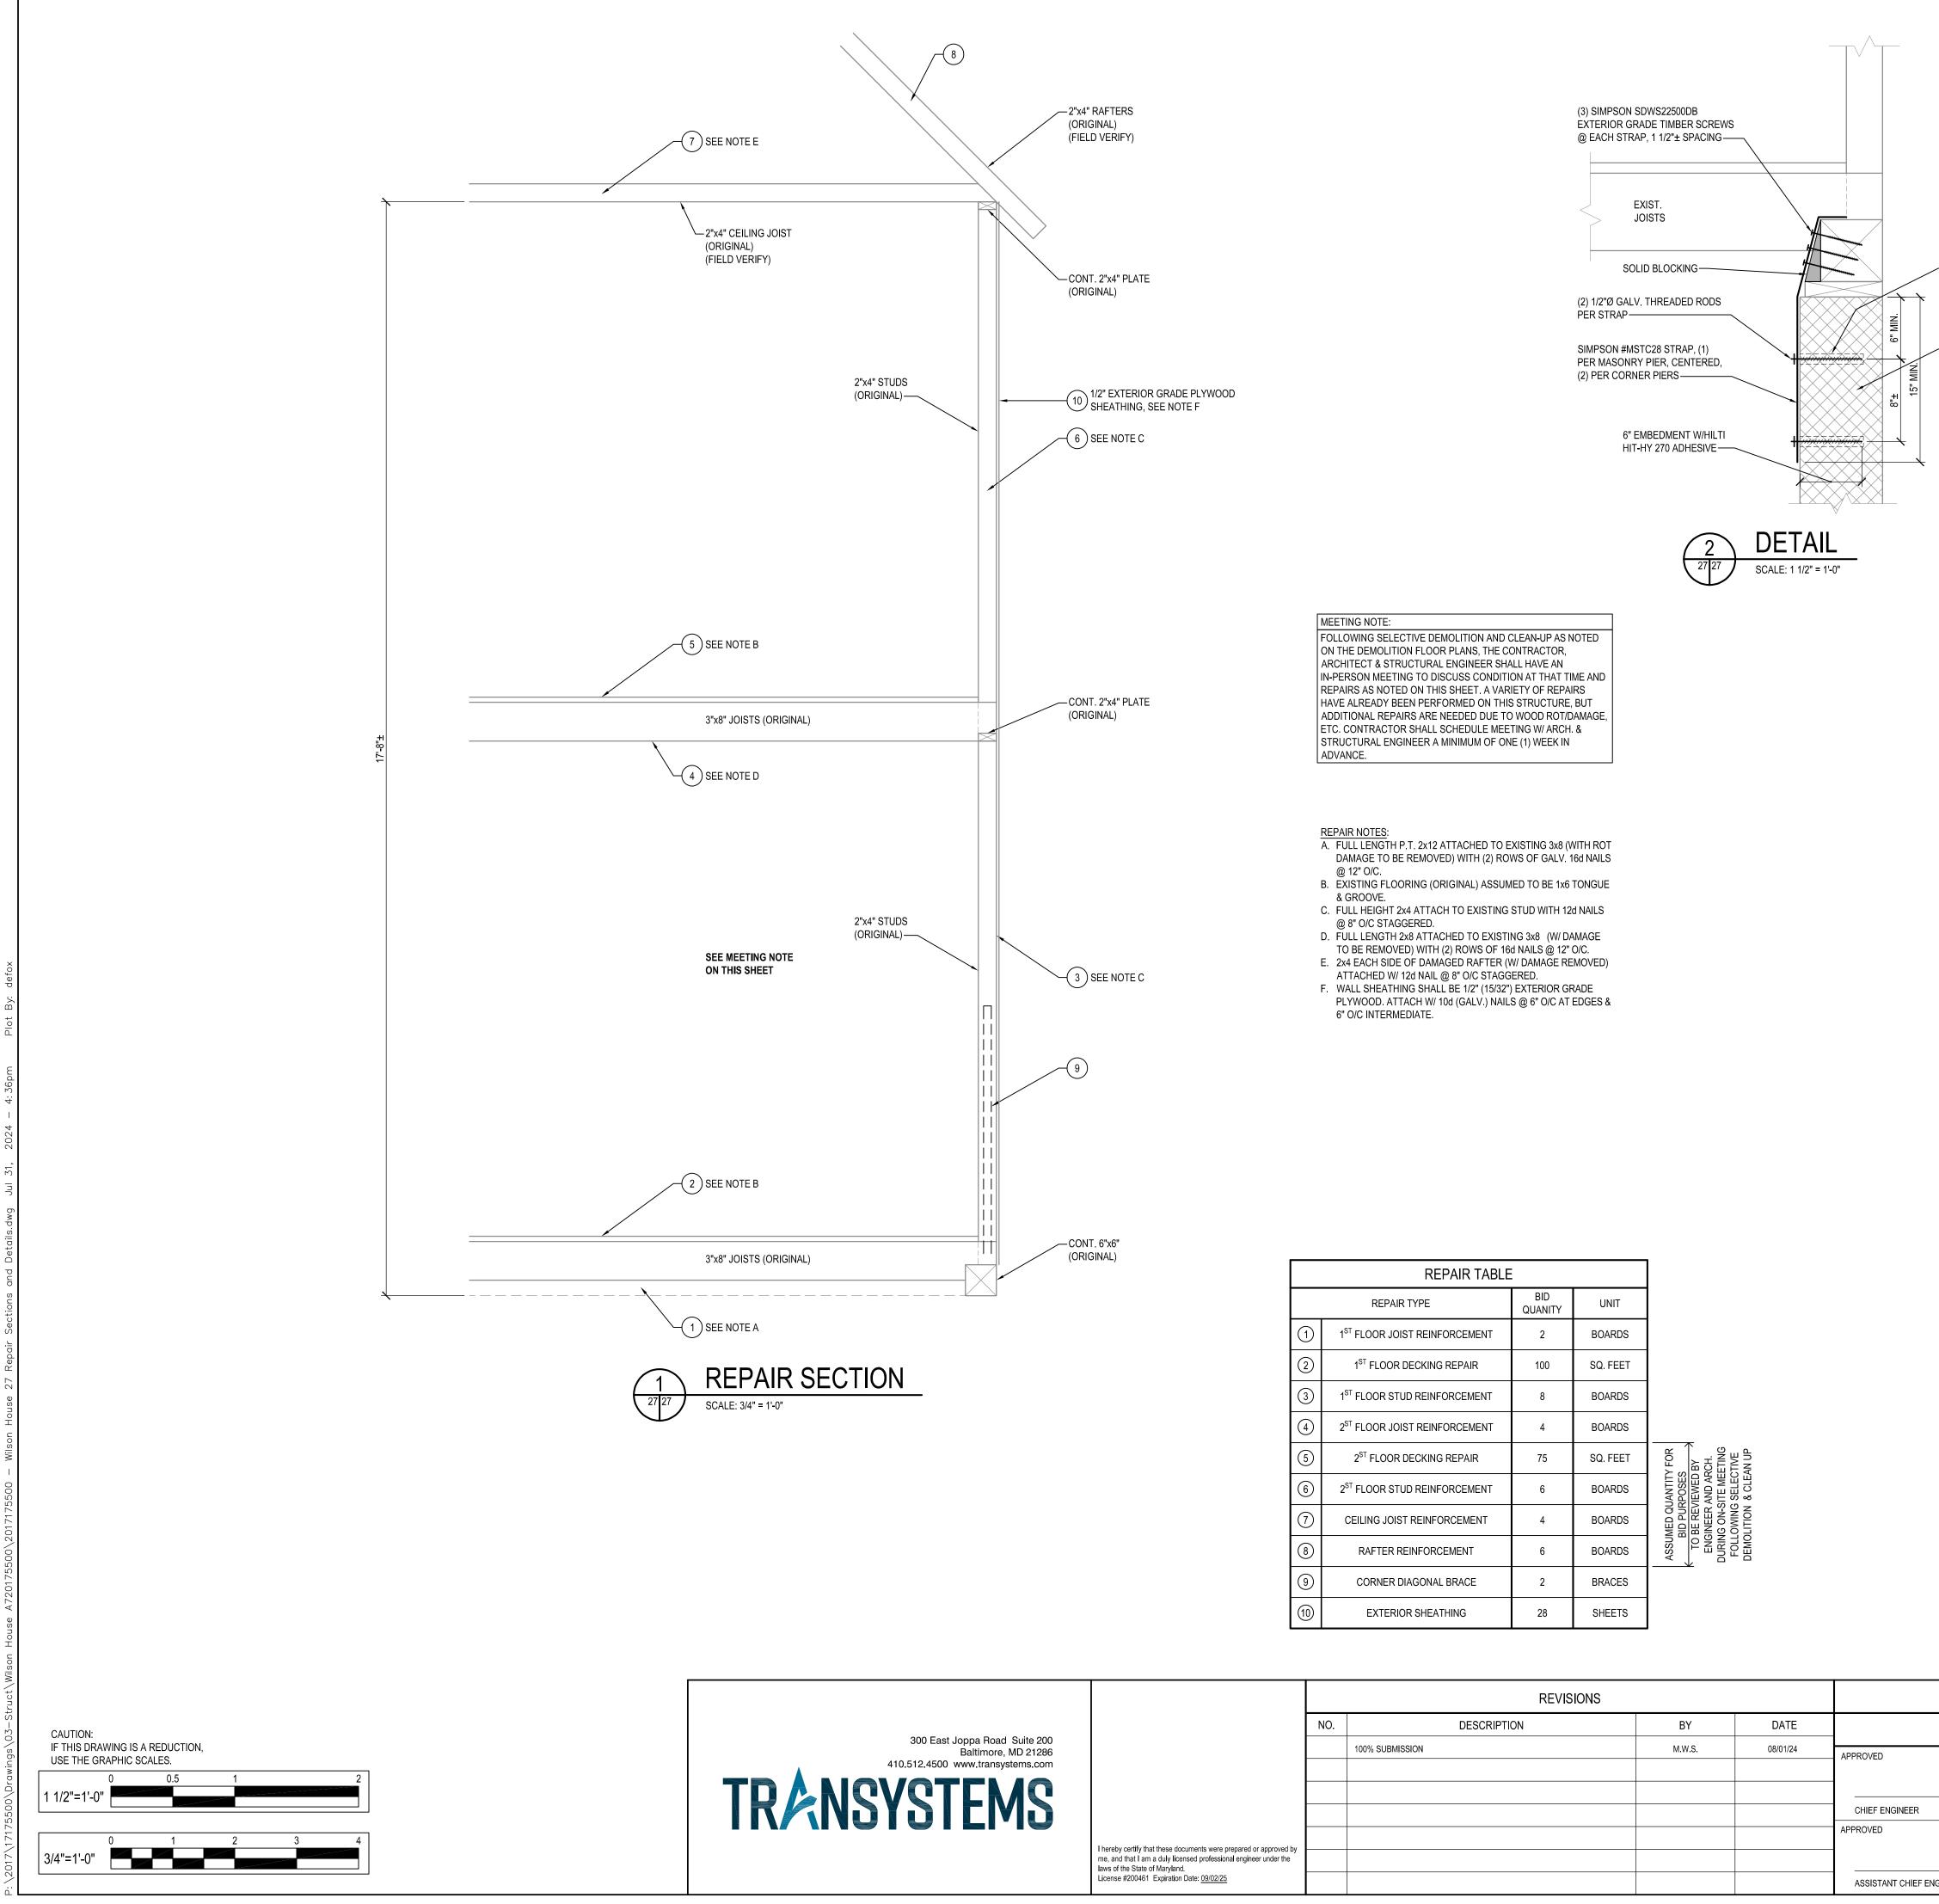


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CHIEF, RIGHT-OF-WAY

PARTIAL FRAMING PLANS




	REPAIR TABLE							
	REPAIR TYPE BID UNIT QUANITY							
(1 ST FLOOR JOIST REINFORCEMENT	2	BOARDS					
2	1 ST FLOOR DECKING REPAIR	100	SQ. FEET					
3	1 ST FLOOR STUD REINFORCEMENT	8	BOARDS					
4	2 ST FLOOR JOIST REINFORCEMENT	4	BOARDS					
5	2 ST FLOOR DECKING REPAIR	75	SQ. FEET					
6	2 ST FLOOR STUD REINFORCEMENT	6	BOARDS					
7	CEILING JOIST REINFORCEMENT	4	BOARDS					
8	RAFTER REINFORCEMENT	6	BOARDS					
9	CORNER DIAGONAL BRACE	2	BRACES					
(10)	EXTERIOR SHEATHING	28	SHEETS					

ASSISTANT CHIEF ENGINEER

- SCREEN TUBE AS REQUIRED


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DATE	APPROVED DATE	SHEET NO. 27 OF 29	REPAIR SECTIONS AND DETAILS	
		PROJECT NO.: P573200	REFAIR SECTIONS AND DETAILS	
	CHIEF, RIGHT-OF-WAY	CONTRACT NO.: P573201		
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						APPROVED
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	License #200461 Expiration Date: 09/02/25					ASSISTANT CHIEF ENGINEER

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	PROJECT MANAGER	CHECKED BY: M.W.S.				
DATE	APPROVED DATE	SHEET NO. 28 OF 29	SECTIONS AND DETAILS			
		PROJECT NO.: P573200	SECTIONS AND DETAILS			
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	License #200461 Expiration Date: <u>09/02/25</u>					ASSISTANT CHIEF ENGINEER
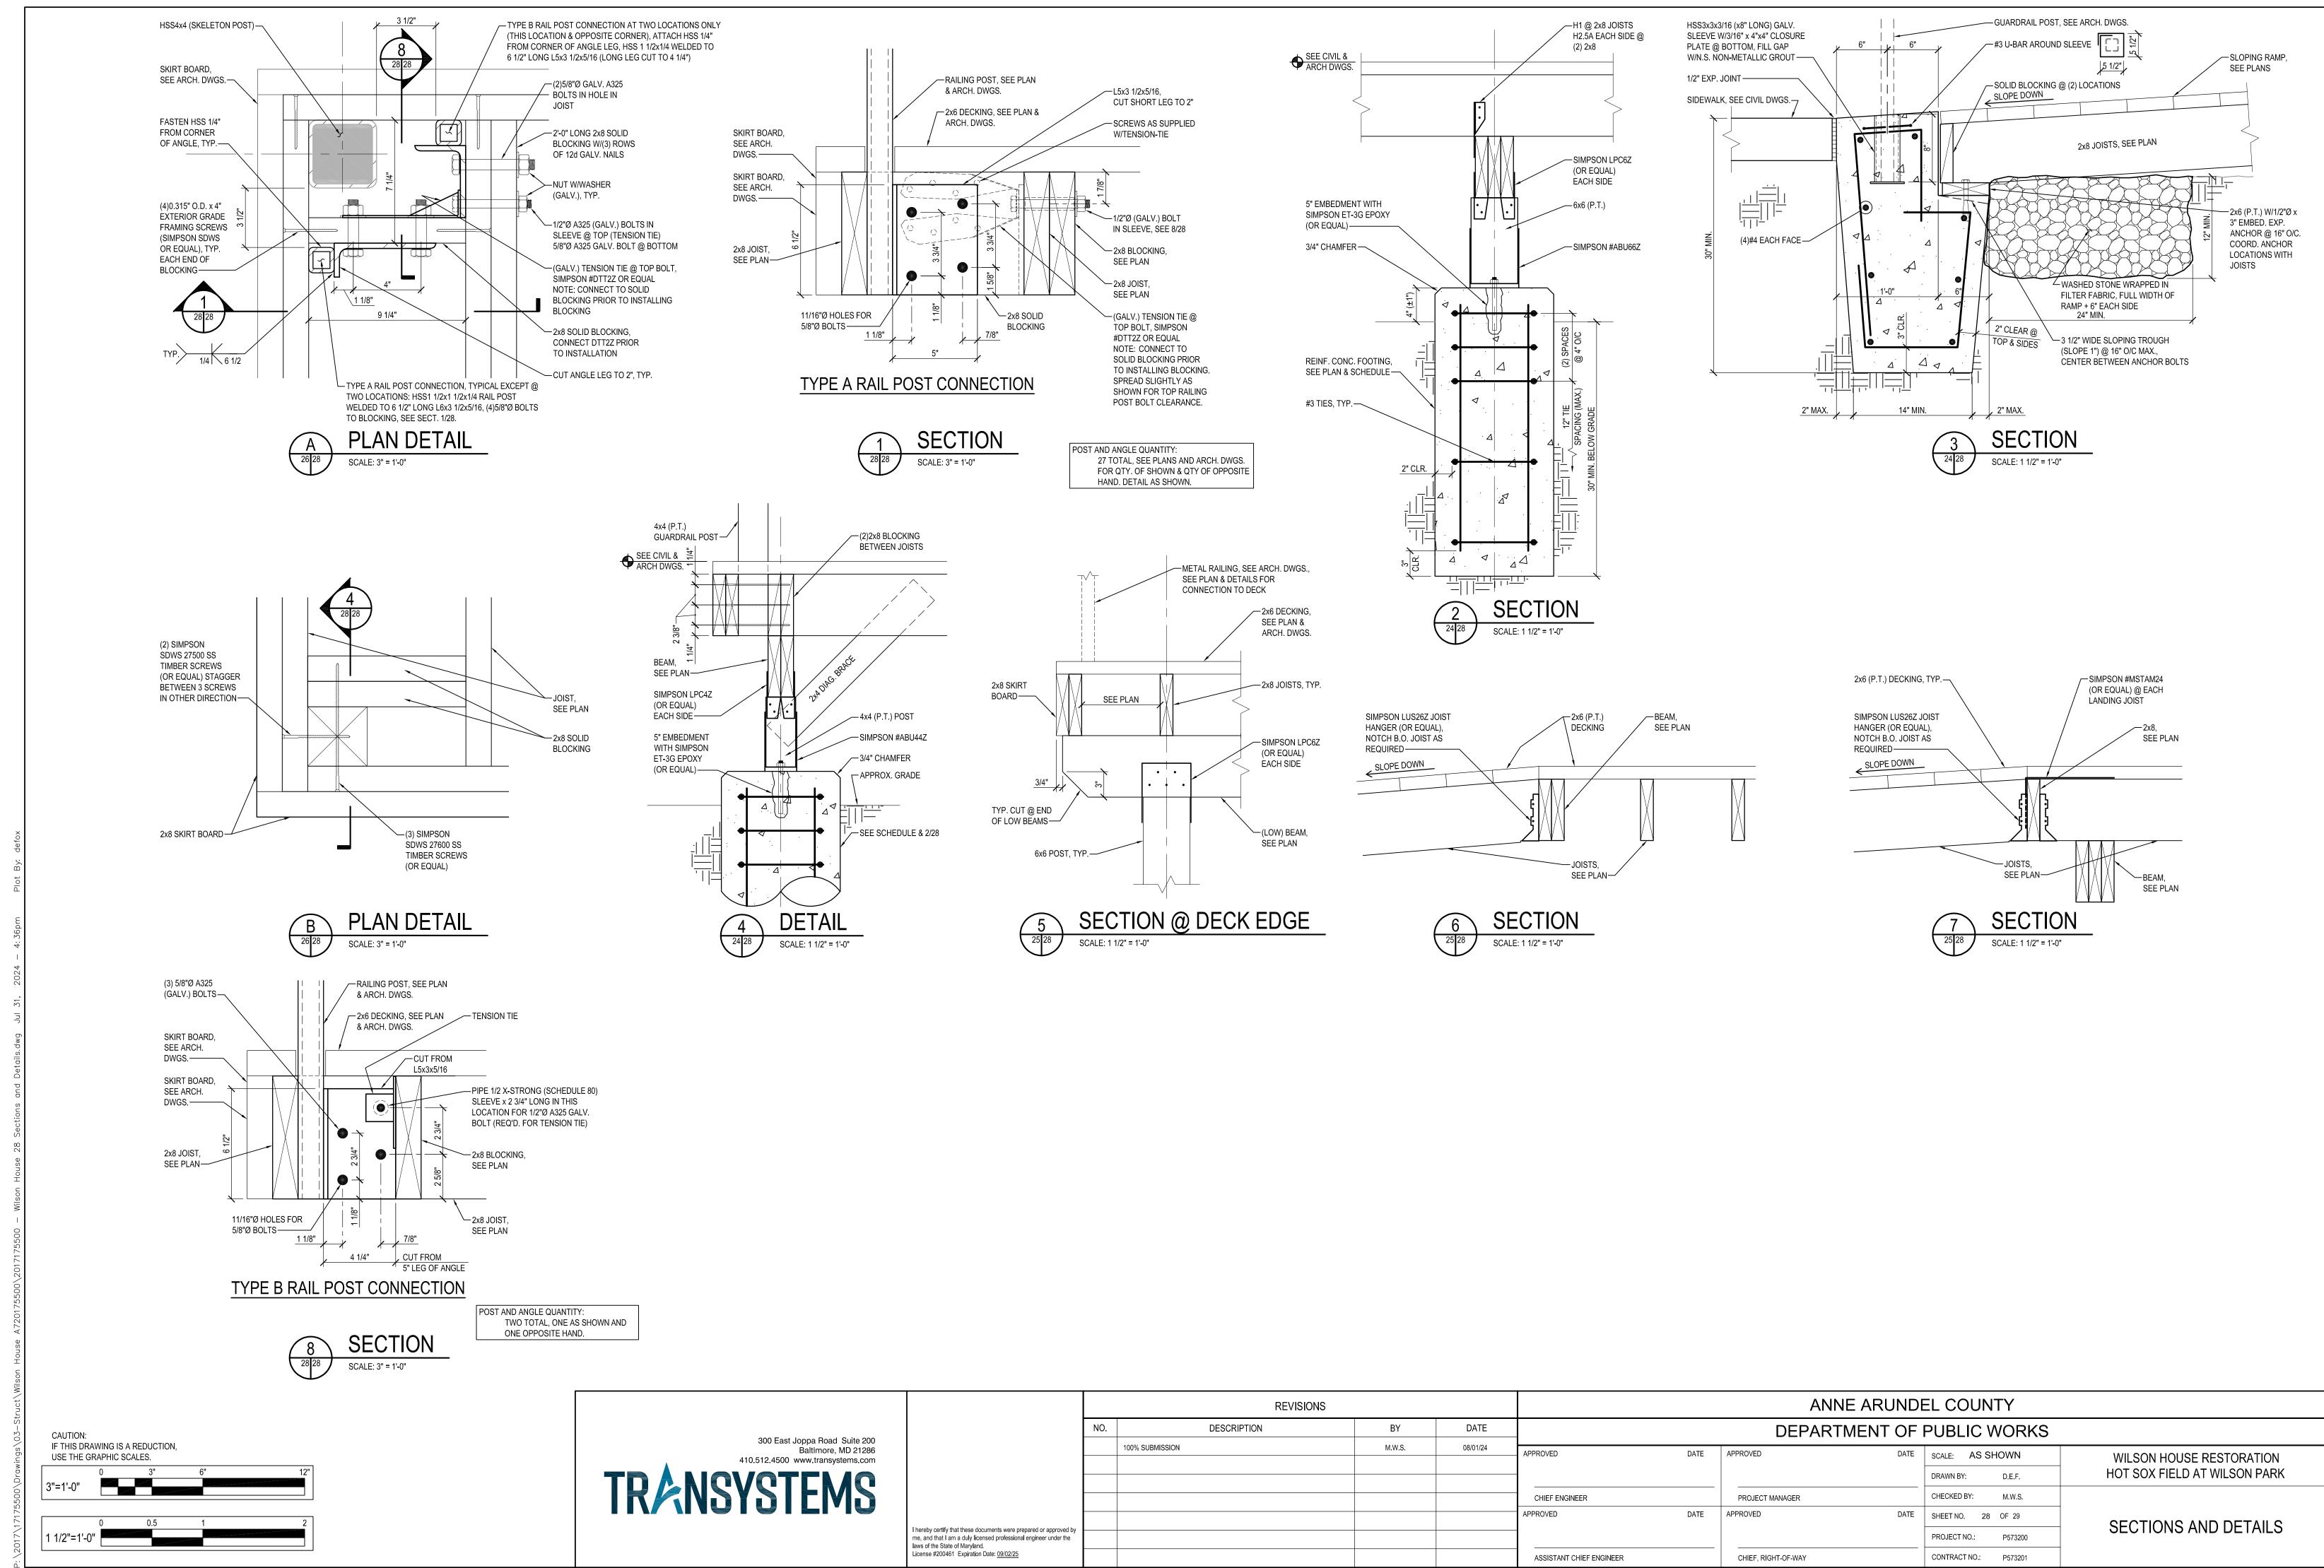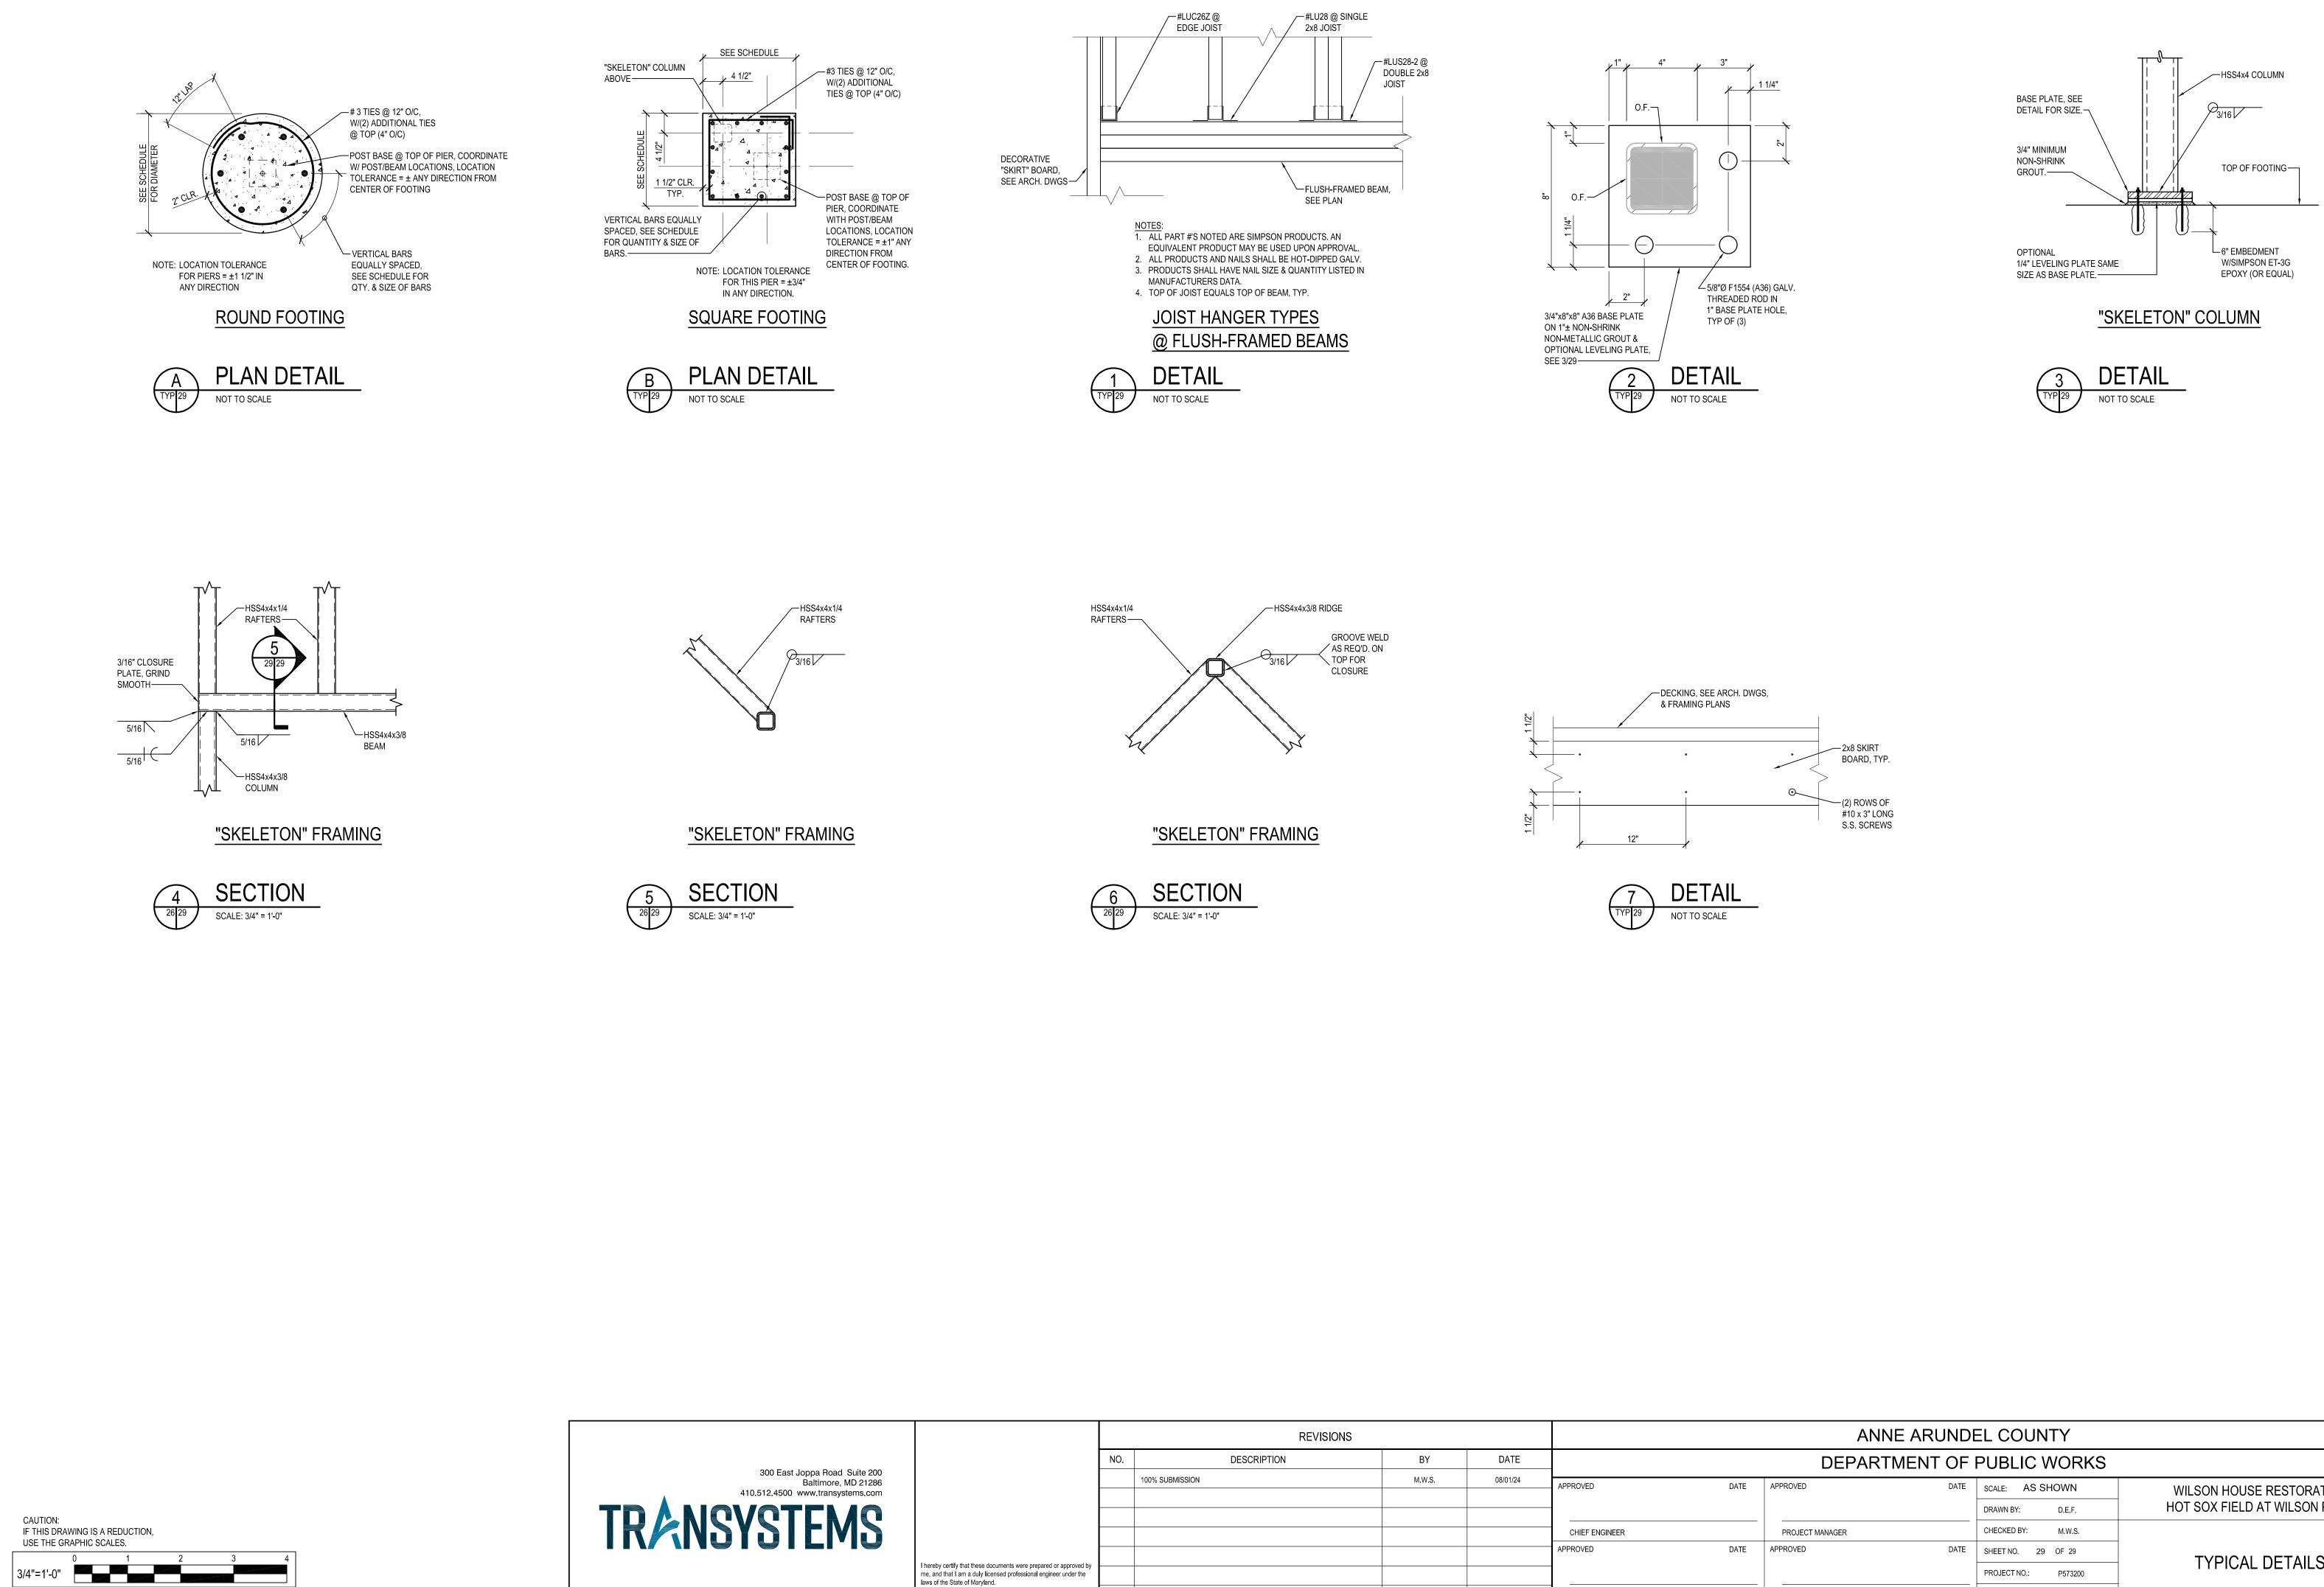
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		DRAWN BY: D.E.F.	HOT SOX FIELD AT WILSON PARK		
	PROJECT MANAGER	CHECKED BY: M.W.S.			
DATE	APPROVED DATE	SHEET NO. 29 OF 29	TYPICAL DETAILS		
		PROJECT NO.: P573200			
ER	CHIEF, RIGHT-OF-WAY	CONTRACT NO.: P573201			