HISTORIC LONDON TOWN AND GARDEN SITE IMPROVEMENTS

BEFORE YOU DIG CALL 1-800-257-7777 OR DIAL 811



DEPARTMENT OF PUBLIC WORKS

ANNE ARUNDEL COUNTY, MARYLAND

PROJECT NO. P468700 PROPOSAL NO. P468717

OCTOBER 2023

REACH 1

LOCATION MAP

LEGEND

TRAVERSE POINT

EX. PROPERTY LINE

EX. MAJOR CONTOUR

EX. MINOR CONTOUR

ZONE AE

EX. BULKHEAD

EX. CONCRETE

EX. SIGN

EX. MEAN HIGH WATER (MHW)

EX. MEAN LOW WATER (MLW)

EX. 100-YR FEMA FLOODPLAIN

EX. 100-YR FEMA FLOODPLAIN

EX. 100' CRITICAL AREA BUFFER

EX. STONE REVETMENT/GROIN

EX. OVERHEAD ELECTRIC CABLE

EX. TREE

EX. PIER TO REMAIN

EX. PILE TO REMAIN

EX. PIER TO BE REMOVED

EX. PILE TO BE REMOVED

PR. MAJOR CONTOUR

PR. MINOR CONTOUR

PR. STONE BREAKWATER

PR. LOW-PROFILE SILL

PR. COASTAL SHRUBS

PR. LOW MARSH PLANTINGS

PR. HIGH MARSH PLANTINGS

PR. FIXED PIER

PR. TIMBER PILE

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GENERAL CONSTRUCTION NOTES

- ALL CONSTRUCTION SHALL BE IN ACCORDANCE WITH ANNE ARUNDEL COUNTY STANDARD SPECIFICATIONS AND/OR DETAILS FOR CONSTRUCTION.
- THE EXISTING UTILITIES AND OBSTRUCTIONS SHOWN ARE FROM THE BEST AVAILABLE RECORDS AND SHALL BE VERIFIED BY THE CONTRACTOR TO HIS SATISFACTION PRIOR TO CONSTRUCTION. NECESSARY PRECAUTIONS SHALL BE TAKEN BY THE CONTRACTOR TO PROTECT EXISTING SERVICES AND MAINS AND ANY DAMAGE TO THEM SHALL BE REPAIRED IMMEDIATELY AT HIS OWN
- THE CONTRACTOR SHALL CONTACT "MISS UTILITY" AT 1-800-257-7777 A MINIMUM OF 48 HOURS IN ADVANCE OF ANY EXCAVATION, BORING, PILE DRIVING AND/OR DIGGING FOR THE LOCATION OF GAS, ELECTRIC, TELEPHONE, WATER AND SEWER LINES.
- MECHANICAL EXCAVATION SHALL NOT BE CONDUCTED WITHIN 3 FEET HORIZONTALLY OR WITHIN 2 FEET VERTICALLY OF KNOWN UTILITY LOCATIONS. HAND OR SOFT DIGGING SHALL BE DONE WITHIN THESE LIMITS. UNDERGROUND UTILITIES, ONCE UNCOVERED, SHALL BE PROTECTED FROM BEING STRUCK BY
- IT SHALL BE DISTINCTLY UNDERSTOOD THAT FAILURE TO MENTION SPECIFICALLY ANY WORK WHICH WOULD NATURALLY BE REQUIRED TO COMPLETE THE PROJECT SHALL NOT RELIEVE THE CONTRACTOR OF HIS RESPONSIBILITY TO
- WORK IS TO BE CONFINED TO WITHIN THE LIMITS OF DISTURBANCE SHOWN ON THE SITE PLAN. DEBRIS IN THE NEAR SHORE AREA WILL BE REMOVED AND DISPOSED OF OFF-SITE. AFTER SHORELINE CLEANUP, MATERIALS ARE TO BE BROUGHT TO THE SITE BY EITHER LAND ACCESS OR BY WATER ACCESS AS IT IS SHOWN ON THE PLANS. CONSTRUCTION WILL BE COMPLETED BY CLEANING UP THE WORK AREA, REMOVING TEMPORARY ACCESS, RAKING, FERTILIZING, SEEDING AND MULCHING DISTURBED AREAS.
- DISTURBANCES THAT DO NOT DRAIN TO A SEDIMENT CONTROL DEVICE SHALL BE STABILIZED BY THE END OF THE WORKDAY. NO MORE AREA SHALL BE DISTURBED THAN CAN BE STABILIZED BY THE END OF THE WORKDAY. NO DISTURBED AREA SHALL BE LEFT UNSTABILIZED OVERNIGHT UNLESS THE RUNOFF IS DIRECTED TO AN APPROVED SEDIMENT CONTROL DEVICE. SLOPES SHALL BE STABILIZED IMMEDIATELY WITH TOPSOIL, SEED AND EROSION CONTROL MATTING (IF REQUIRED). SEE NOTE 13.
- ALL STONE USED FOR THE PROTECTIONS WORK SHALL BE DURABLE QUARRIED STONE. THE STONE SHALL BE HARD AND ANGULAR, FREE FROM EITHER LAMINATIONS, WEAK CLEAVAGES, OR UNDESIRABLE WEATHERING, AND OF SUCH CHARACTER THAT IT WILL NOT DISINTEGRATE FROM THE ACTION OF AIR, SALT, WATER, OR HANDLING. SEDIMENTARY STONE WILL GENERALLY BE UNACCEPTABLE. INDIVIDUAL STONES SHALL BE RECTANGULAR IN CROSS SECTION AND FREE FROM THIN. SLABBY PIECES HAVING A MAXIMUM DIMENSION OF NO MORE THAN THREE AND ONE-HALF TIMES THE MINIMUM DIMENSION. ALL STONE SHALL BE SUPPLIED FROM THE SAME QUARRY.
- THE WORK INSTALLED AS A PART OF THE PROJECT WILL CONTAIN NO FAULTY MATERIALS, OR ANY CARELESS, OR UNSKILLED WORKMANSHIP
- 10. THE CONTRACTOR SHALL CORRECT, REPAIR, OR REMOVE AND REPLACE WITH PROPER WORK AT NO COST TO THE COUNTY ANY WORK FOUND NOT TO BE AS PER THE GUARANTEE. THE CONTRACTOR SHALL ALSO MAKE GOOD ALL DAMAGES CAUSED TO OTHER WORK OR MATERIALS IN THE PROCESS OF FULFILLING THE GUARANTEE.
- 11. CONTRACTOR MAY UTILIZE STOCKPILE AREAS AS DELINEATED ON PLANS.


12.1. END OF THE WORK DAY FOR AREAS WITHIN WATERWAYS.

- 12. ALL DISTURBED AREAS SHALL HAVE PERMANENT OR TEMPORARY STABILIZATION COMPLETED WITHIN:
- 12.2. THREE CALENDAR DAYS ON SLOPES GREATER THAN 3:1 AND TO THE SURFACE OF ALL PERIMETER SEDIMENT CONTROLS. 12.3. SEVEN CALENDAR DAYS AS TO ALL OTHER DISTURBED OR GRADED AREAS.
- 13. ALL DISTURBED AREAS WITH SLOPES GREATER THAN 3:1 SHALL BE STABILIZED WITH TEMPORARY SOIL STABILIZATION MATTING THAT HAS A SUFFICIENT DESIGN SHEAR STRESS FOR THE APPLICATION OR AS SHOWN ON THE APPROVED SEDIMENT AND EROSION CONTROL PLANS.
- 14. ALL ROADS SHALL BE CLEANED AND CLEARED BY THE END OF EACH WORK DAY. ANY MUD OR ROCKS TRACKED ON THE ROADWAYS SHALL BE SWEPT BEFORE THE END OF EACH WORK DAY.

15. ALL STAKING, RESTAKING, AND CUT SHEETS SHALL BE PERFORMED BY A

- REGISTERED LAND SURVEYOR OR PROFESSIONAL ENGINEER AT THE 16. ALL CONSTRUCTION TO BE PERFORMED IN ACCORDANCE WITH STATE OF
- MARYLAND OCCUPATIONAL SAFETY LAWS.
- 17. CONTRACTOR MUST ENSURE THAT COPIES OF FEDERAL, STATE, AND COUNTY PERMITS ARE POSTED ON SITE PRIOR TO THE START OF ANY WORK.
- 18. CONTRACTOR SHALL RESTORE ALL AREAS IMPACTED BY CONSTRUCTION ACTIVITY. THIS SHALL INCLUDE BUT NOT LIMITED TO GRASS AREAS, ROADS, AND PAVED AREAS, ETC.

100 YR FLOOD ELEV. (ZONE VE & AE)

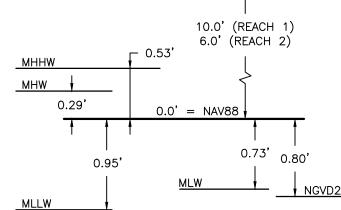

DATUM CONVERSIONS

DATUM COMPARISON BASED ON NATIONAL OCEANIC AND ATMOSPHERIC ADMINISTRATION (NOAA) VDATUM FROM SITE LOCATION (LONG) -76°32'26.9", (LAT) 38°56'27.4".

GENERAL SITE NOTES

- . MEAN TIDAL RANGE IS APPROXIMATELY 0.97 FEET BASED UPON NOAA TIDE STATION 8575512 IN
- TOPOGRAPHIC AND HYDROGRAPHIC SURVEY WAS PERFORMED BY BAYLAND CONSULTANTS AND DESIGNERS, INC. ON MARCH 20-21, 2023. SURVEY PERFORMED WITH REAL TIME KINEMATIC (RTK) GLOBAL POSITIONING SYSTEM (GPS).
- 3. HORIZONTAL CONTROL IS BASED ON THE MARYLAND COORDINATE SYSTEM (NAD83/1991).
- 4. SOUNDINGS ARE IN FEET AND REFER TO THE NORTH AMERICAN VERTICAL DATUM OF 1988
- 5. VERTICAL CONTROL IS BASED ON THE NORTH AMERICAN VERTICAL DATUM OF 1988 (NAVD'88). CONTROL POINTS SET BY BAYLAND ON MARCH 20-21, 2023.
- FLEVATION DESCRIPTION 464399.1475 1442939.041 35.9833 YELLOW PLASTIC CAP TPS# 2 464255.8473 1442992.622 37.6773 YELLOW PLASTIC CAP
- 6. CONTOURS SHOWN OUTSIDE OF LIMIT OF WORK ARE BASED ON 2017 COUNTY LIDAR TOPOGRAPHY AND BATHYMETRY. BASEMAP COMPILED FROM ANNE ARUNDEL COUNTY 2020 PLANIMETRICS AND IMAGERY.
 - 7. PROPERTY LINES SHOWN ARE BASED ON ANNE ARUNDEL COUNTY CADASTRAL DATA.
- 8. THE PROJECT SITE IS WITHIN FEMA FLOODPLAIN LIMITS (ZONE VE). MAP #24003C0233F.
- 9. THE PROJECT SITE IS WITHIN RESOURCE CONSERVATION AREA (RCA) CHESAPEAKE BAY CRITICAL
- 10. THE PROJECT IS WITHIN THE 100' CRITICAL AREA BUFFER MODIFICATION AREA.
- 11. MARYLAND WETLANDS LICENSE NO. XX-WL-XXXX. U.S. ARMY CORPS OF ENGINEERS PERMIT -MARYLAND STATE PROGRAMMATIC GENERAL PERMIT (TRACKING NO. NAB-20XX-XXXXX).
- 12. ANNE ARUNDEL SOIL CONSERVATION DISTRICT (AASCD) NO. TBD; G.P. NO. TBD.

CONSULTANT'S CERTIFICATION

THE DEVELOPER'S PLAN TO CONTROL SILT AND EROSION IS ADEQUATE TO CONTAIN THE SILT AND EROSION ON THE PROPERTY COVERED BY THE PLAN. I CERTIFY THAT THIS PLAN OF EROSION AND SEDIMENT CONTROL REPRESENTS A PRACTICAL AND WORKABLE PLAN BASED ON MY PERSONAL KNOWLEDGE OF THIS SITE, AND WAS PREPARED IN ACCORDANCE WITH THE REQUIREMENTS OF THE AASCD PLAN SUBMITTAL GUIDELINES AND THE CURRENT MARYLAND STANDARDS AND SPECIFICATION FOR SOIL EROSION AND SEDIMENT CONTROL. I HAVE REVIEWED THIS EROSION AND SEDIMENT CONTROL PLAN WITH THE OWNER / DEVELOPER

ID P.E. LICE	ENSE NO.: 21194
IAME: SEPE	HR BAHARLOU
TRM NAME:	BAYLAND CONSULTANTS & DESIGNERS, INC.
DDRESS:	7455 NEW RIDGE ROAD, SUITE T
CITY: HANO	VER STATE: MD ZIP CODE: 21076

DDAIDAD INDADIAN

GRADING PERMIT:

PR	OJECT INFORMAT	ION
1.	OWNER/DEVELOPER:	ANNE ARUNDEL COUNTY DPW CONTACT: MEL HARLINSKI
2.	OWNER/DEVELOPER INFORMATION:	2662 RIVA ROAD — 3RD FLOOR ANNAPOLIS, MD 21401
3.	ENGINEER:	BAYLAND CONSULTANTS & DESIGNERS, INC.
4.	ENGINEER INFORMATION:	7455 NEW RIDGE ROAD, SUITE T HANOVER, MARYLAND 21076 PH: 410-694-9401
5.	TAX MAP:	25
6.	PARCEL:	055 271
7.	PLAT REF:	N/A N/A
8.	DEED REF:	2983/829 2979/812
9.	DISTRICT:	03
10.	ZONING:	OS - OPEN SPACE
11.	USE:	EXEMPT
12.	PROPERTY AREA:	238 ACRES
13.	SUBWATERSHED:	MD WESTERN SHORE
14.	WATERSHED:	CHESAPEAKE BAY
15.	WETLAND LICENSE:	XX-WL-XXXX

SHEET LIST TABLE

SHEET	NO.	SHEET TITLE
1		COVER SHEET
2		KEY SHEET
3		EXISTING CONDITIONS & DEMOLITION PLAN
4		EXISTING CONDITIONS & DEMOLITION PLAN
5		EXISTING CONDITIONS & DEMOLITION PLAN
6		EXISTING CONDITIONS & DEMOLITION PLAN
7		SITE PLAN
8		SHORELINE SITE PLAN
9		SITE PLAN
10		SITE PLAN
11		SITE PLAN
12		CROSS SECTIONS
13		PIER DETAILS

STANDARD RESPONSIBILITY NOTES

- a. ALL DEVELOPMENT AND CONSTRUCTION WILL BE DONE IN ACCORDANCE WITH THIS SEDIMENT AND EROSION CONTROL PLAN, AND FURTHER, AUTHORIZE THE RIGHT OF ENTRY FOR PERIODIC ON-SITE EVALUATION BY THE ANNE ARUNDEL SOIL CONSERVATION DISTRICT (AASCD) BOARD OF SUPERVISORS OR THEIR AUTHORIZED
- b. ANY RESPONSIBLE PERSONNEL INVOLVED IN THE CONSTRUCTION PROJECT WILL HAVE A CERTIFICATE OF ATTENDANCE FROM THE MARYLAND DEPARTMENT OF THE ENVIRONMENT'S APPROVED TRAINING PROGRAM FOR THE CONTROL OF SEDIMENT AND EROSION BEFORE BEGINNING THE PROJECT.
- RESPONSIBLE PERSONNEL ON SITE:
- c. IF APPLICABLE, THE APPROPRIATE ENCLOSURE WILL BE CONSTRUCTED AND MAINTAINED ON SEDIMENT BASIN(S) INCLUDED IN THIS PLAN. SUCH STRUCTURE(S) WILL BE IN COMPLIANCE WITH THE ANNE ARUNDEL COUNTY CODE.
- 2. THE DEVELOPER IS RESPONSIBLE FOR THE ACQUISITION OF ALL EASEMENTS, RIGHT AND/OR RIGHTS-OF-WAY THAT MAY BE REQUIRED FOR THE SEDIMENT AND EROSION CONTROL PRACTICES, STORM WATER MANAGEMENT PRACTICES AND THE DISCHARGE OF STORM WATER ONTO OR ACROSS ADJACENT OR DOWNSTREAM PROPERTIES INCLUDED
- 3. FOR INITIAL SOIL DISTURBANCE OR RE-DISTURBANCE, PERMANENT AND/OR TEMPORARY STABILIZATION PER THE AASCD VEGETATIVE ESTABLISHMENT SHALL BE COMPLETED WITHIN THREE CALENDAR DAYS FOR THE SURFACE OF ALL CONTROLS, DIKES, SWALES, DITCHES, PERIMETER SLOPES AND ALL SLOPES GREATER THAN 3 HORIZONTAL TO 1 VERTICAL (3:1); AND SEVEN DAYS FOR ALL OTHER DISTURBED OR GRADED AREAS ON THE PROJECT SITE.
- 4. THE GRADING AND SEDIMENT CONTROL APPROVAL ON THIS PLAN EXTENDS ONLY TO THOSE AREAS WITHIN THE LIMITS OF DISTURBANCE.
- 5. THE APPROVAL OF THIS PLAN FOR SEDIMENT AND EROSION CONTROL DOES NOT RELIEVE THE DEVELOPER/CONSULTANT FROM COMPLYING WITH FEDERAL, STATE OR COUNTY REQUIREMENTS PERTAINING TO ENVIRONMENTAL ISSUES.
- 6. THE DEVELOPER MUST REQUEST THAT THE SEDIMENT AND EROSION CONTROL INSPECTOR APPROVE WORK COMPLETED IN ACCORDANCE WITH THE APPROVED EROSION AND SEDIMENT CONTROL PLAN, THE GRADING OR BUILDING PERMIT, AND THE
- 7. ALL MATERIAL SHALL BE TAKEN TO A SITE WITH AN APPROVED SEDIMENT AND EROSION CONTROL PLAN.
- 8. FIRST PHASE INSPECTION AND APPROVAL OF THE SEDIMENT AND EROSION CONTROL INSPECTOR SHALL BE REQUIRED UPON COMPLETION OF THE INSTALLATION OF EROSION AND SEDIMENT CONTROLS PRIOR TO PROCEEDING WITH ANY OTHER EARTH DISTURBANCE OR GRADING. OTHER BUILDING OR GRADING INSPECTION APPROVALS MAY NOT BE AUTHORIZED UNTIL THE INITIAL APPROVAL BY THE SEDIMENT AND EROSION CONTROL INSPECTOR IS GIVEN, INSPECTION AND PERMITS MAY ALSO REQUIRE THAT AN INSPECTION AND CERTIFICATION OF THE INSTALLATION OF SEDIMENT CONTROL ALSO BE PERFORMED BY A DESIGN PROFESSIONAL PRIOR TO CONSTRUCTION COMMENCING.
- ALL SITES PRIOR TO REMOVAL OF SEDIMENT AND EROSION CONTROLS.

9. APPROVAL FROM THE INSPECTOR MUST BE REQUESTED ON FINAL STABILIZATION OF

10. EXISTING TOPOGRAPHY MUST BE FIELD VERIFIED BY RESPONSIBLE PERSONNEL TO THE SATISFACTION OF THE SEDIMENT CONTROL INSPECTOR PRIOR TO COMMENCING WORK.

SIGNATI	URE OF DEVE	LOPER \ OWNER	DATE:
PRINT:	NAME:		
	TITLE:		
	AFFILIATION:	ANNE ARUNDEL COUNTY DEPARTMENT	OF PUBLIC WORKS
	ADDRESS:	2662 RIVA ROAD, ANNAPOLIS, MARYL	AND 21401
	TELEPHONE	NUMBER:	
	EMAIL ADDRE		

ABBREVIATIONS

- BASELINE BLDG. - BUILDING - CRITICAL AREA BUFFER
- CUBIC YARDS - EXISTING FEATURE, STRUCTURE, OR OBJECT
- GEOGRAPHIC INFORMATION SYSTEM LINEAR FEET - LIMIT OF DISTURBANCE
- MFAN HIGH WATER MEAN LOW WATER PROPOSED
- SQUARE FEET STATION
- TYPICA WATER SURFACE ELEVATION TERRA COTTA

Coay Cand Consultants & Designers, Inc. "Integrating Engineering and Environment"


Phone: (410) 694-9401 7455 New Ridge Road, Suite T Hanover, Maryland 21076 Fax: (410) 694-9405 www.baylandinc.com BAYLAND JOB NO. 5_20002


	ANNE ARUNDEL COUNTY							
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REVIS		APPROVED	DATE	APPROVED	DATE	SCALE:	AS SHOWN	
DATE	BY	-				DESIGNED BY:	DG/DP/JH10/12/23	
						DRAWN BY:	DG/DP/JH10/12/23	\$
		CHIEF ENGINEER		PROJECT MANAGER		CHECKED BY:	AJ/MB/SB10/12/23	\$
		APPROVED	DATE	APPROVED	DATE		HEET NO. 1 OF 13	1
						PROJECT NO.	P468700	1
		ASSISTANT CHIFF FNGINFFR		CHIFF, RIGHT OF WAY		PROPOSAL NO). P468717	


HISTORIC LONDON TOWN AND GARDEN SITE **IMPROVEMENTS**


30% SCHEMATIC DESIGN


COVER SHEET

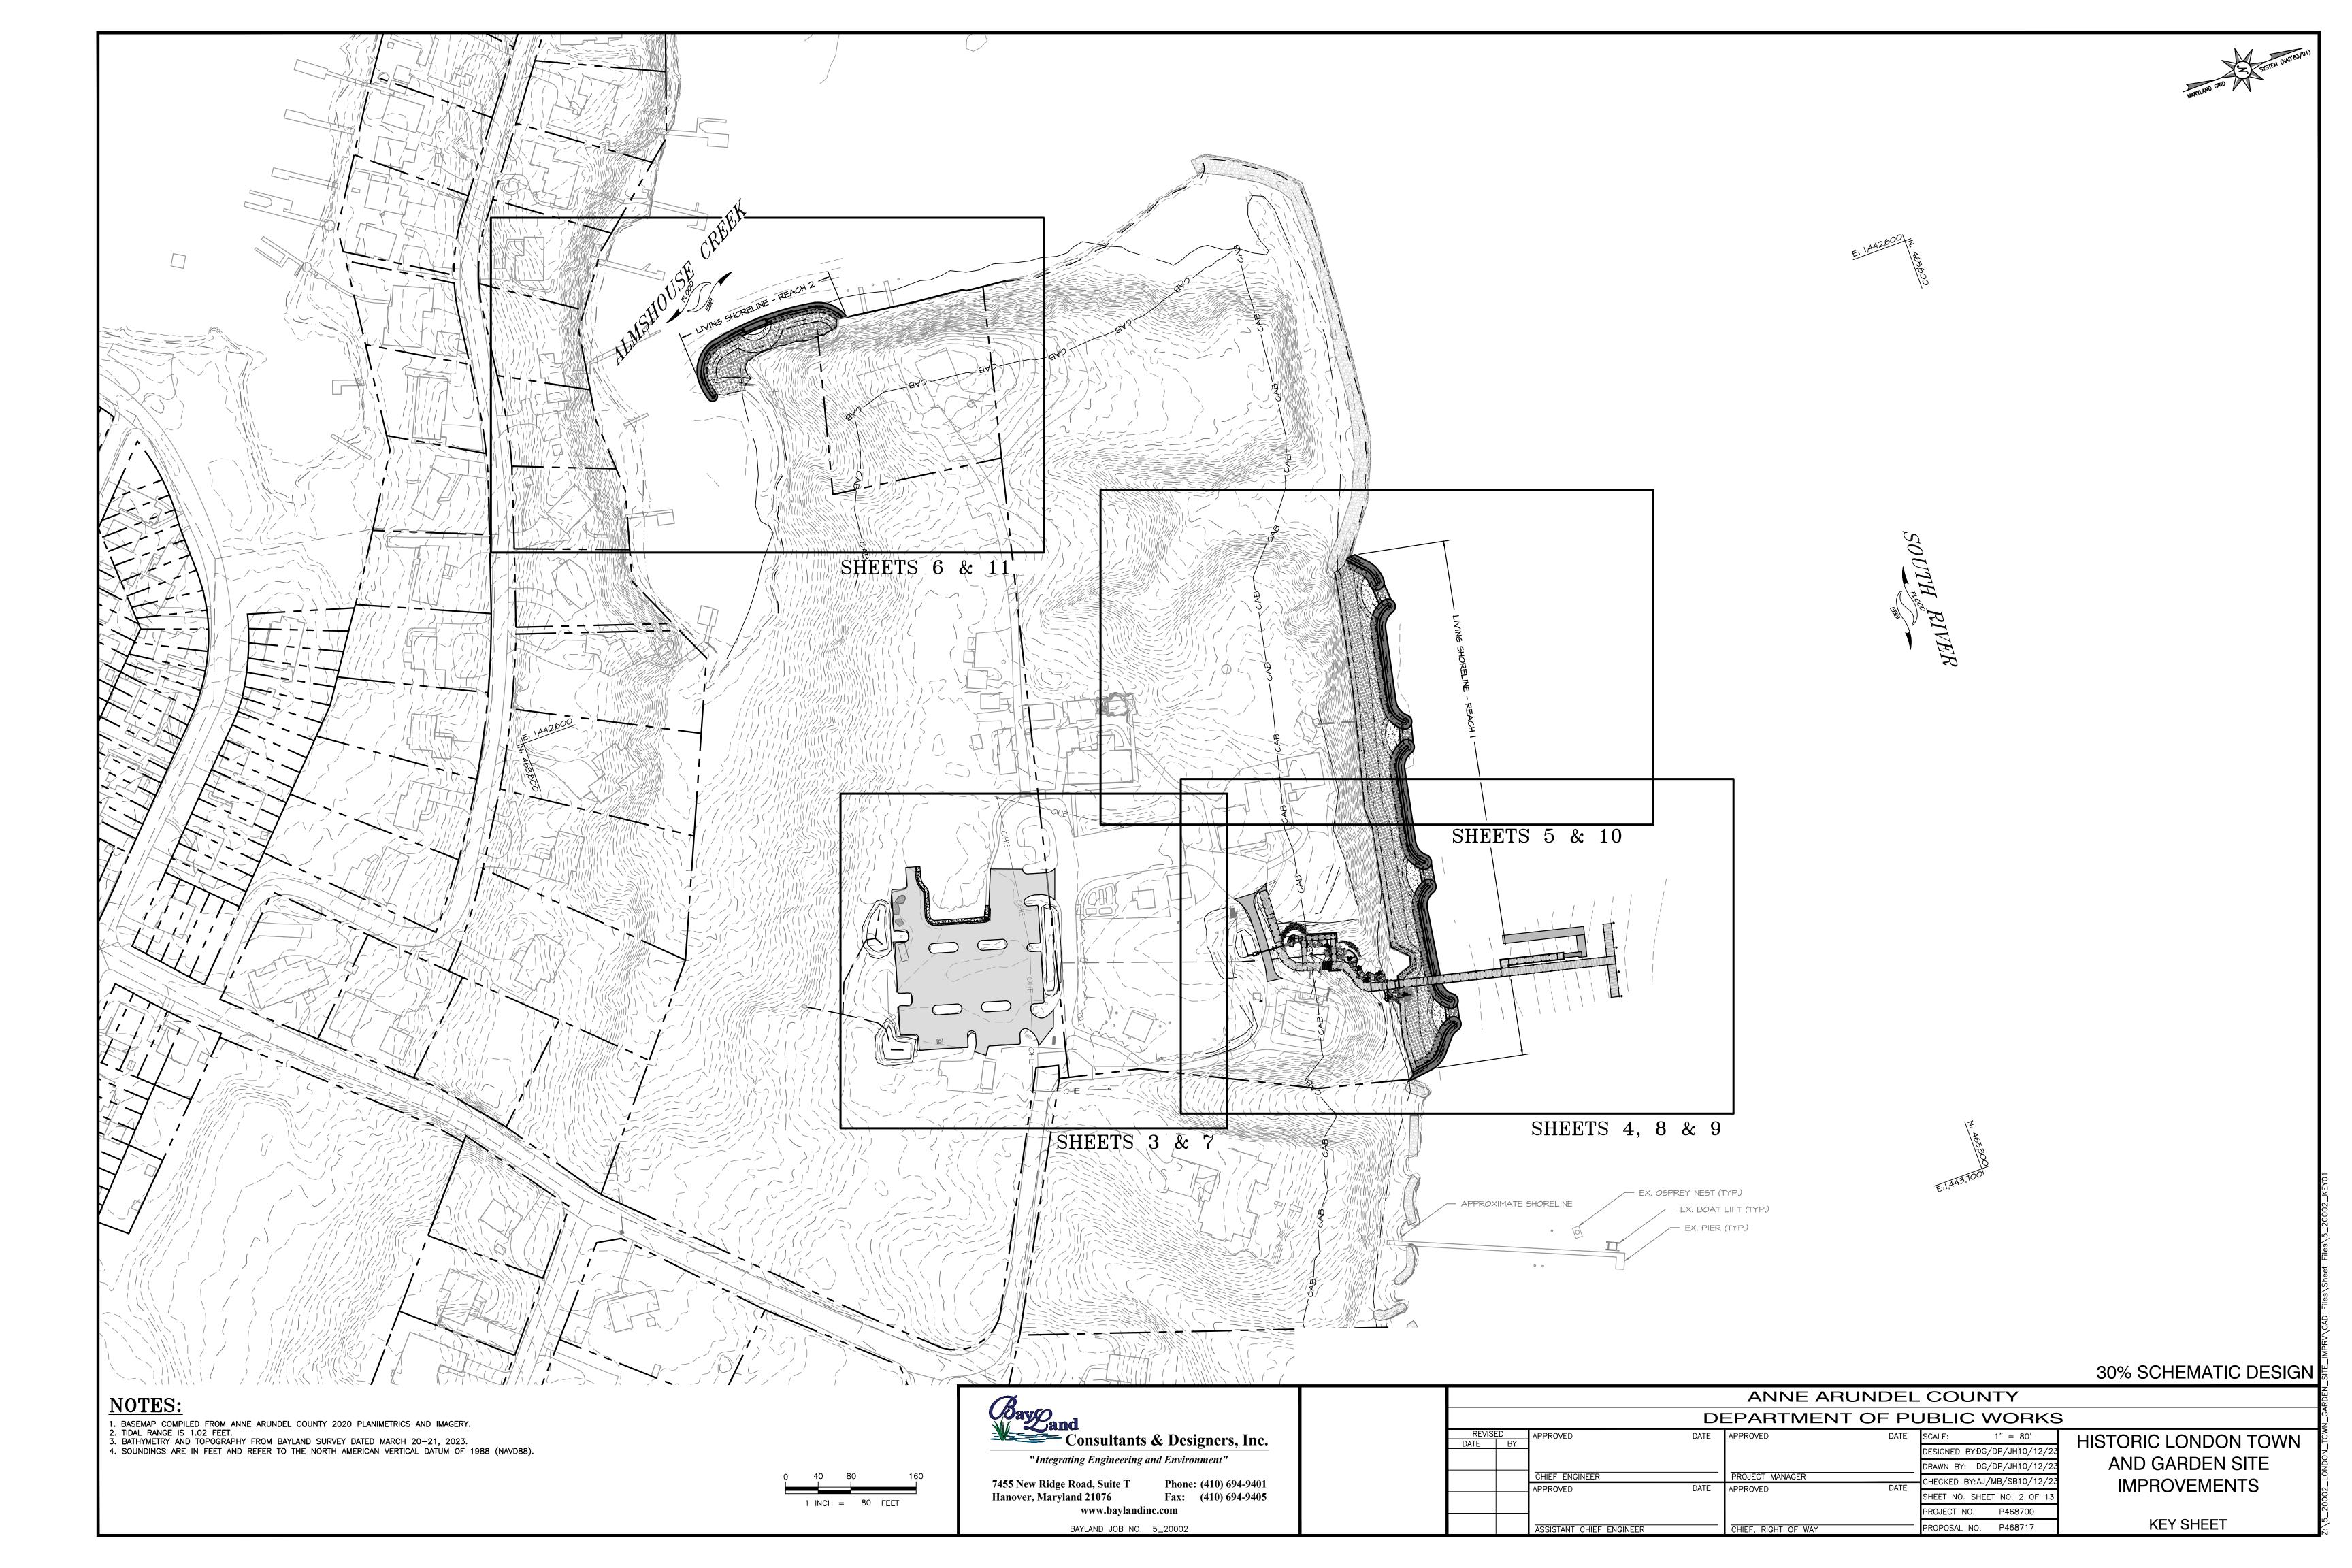


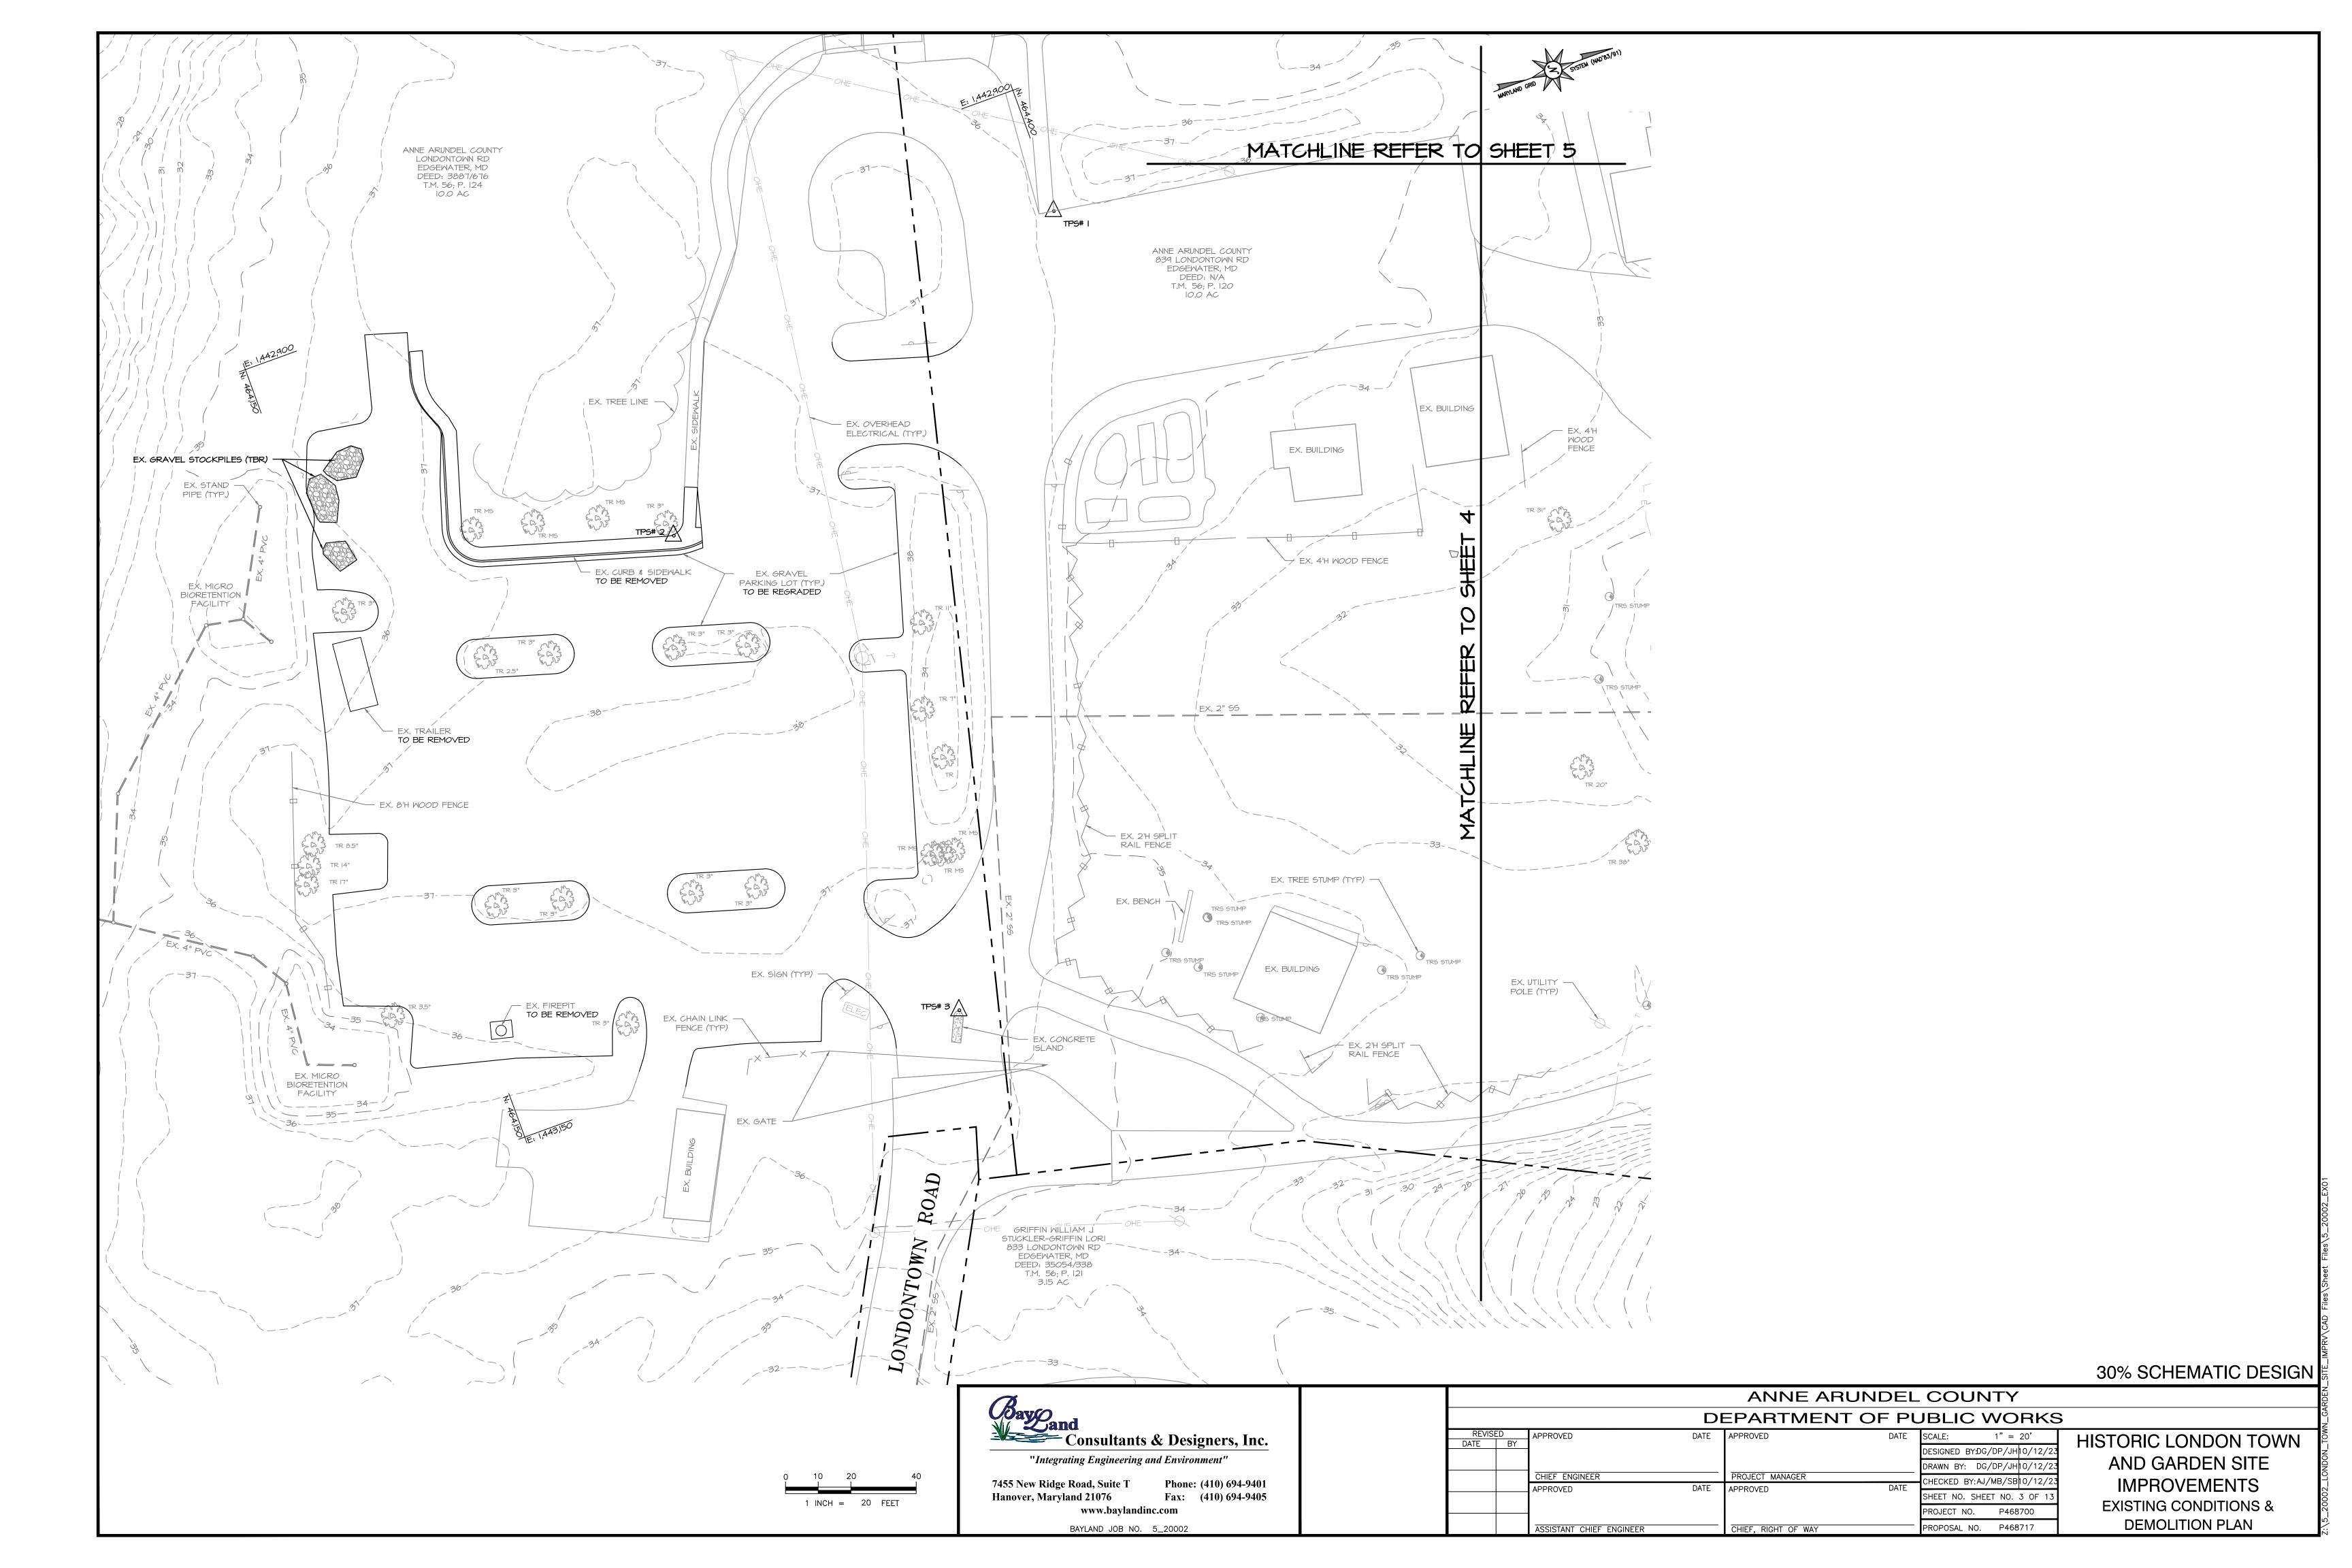


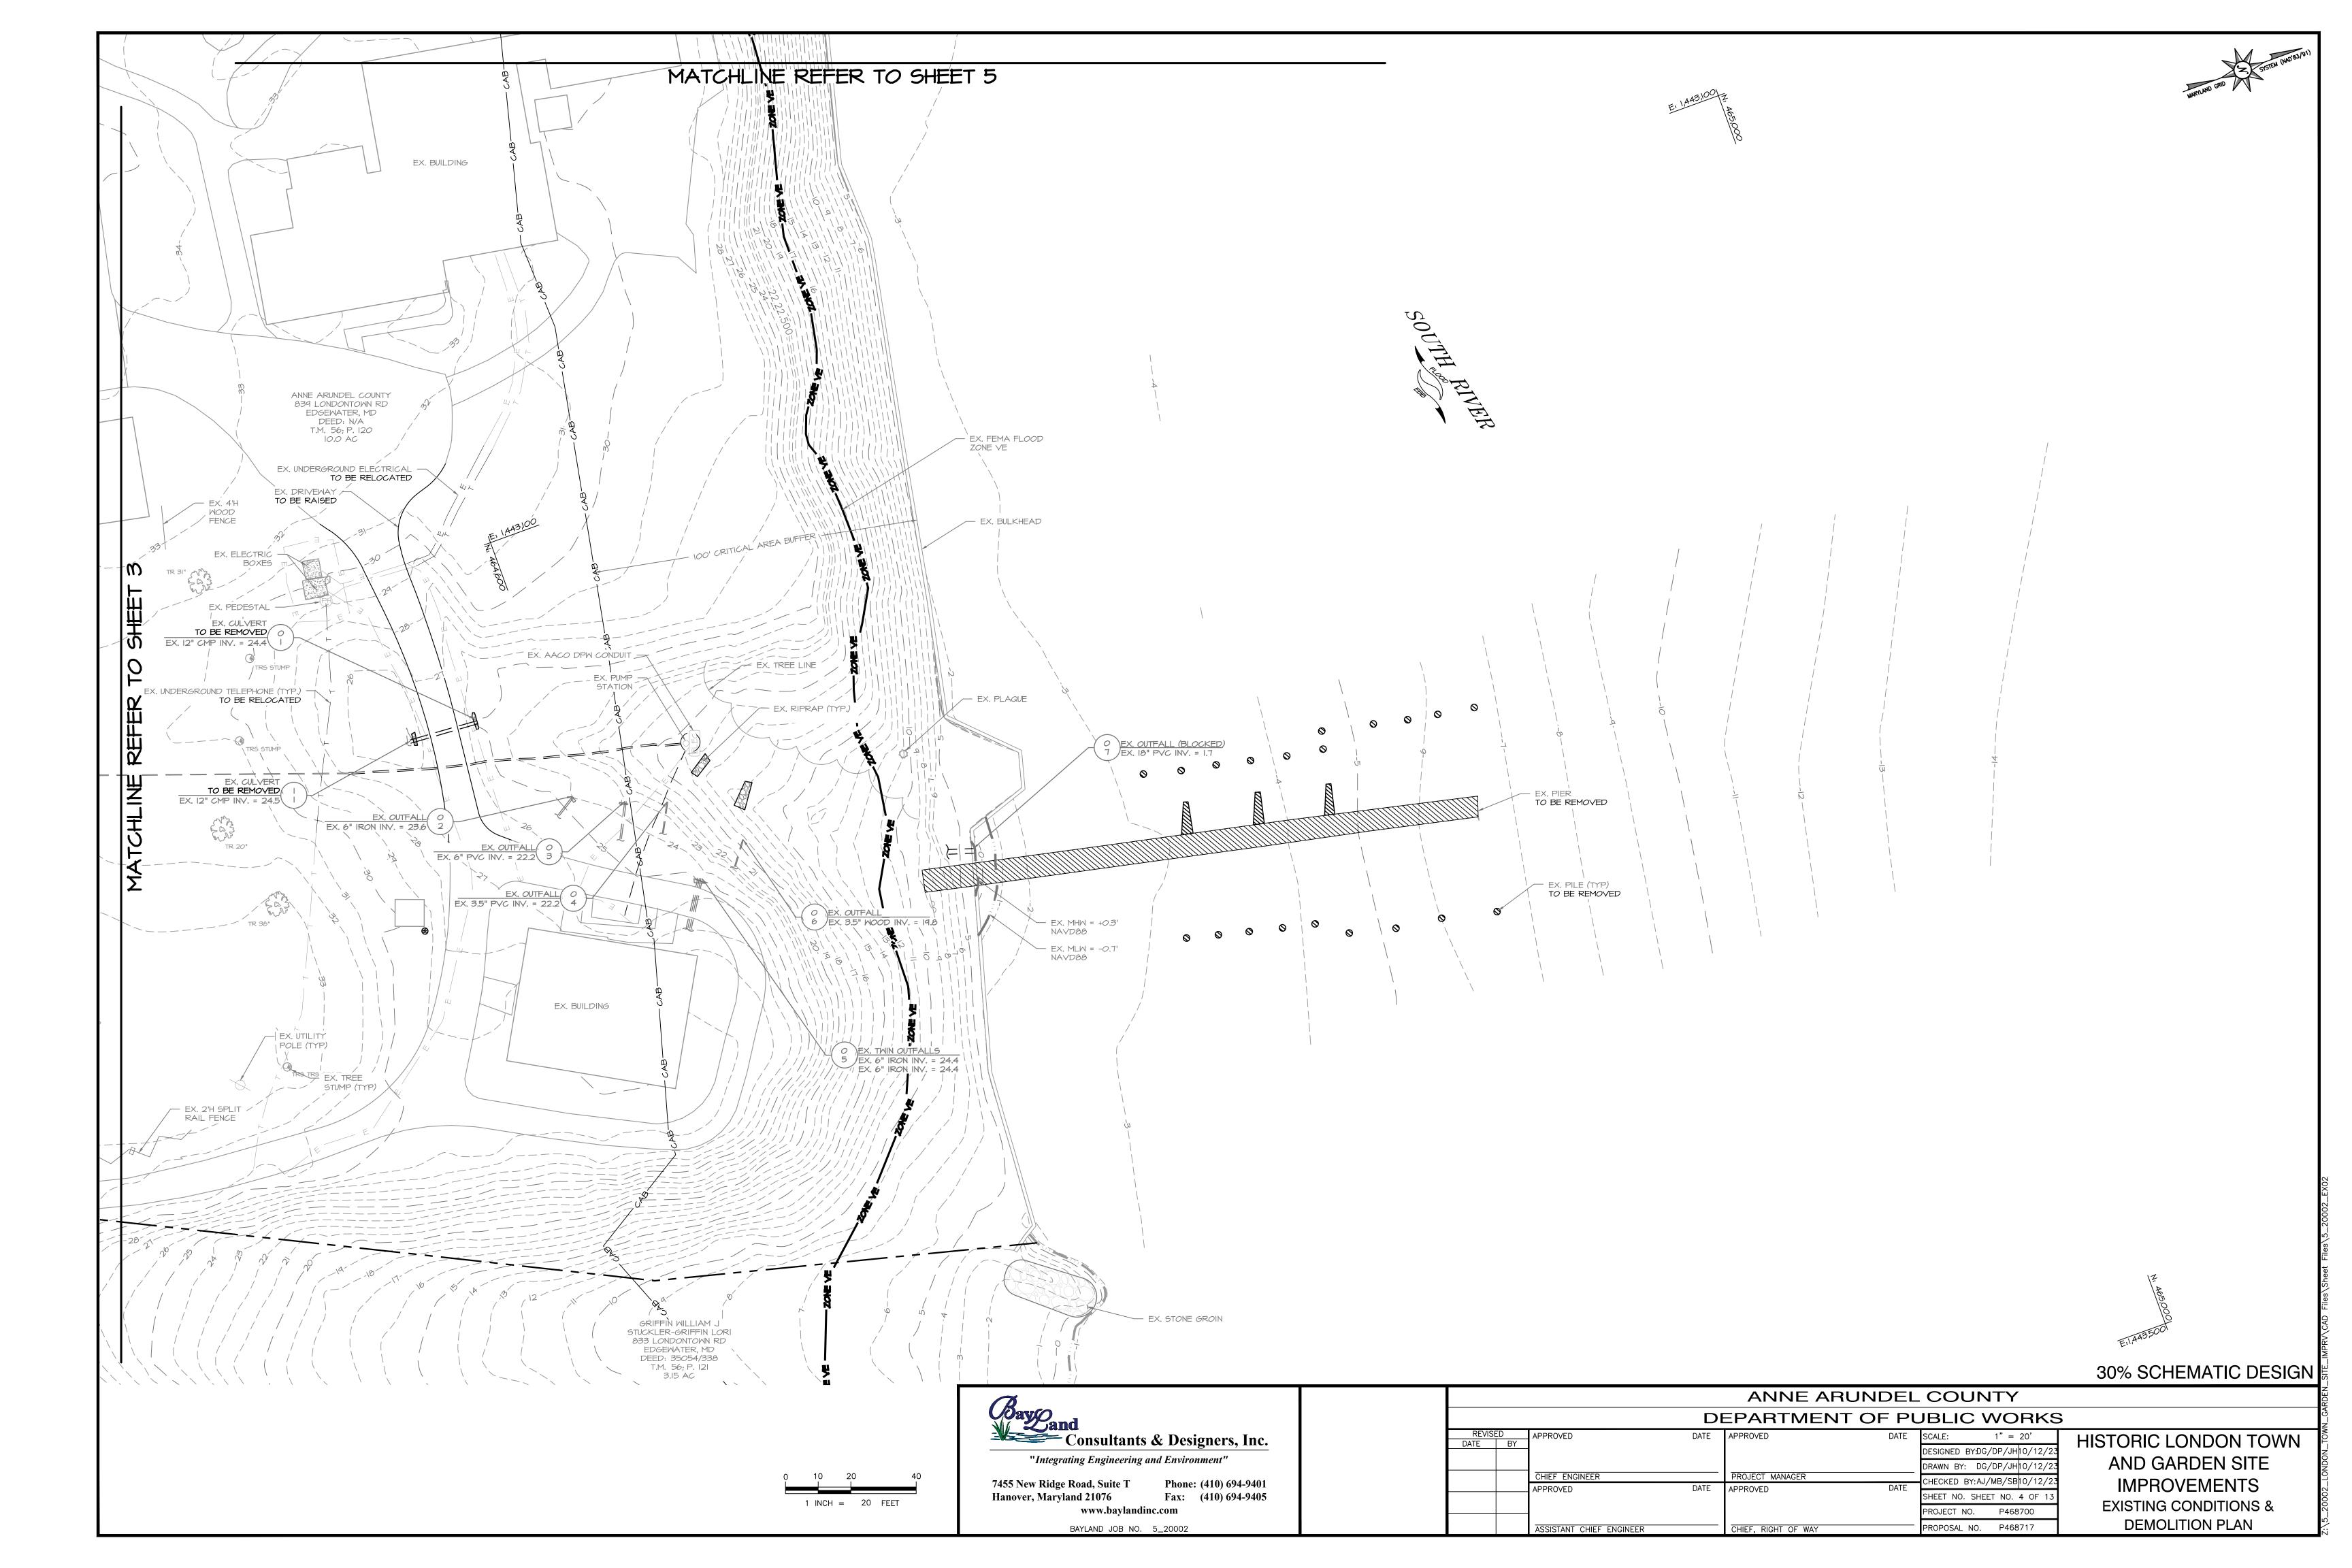


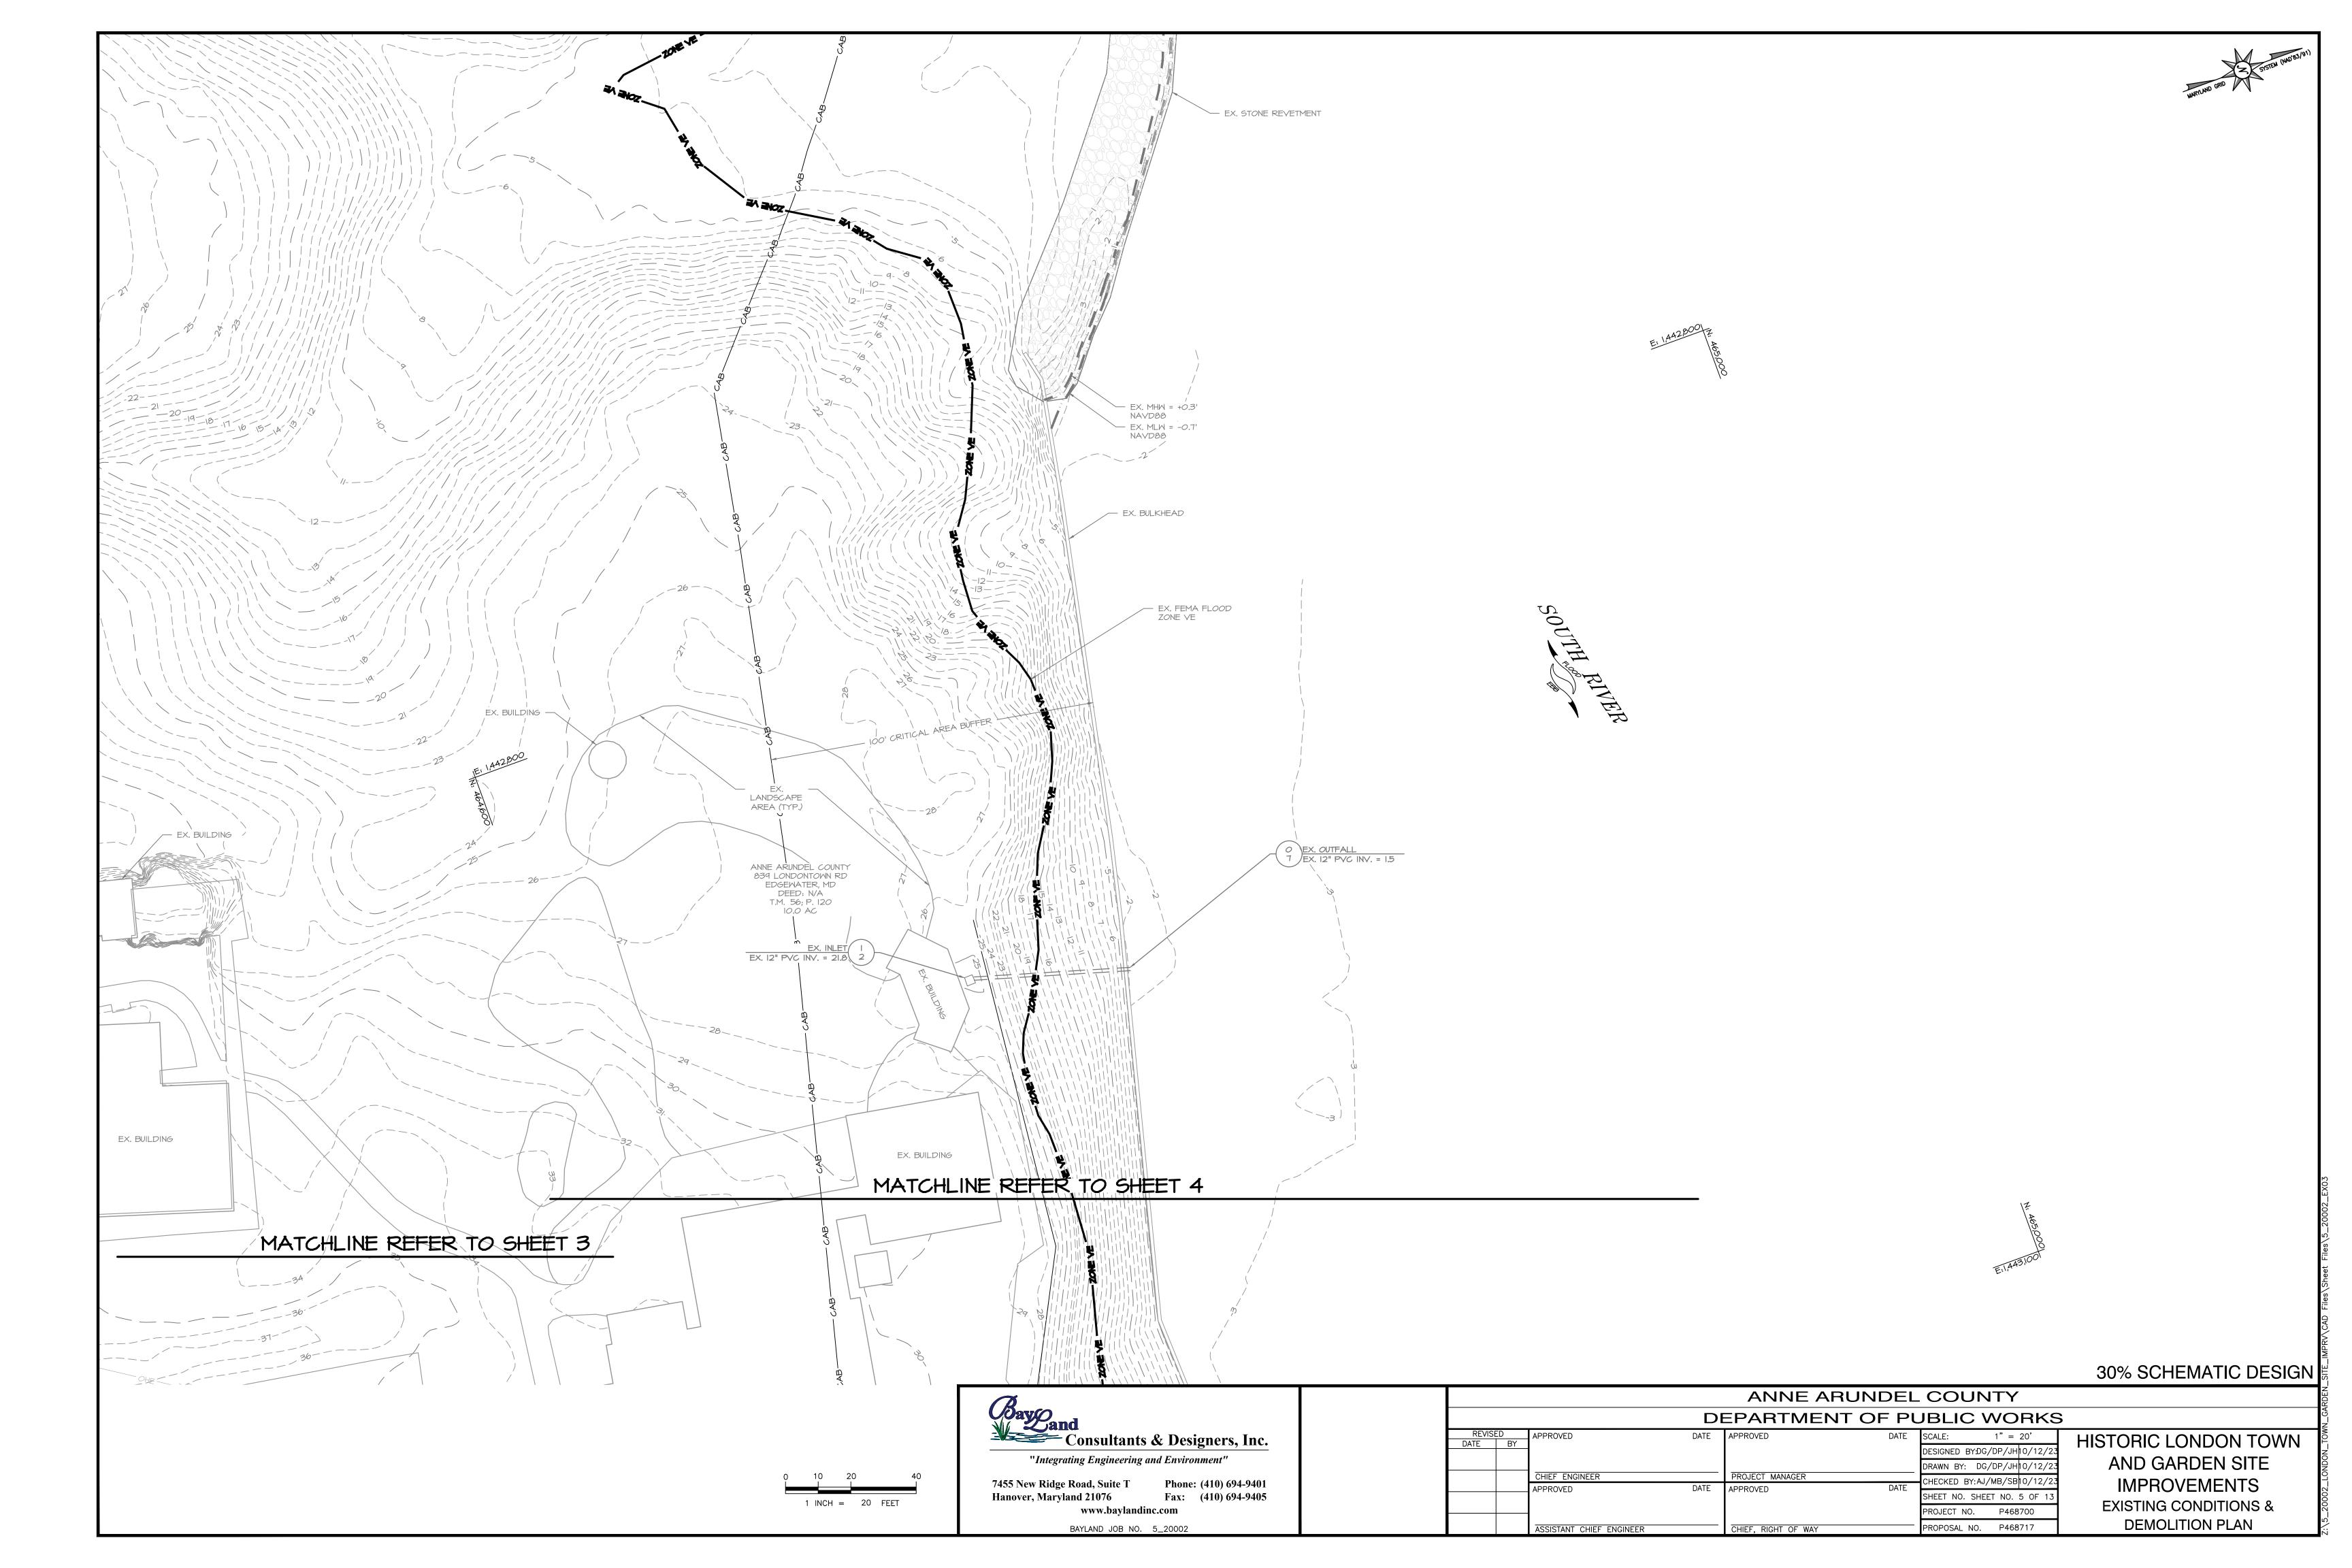


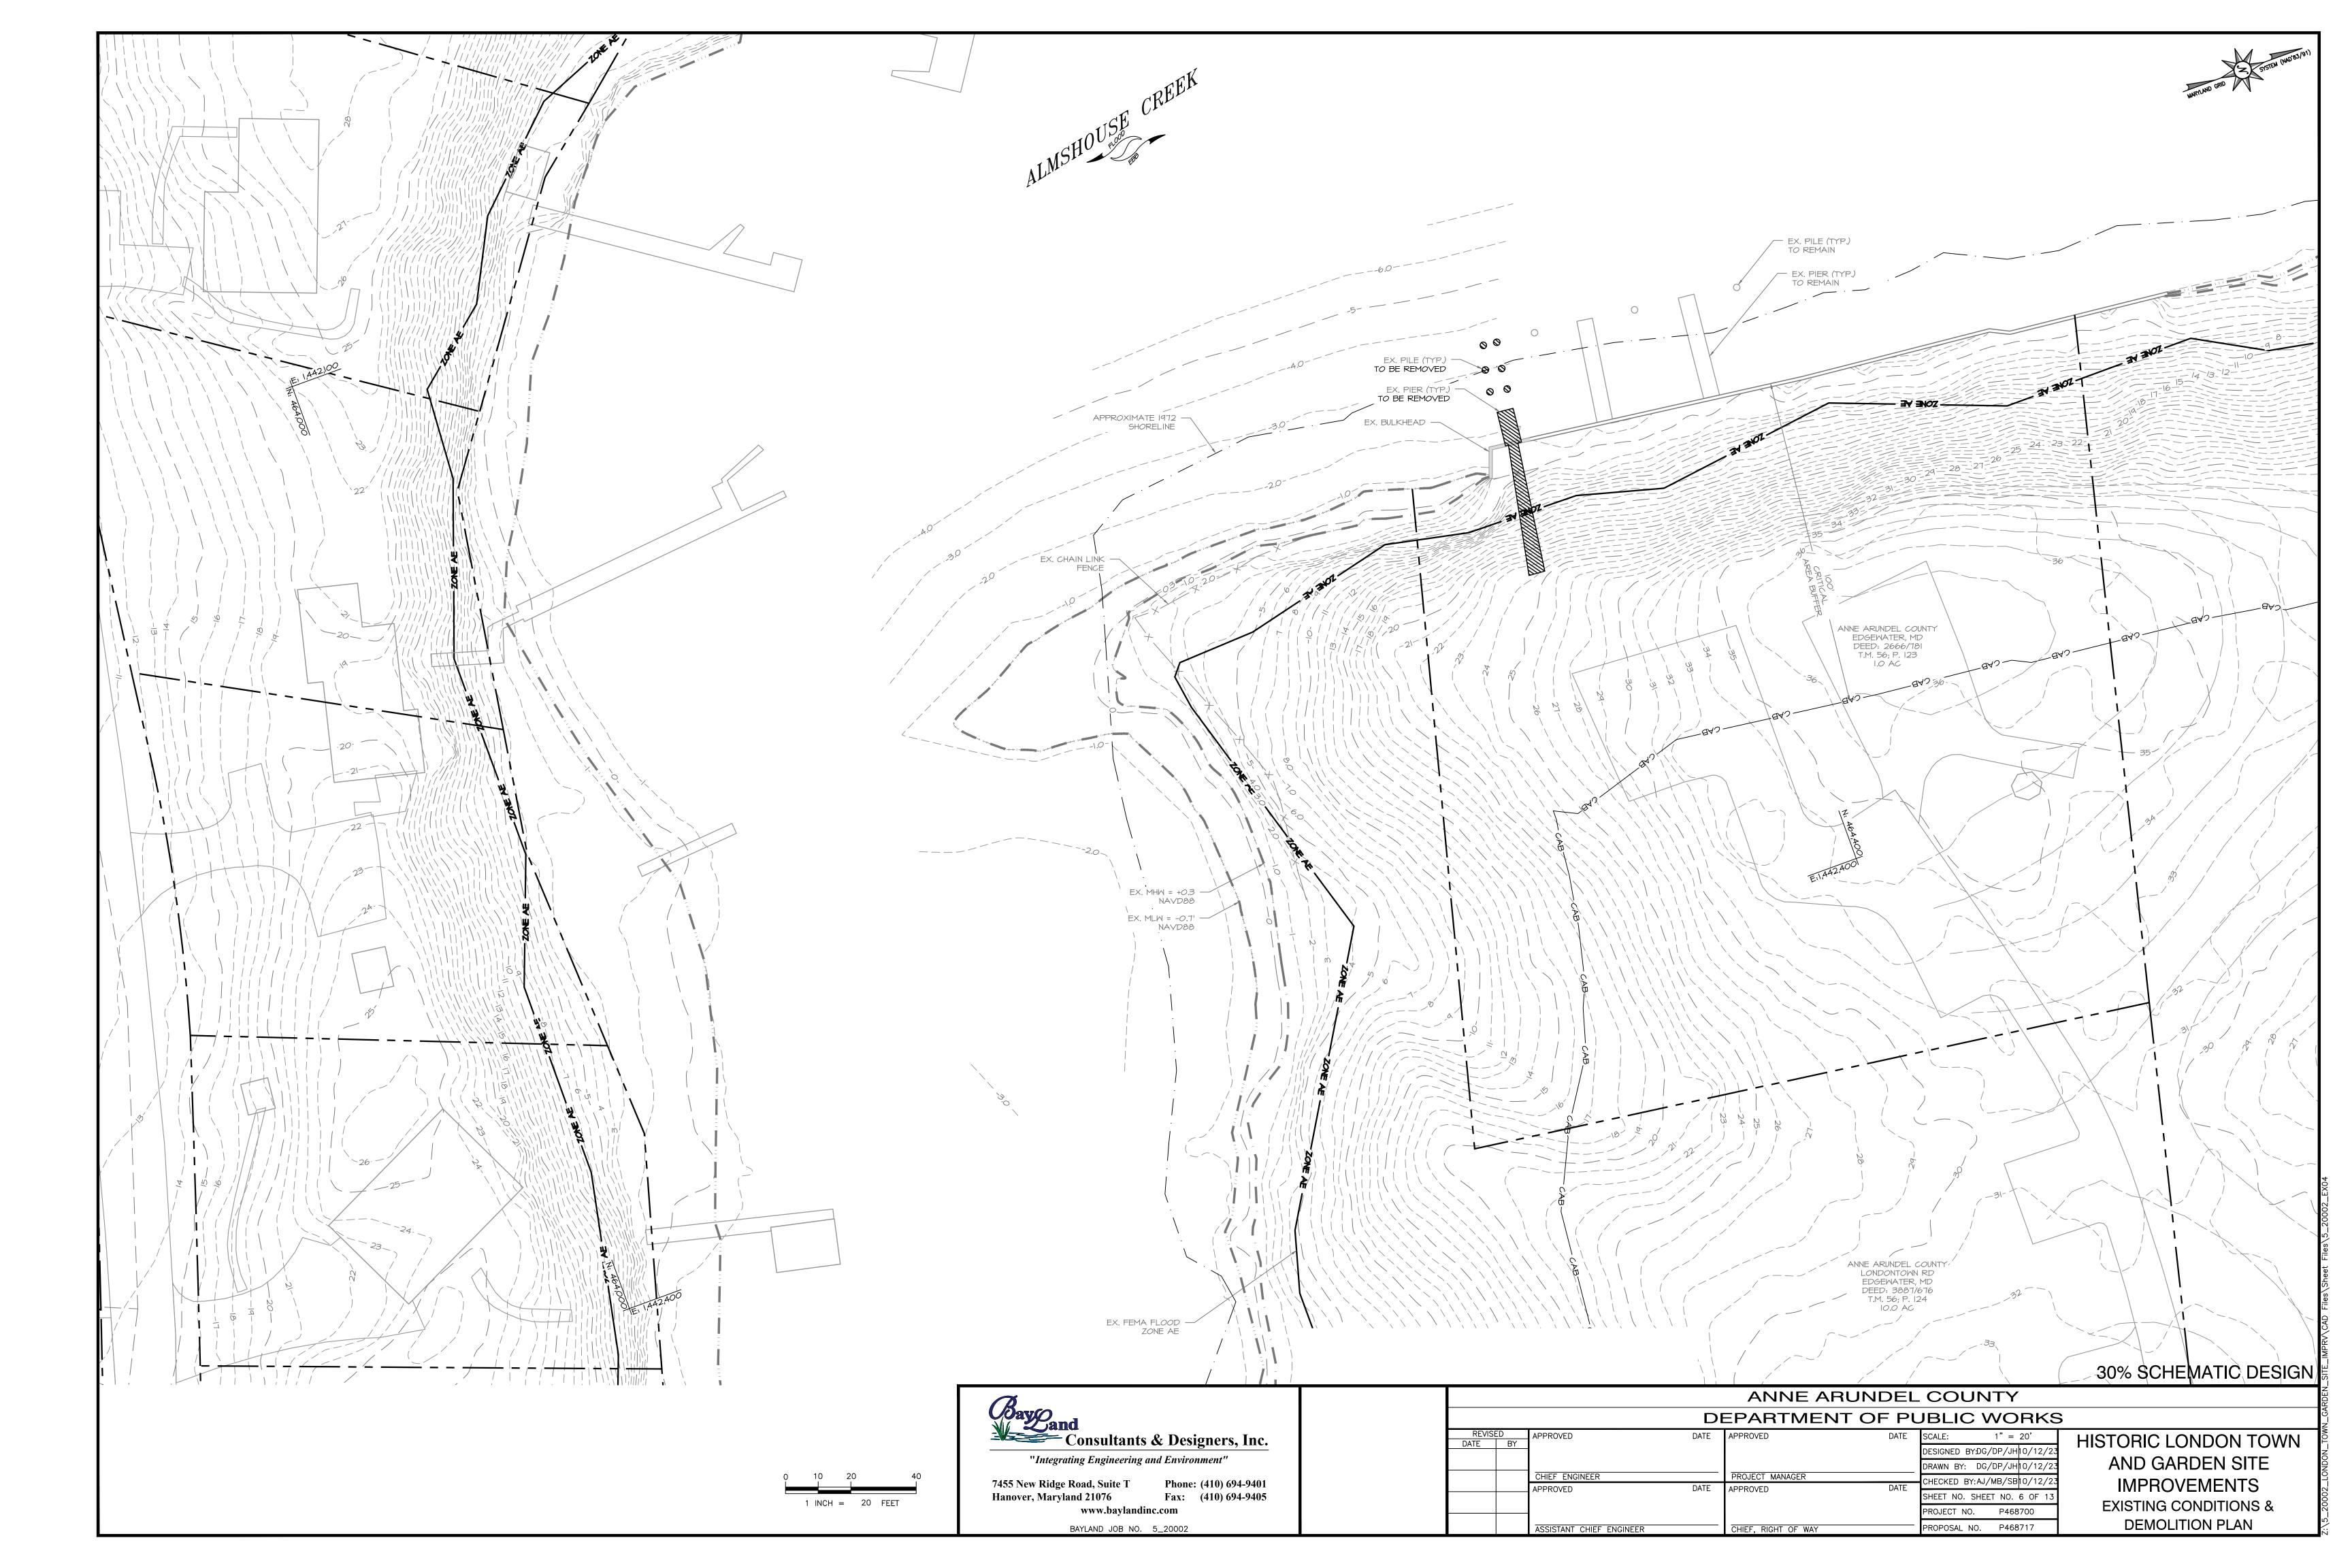


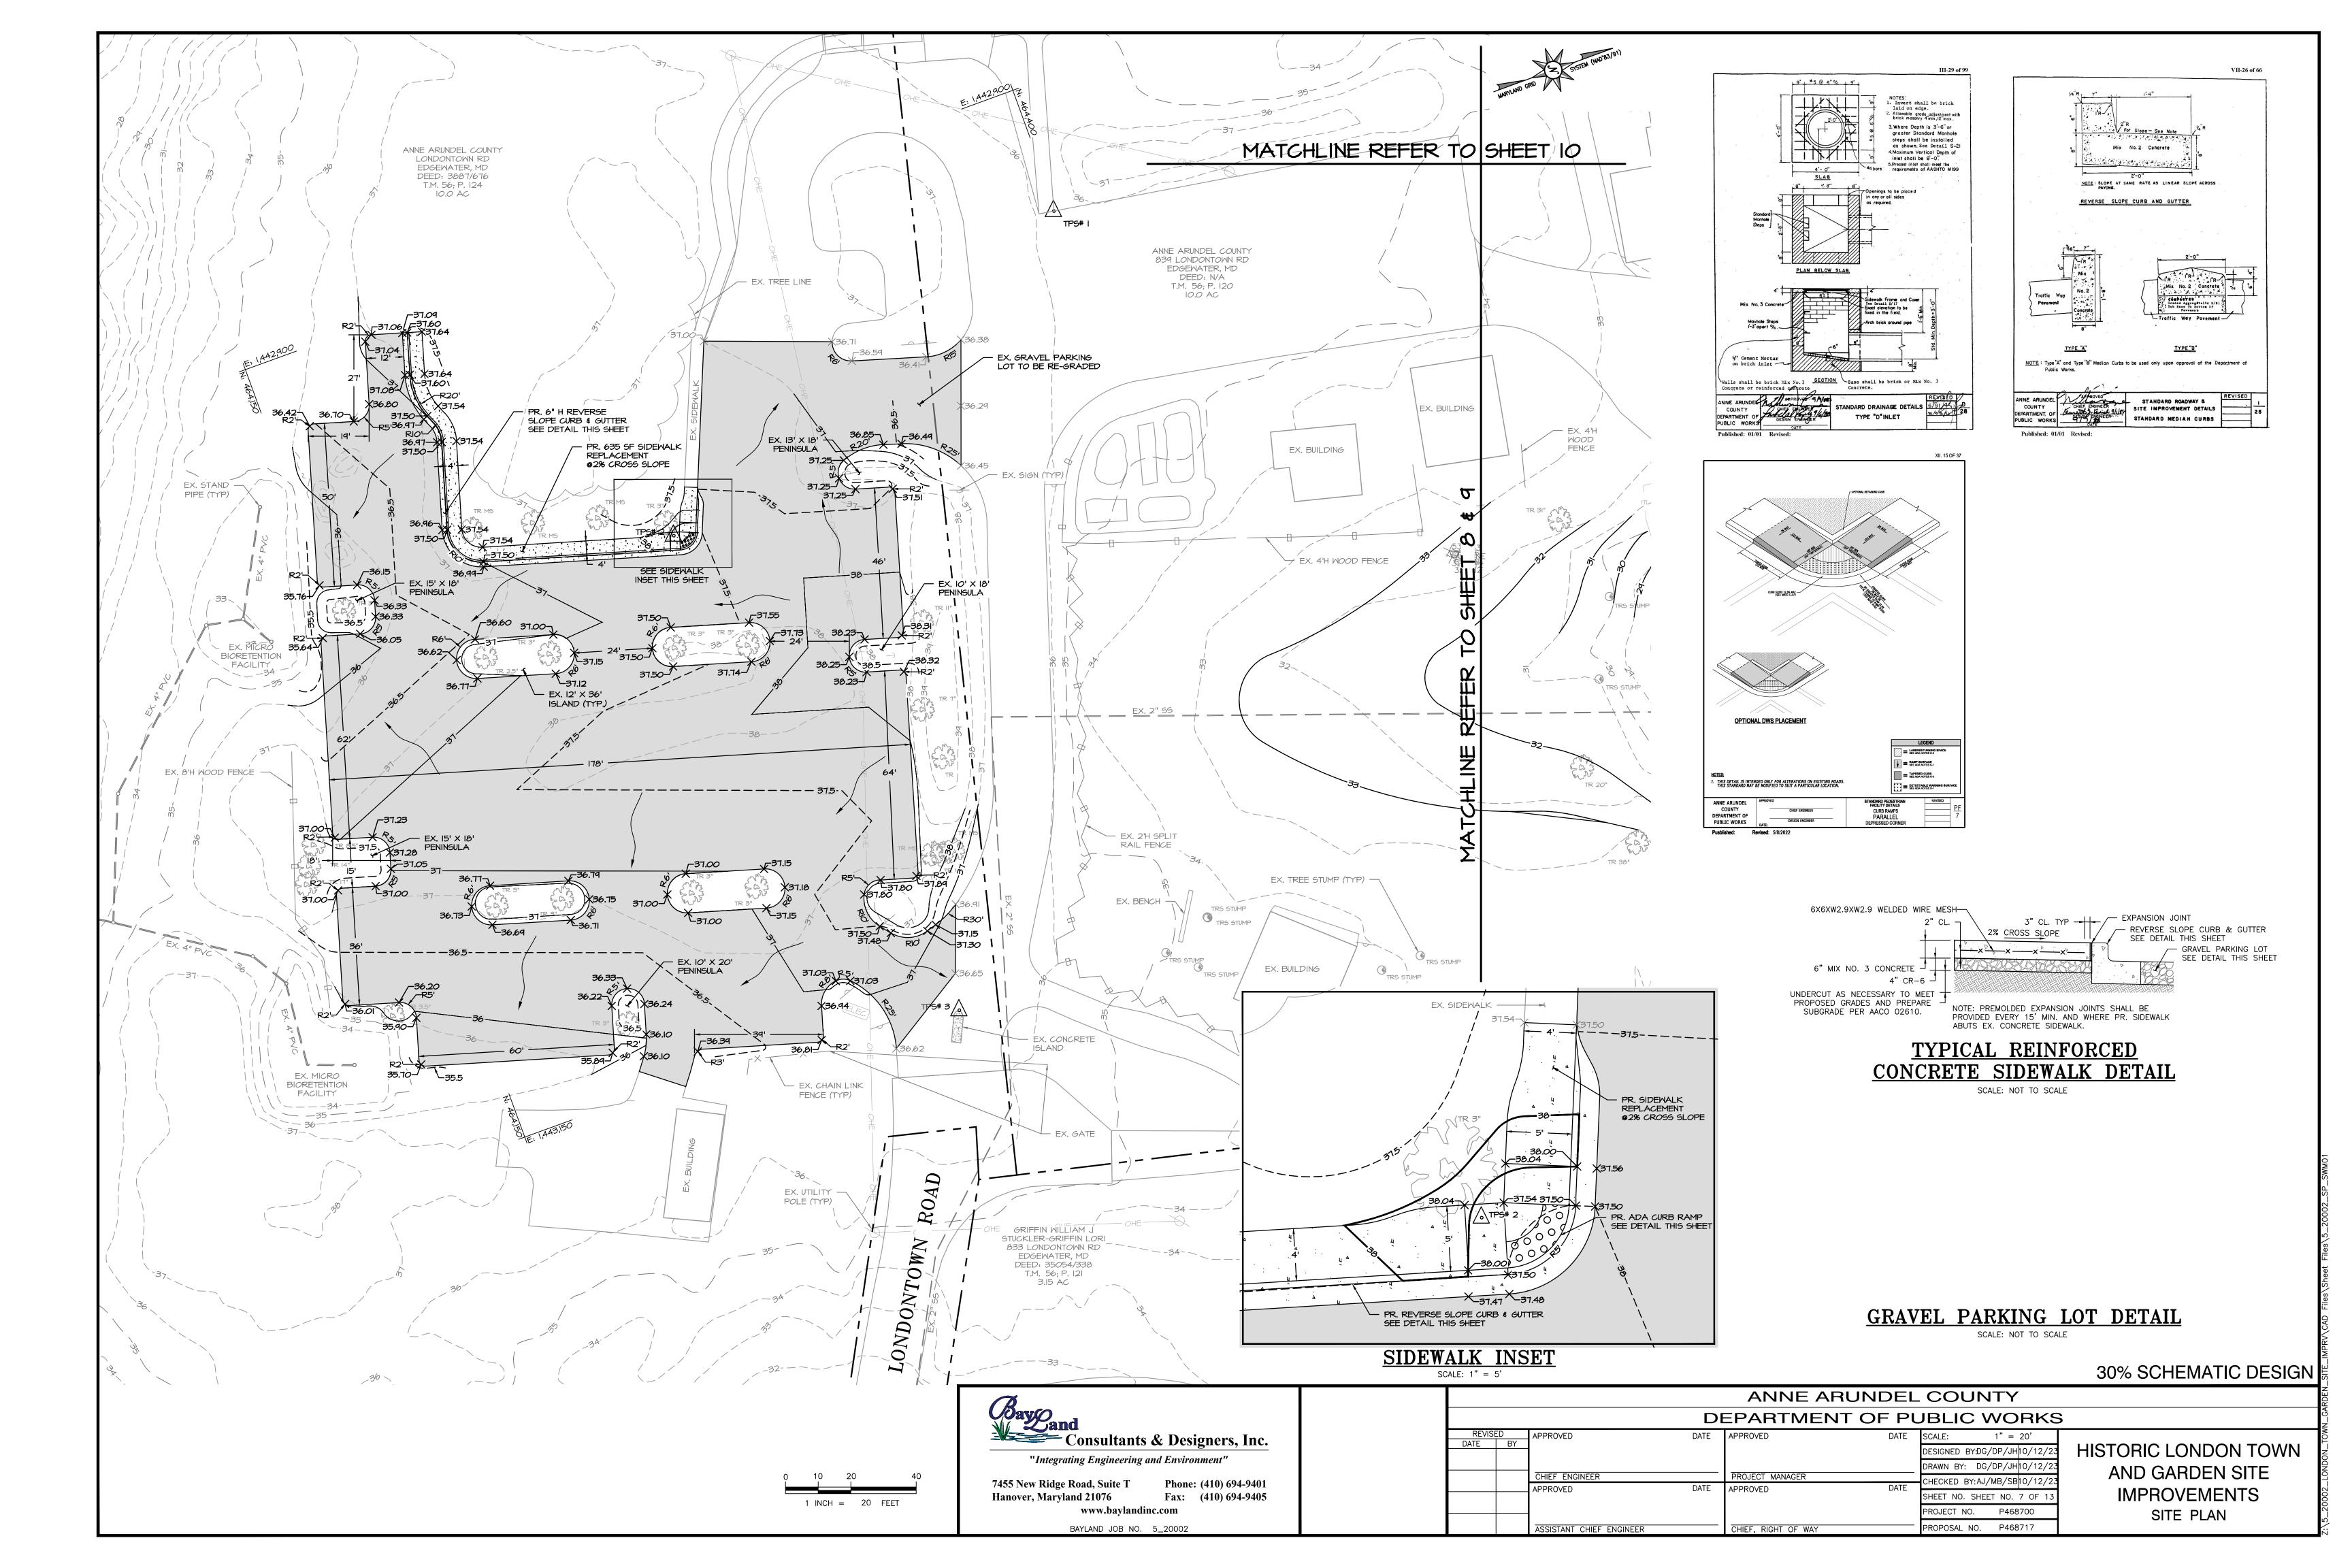


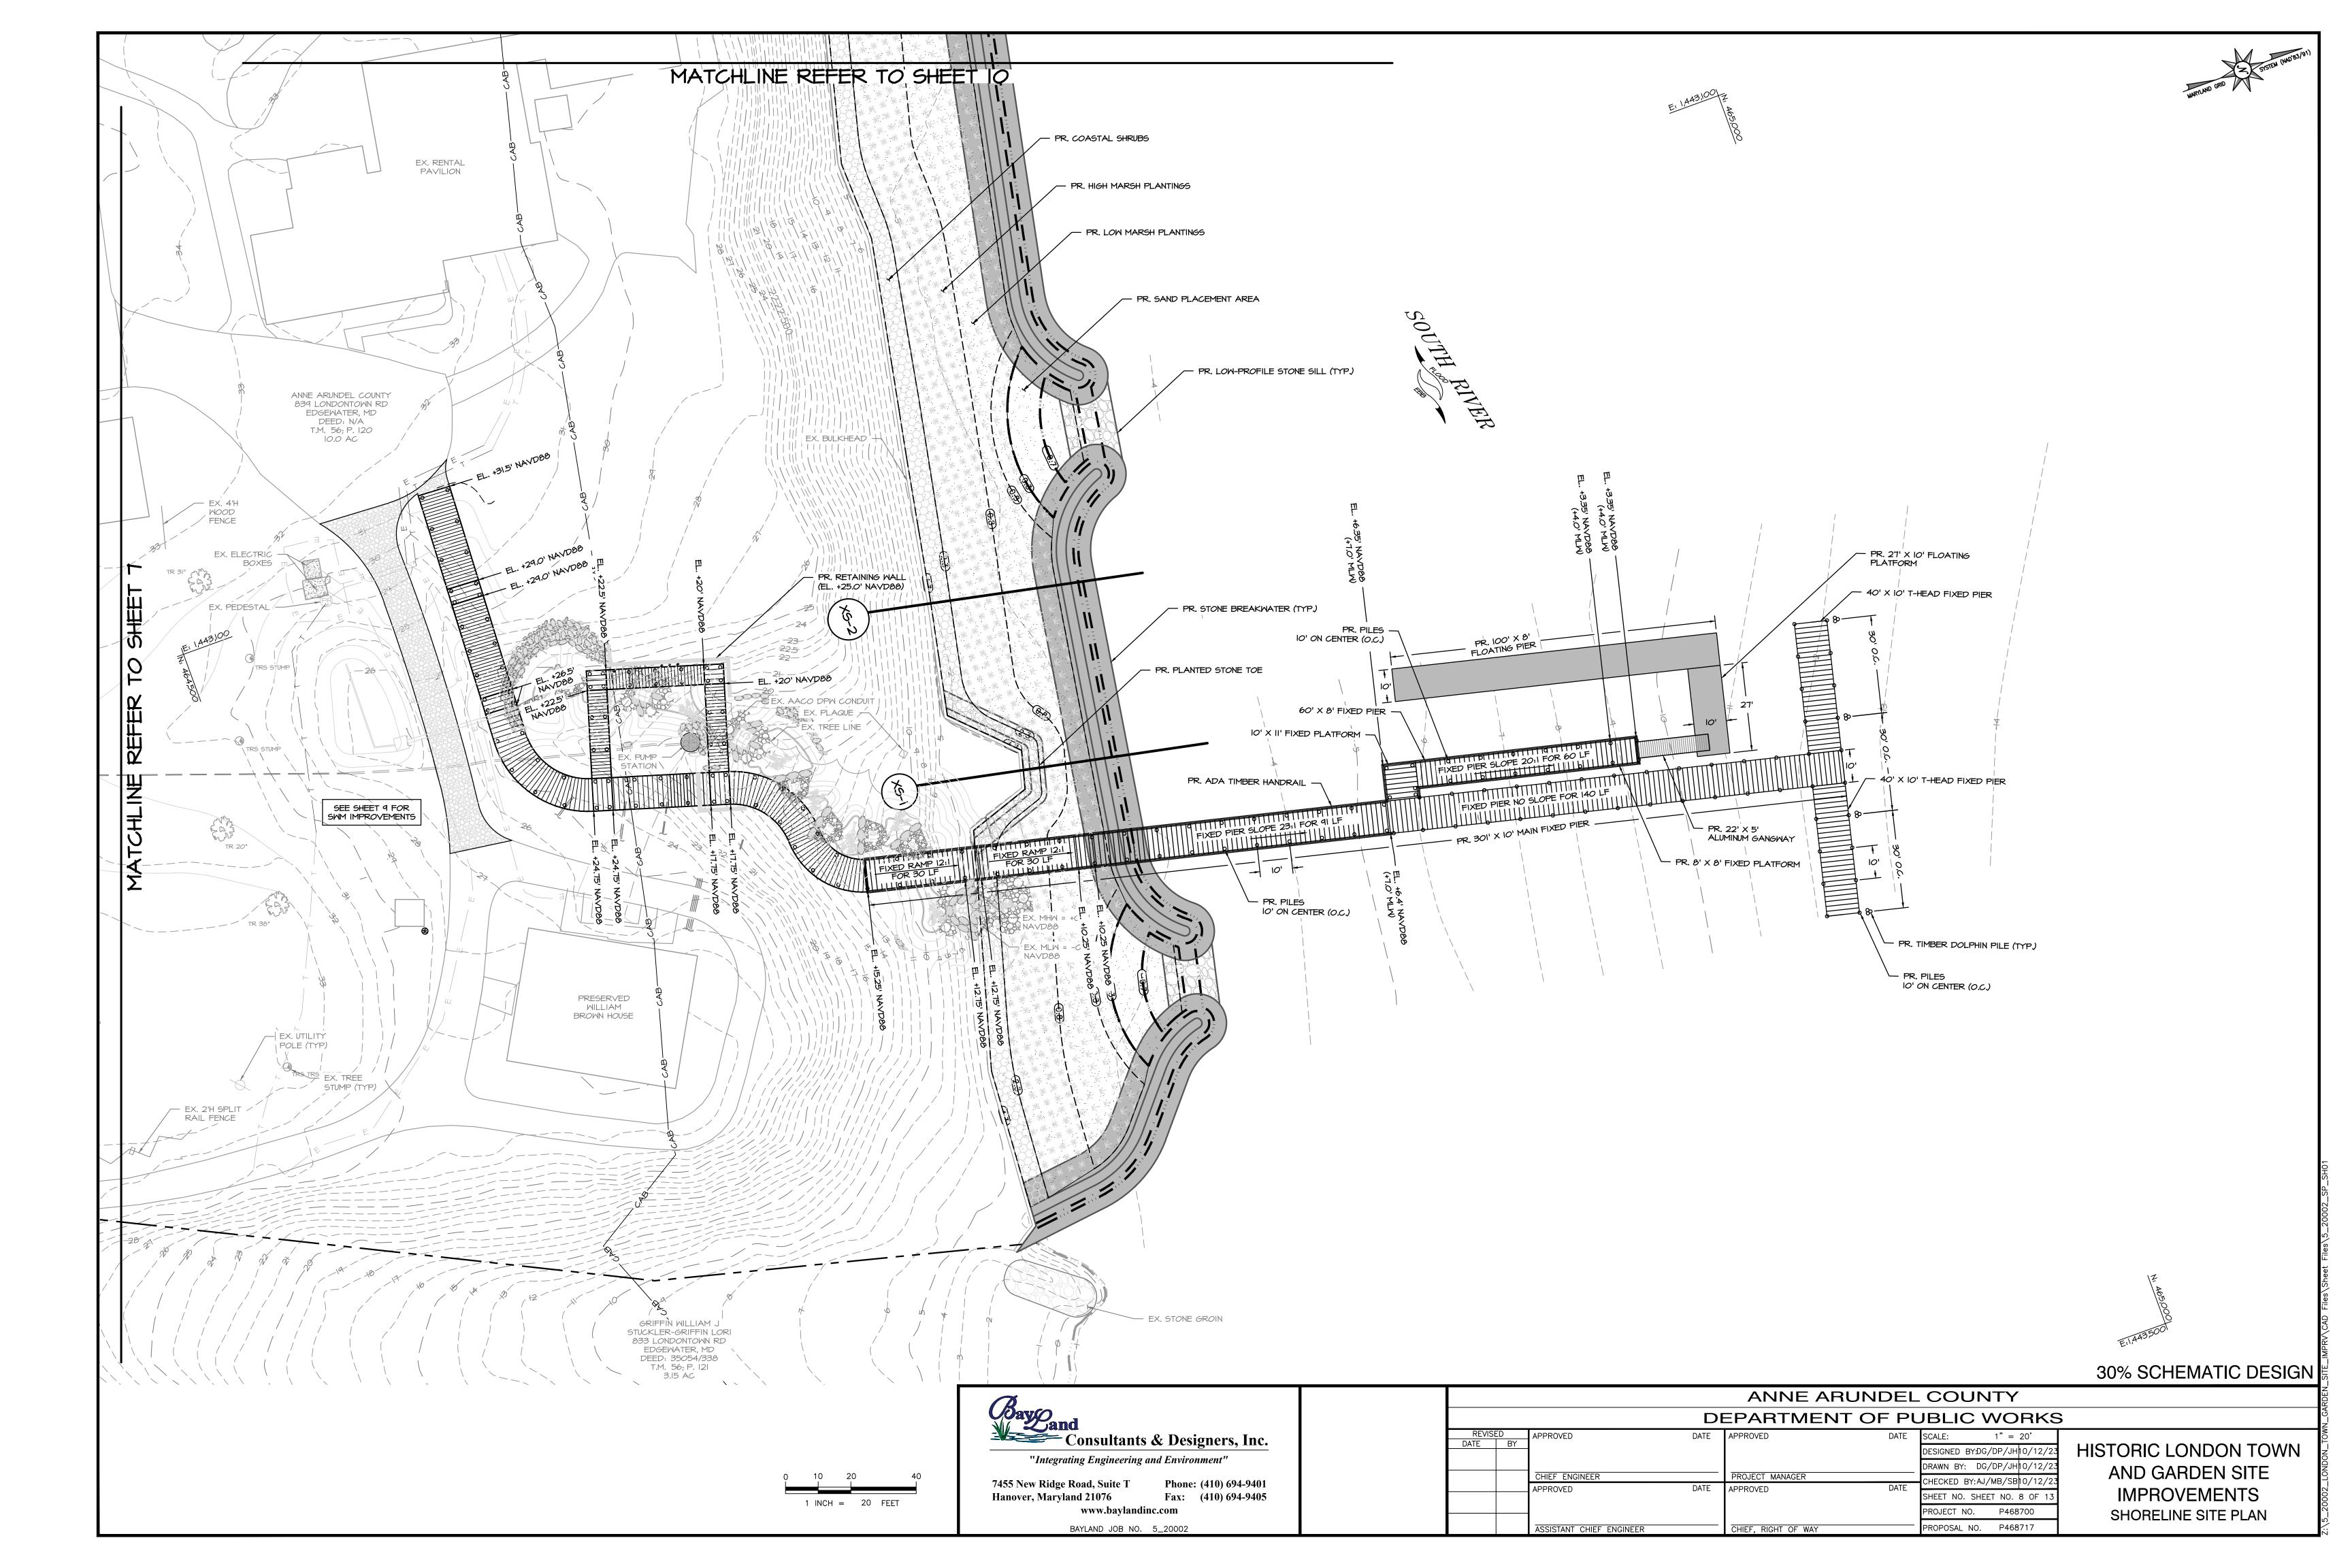


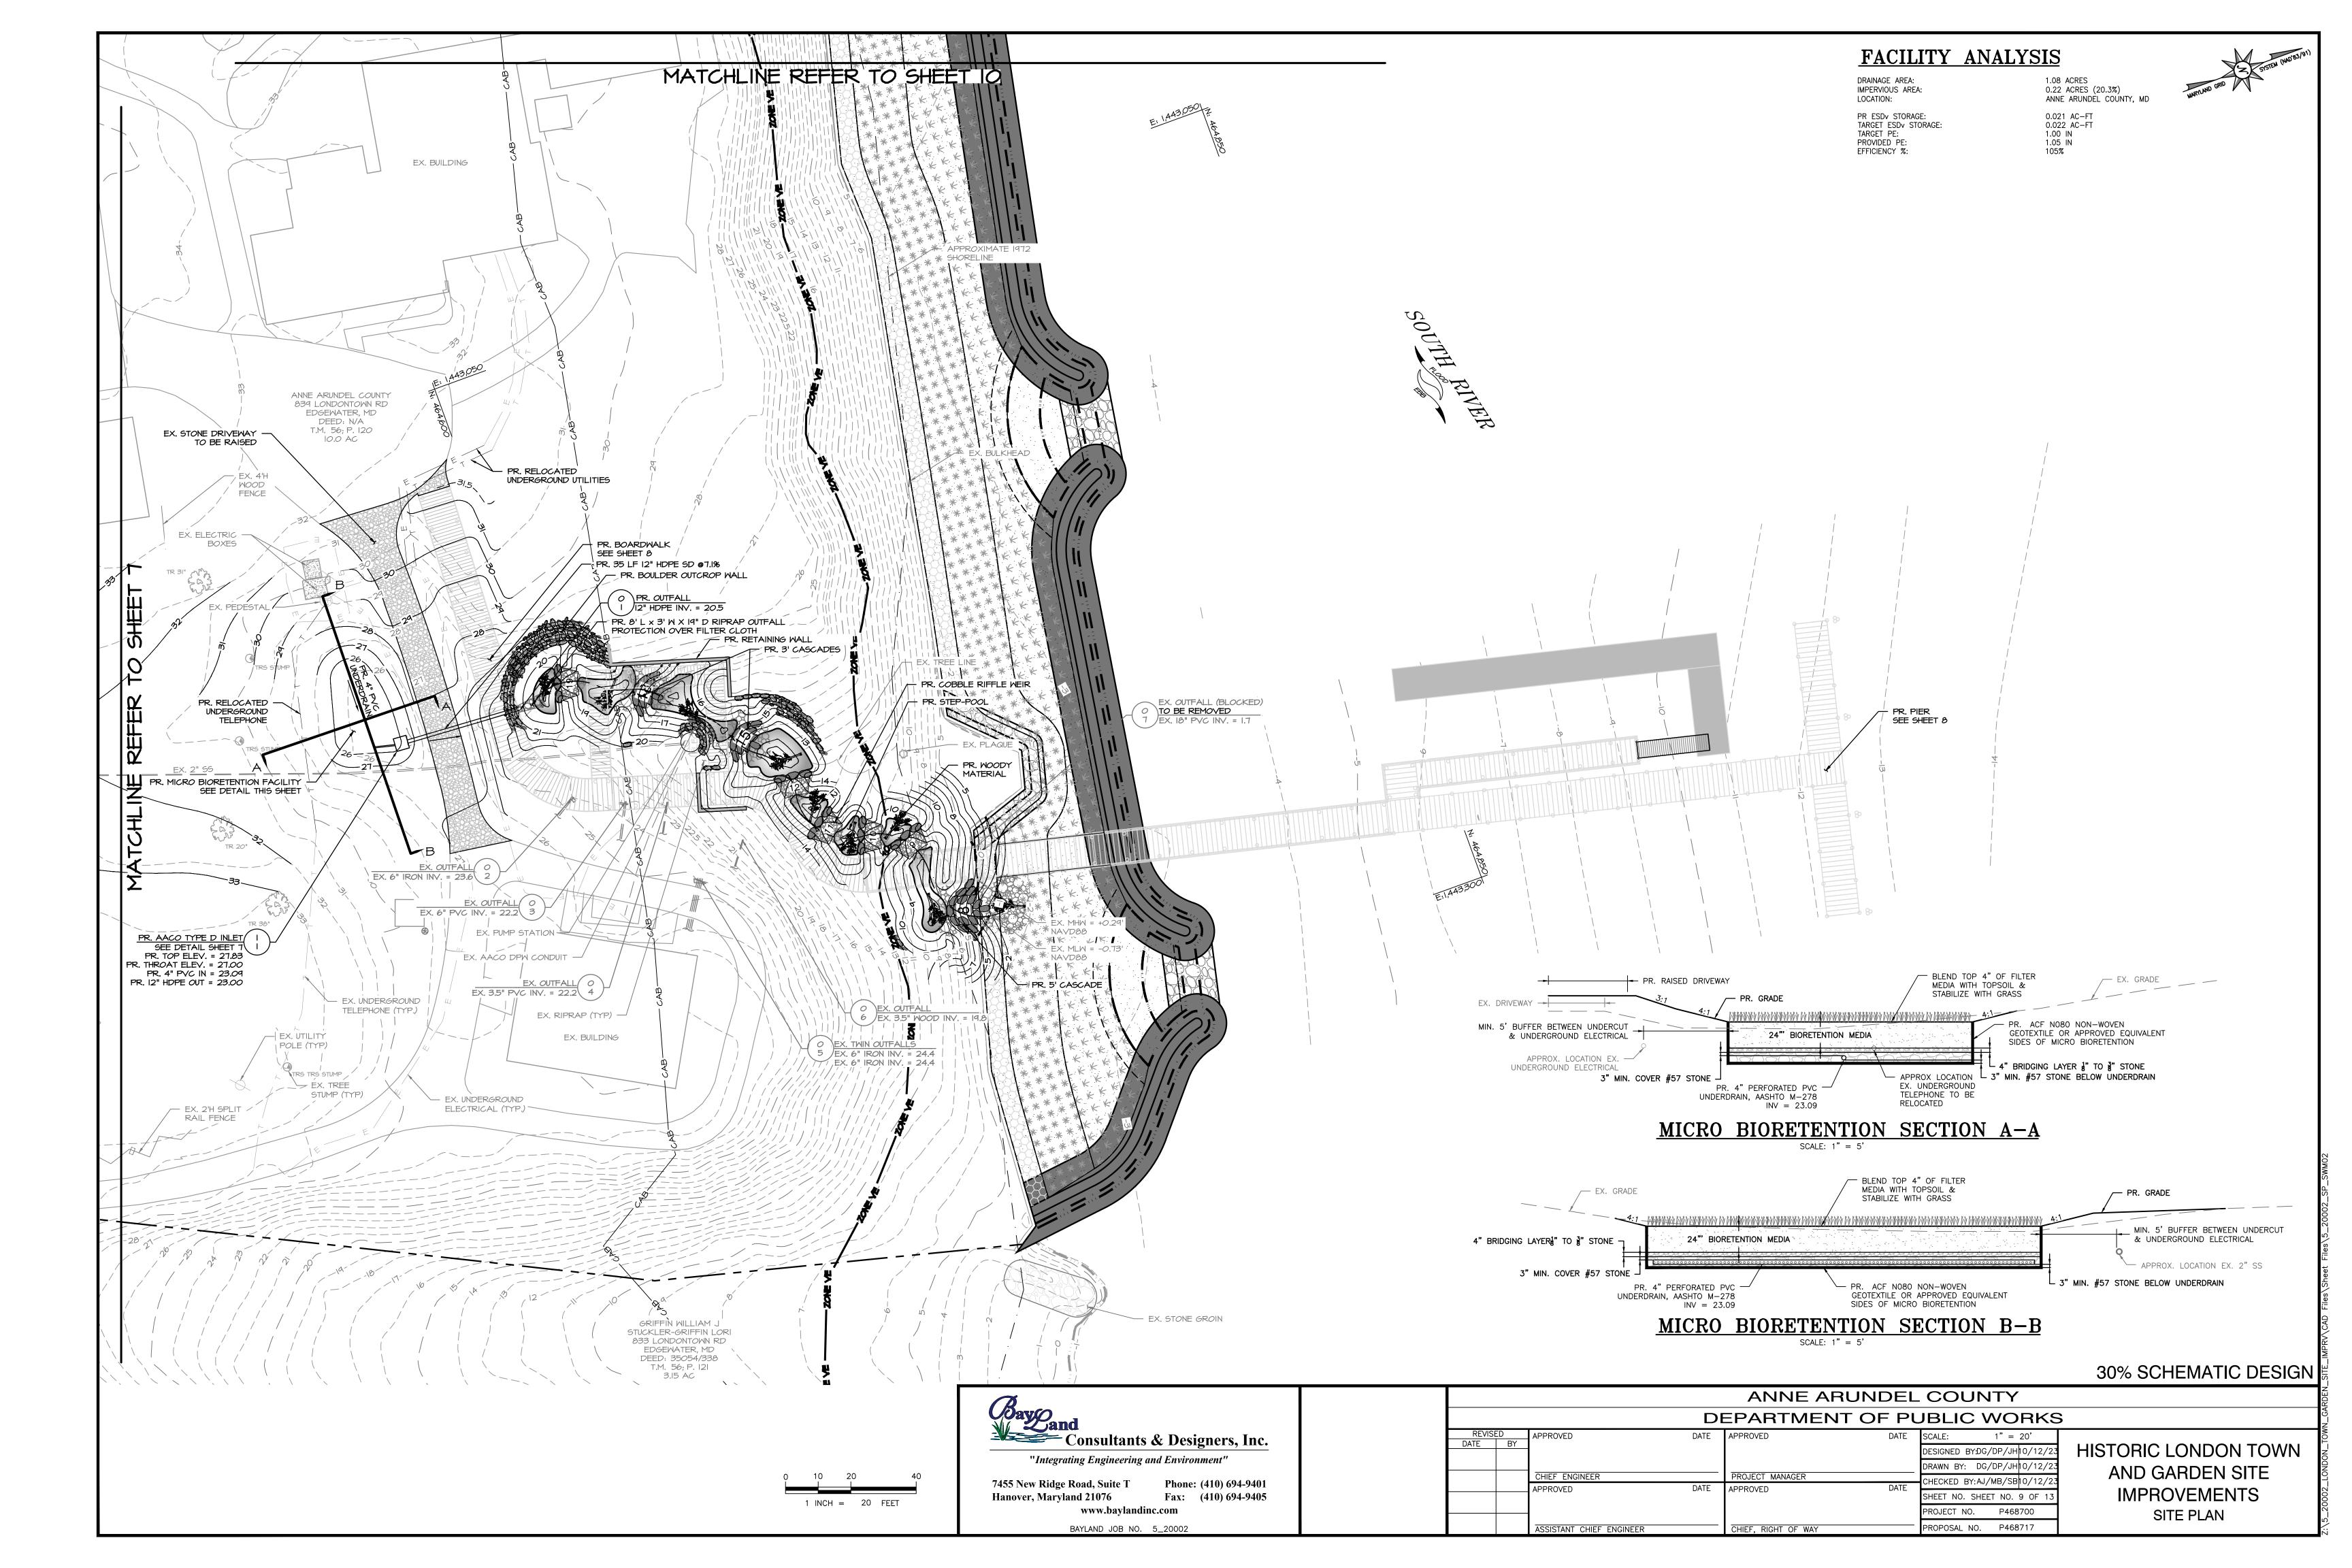


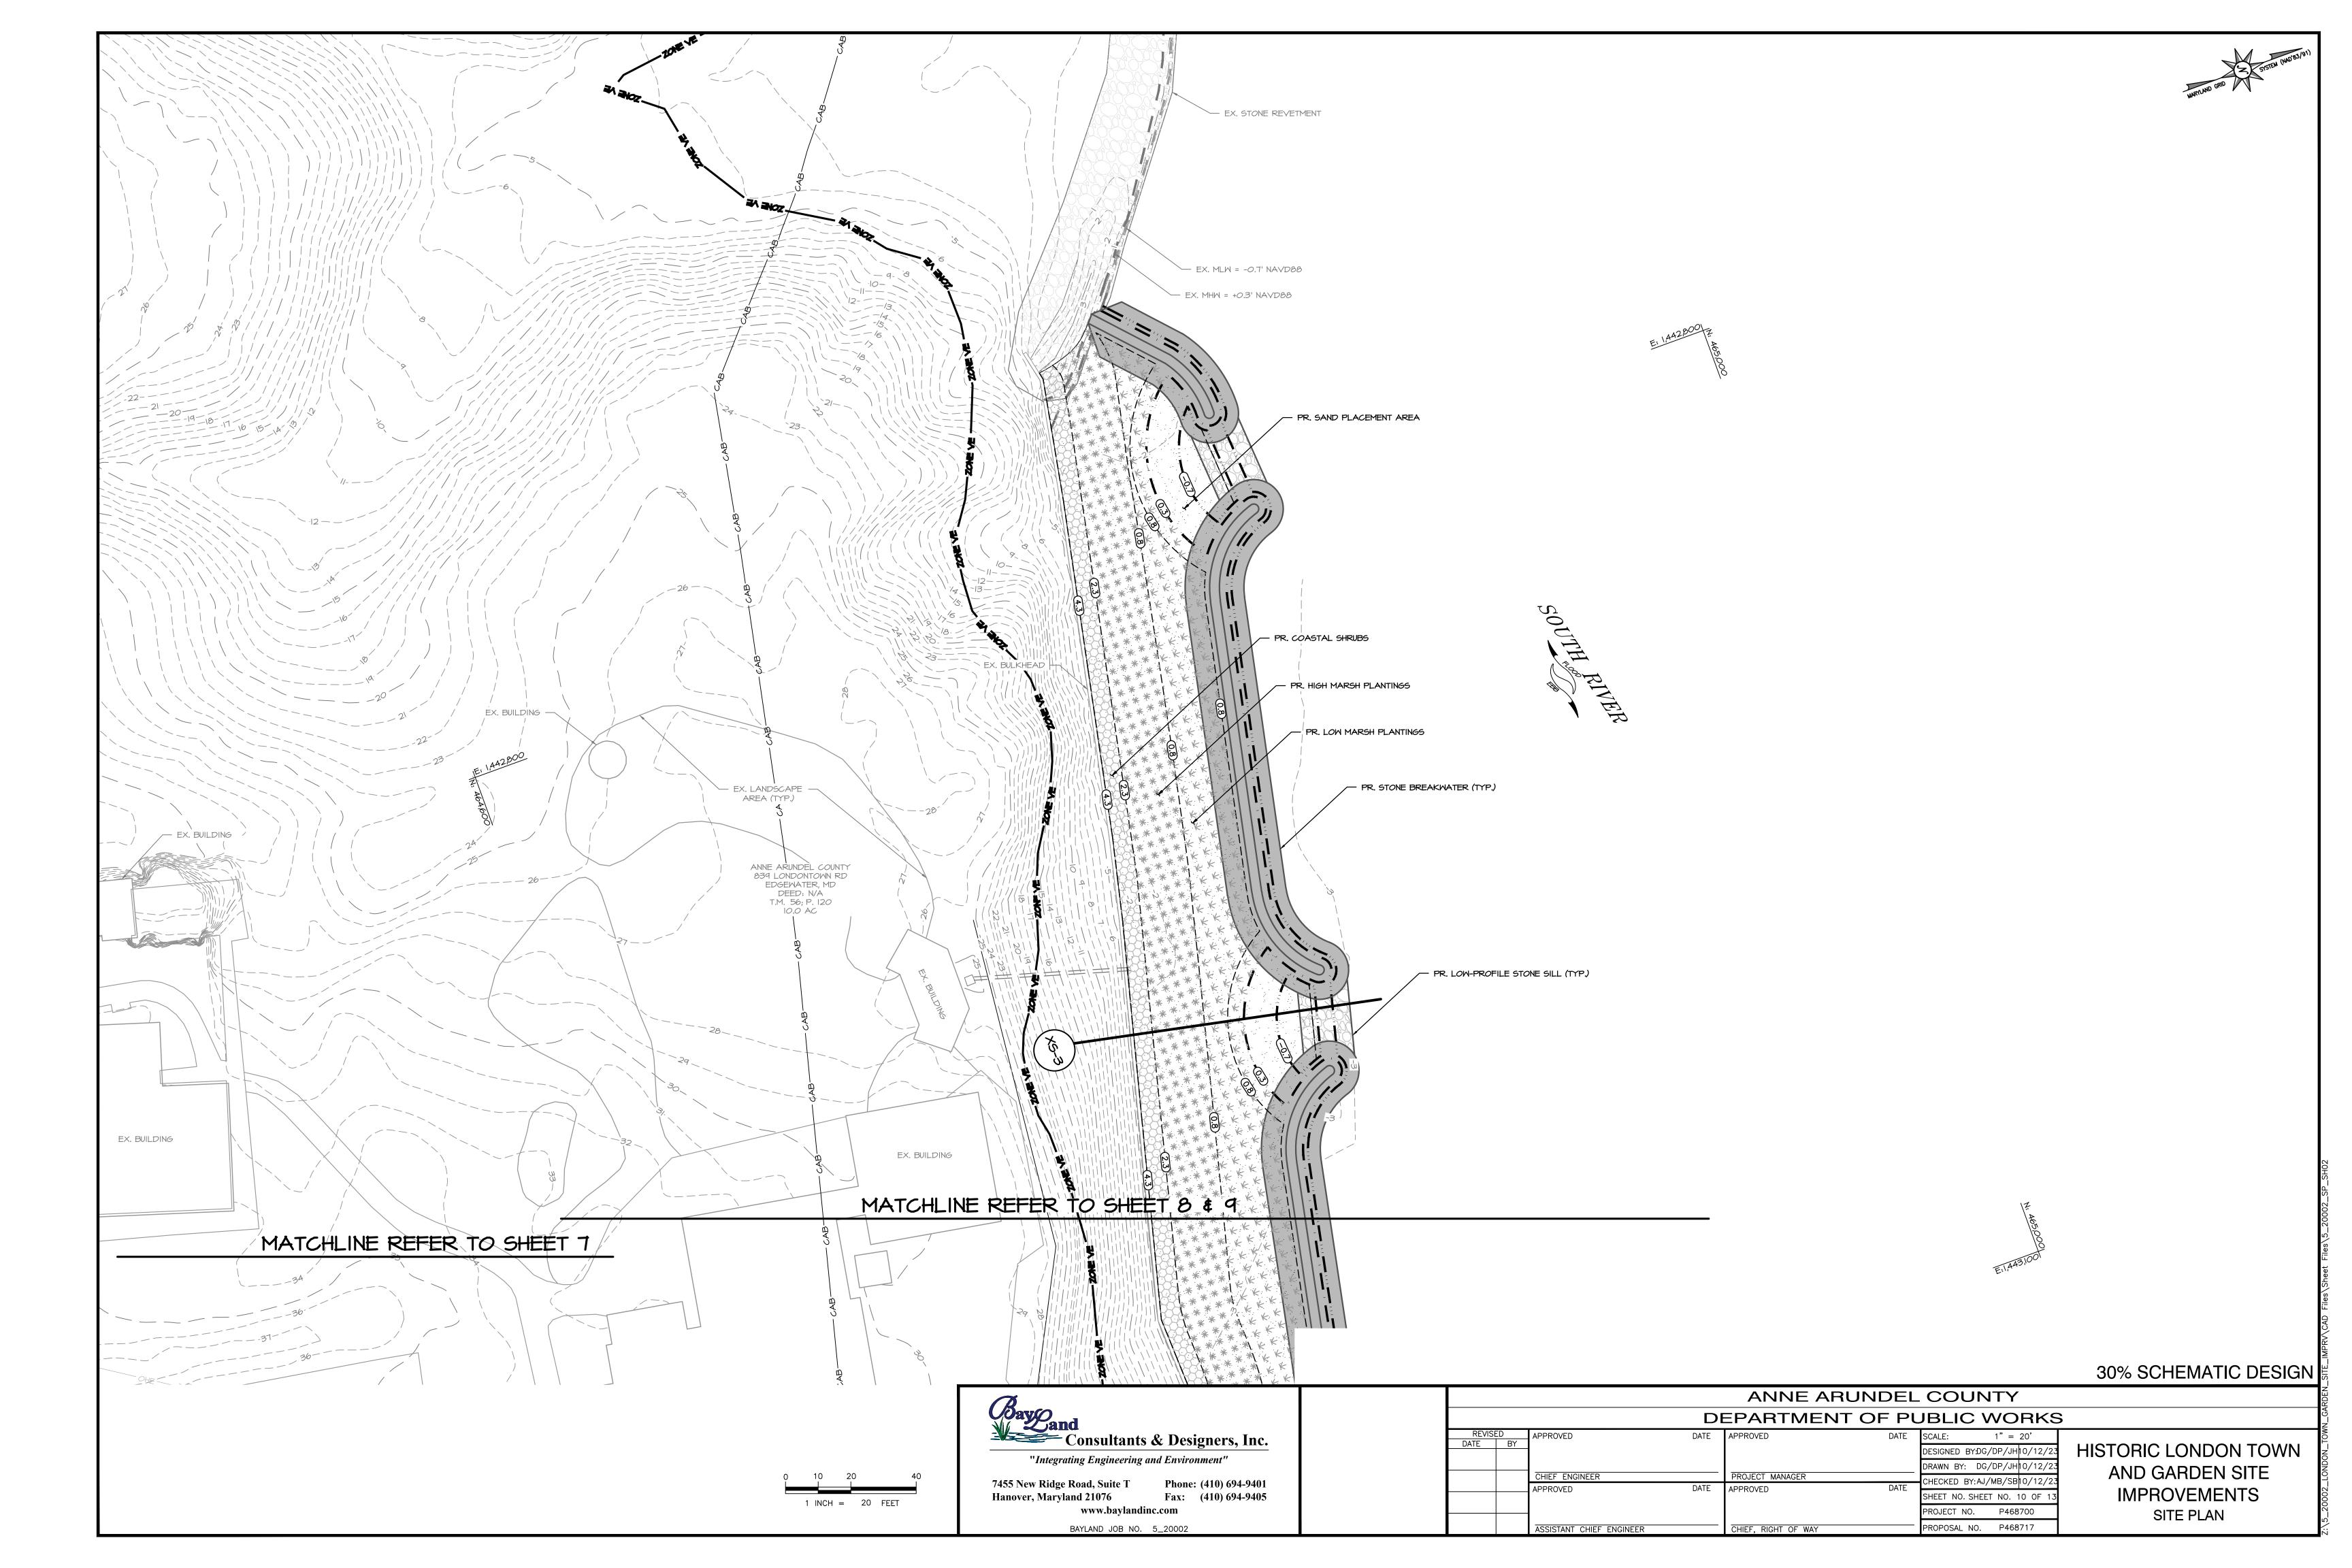


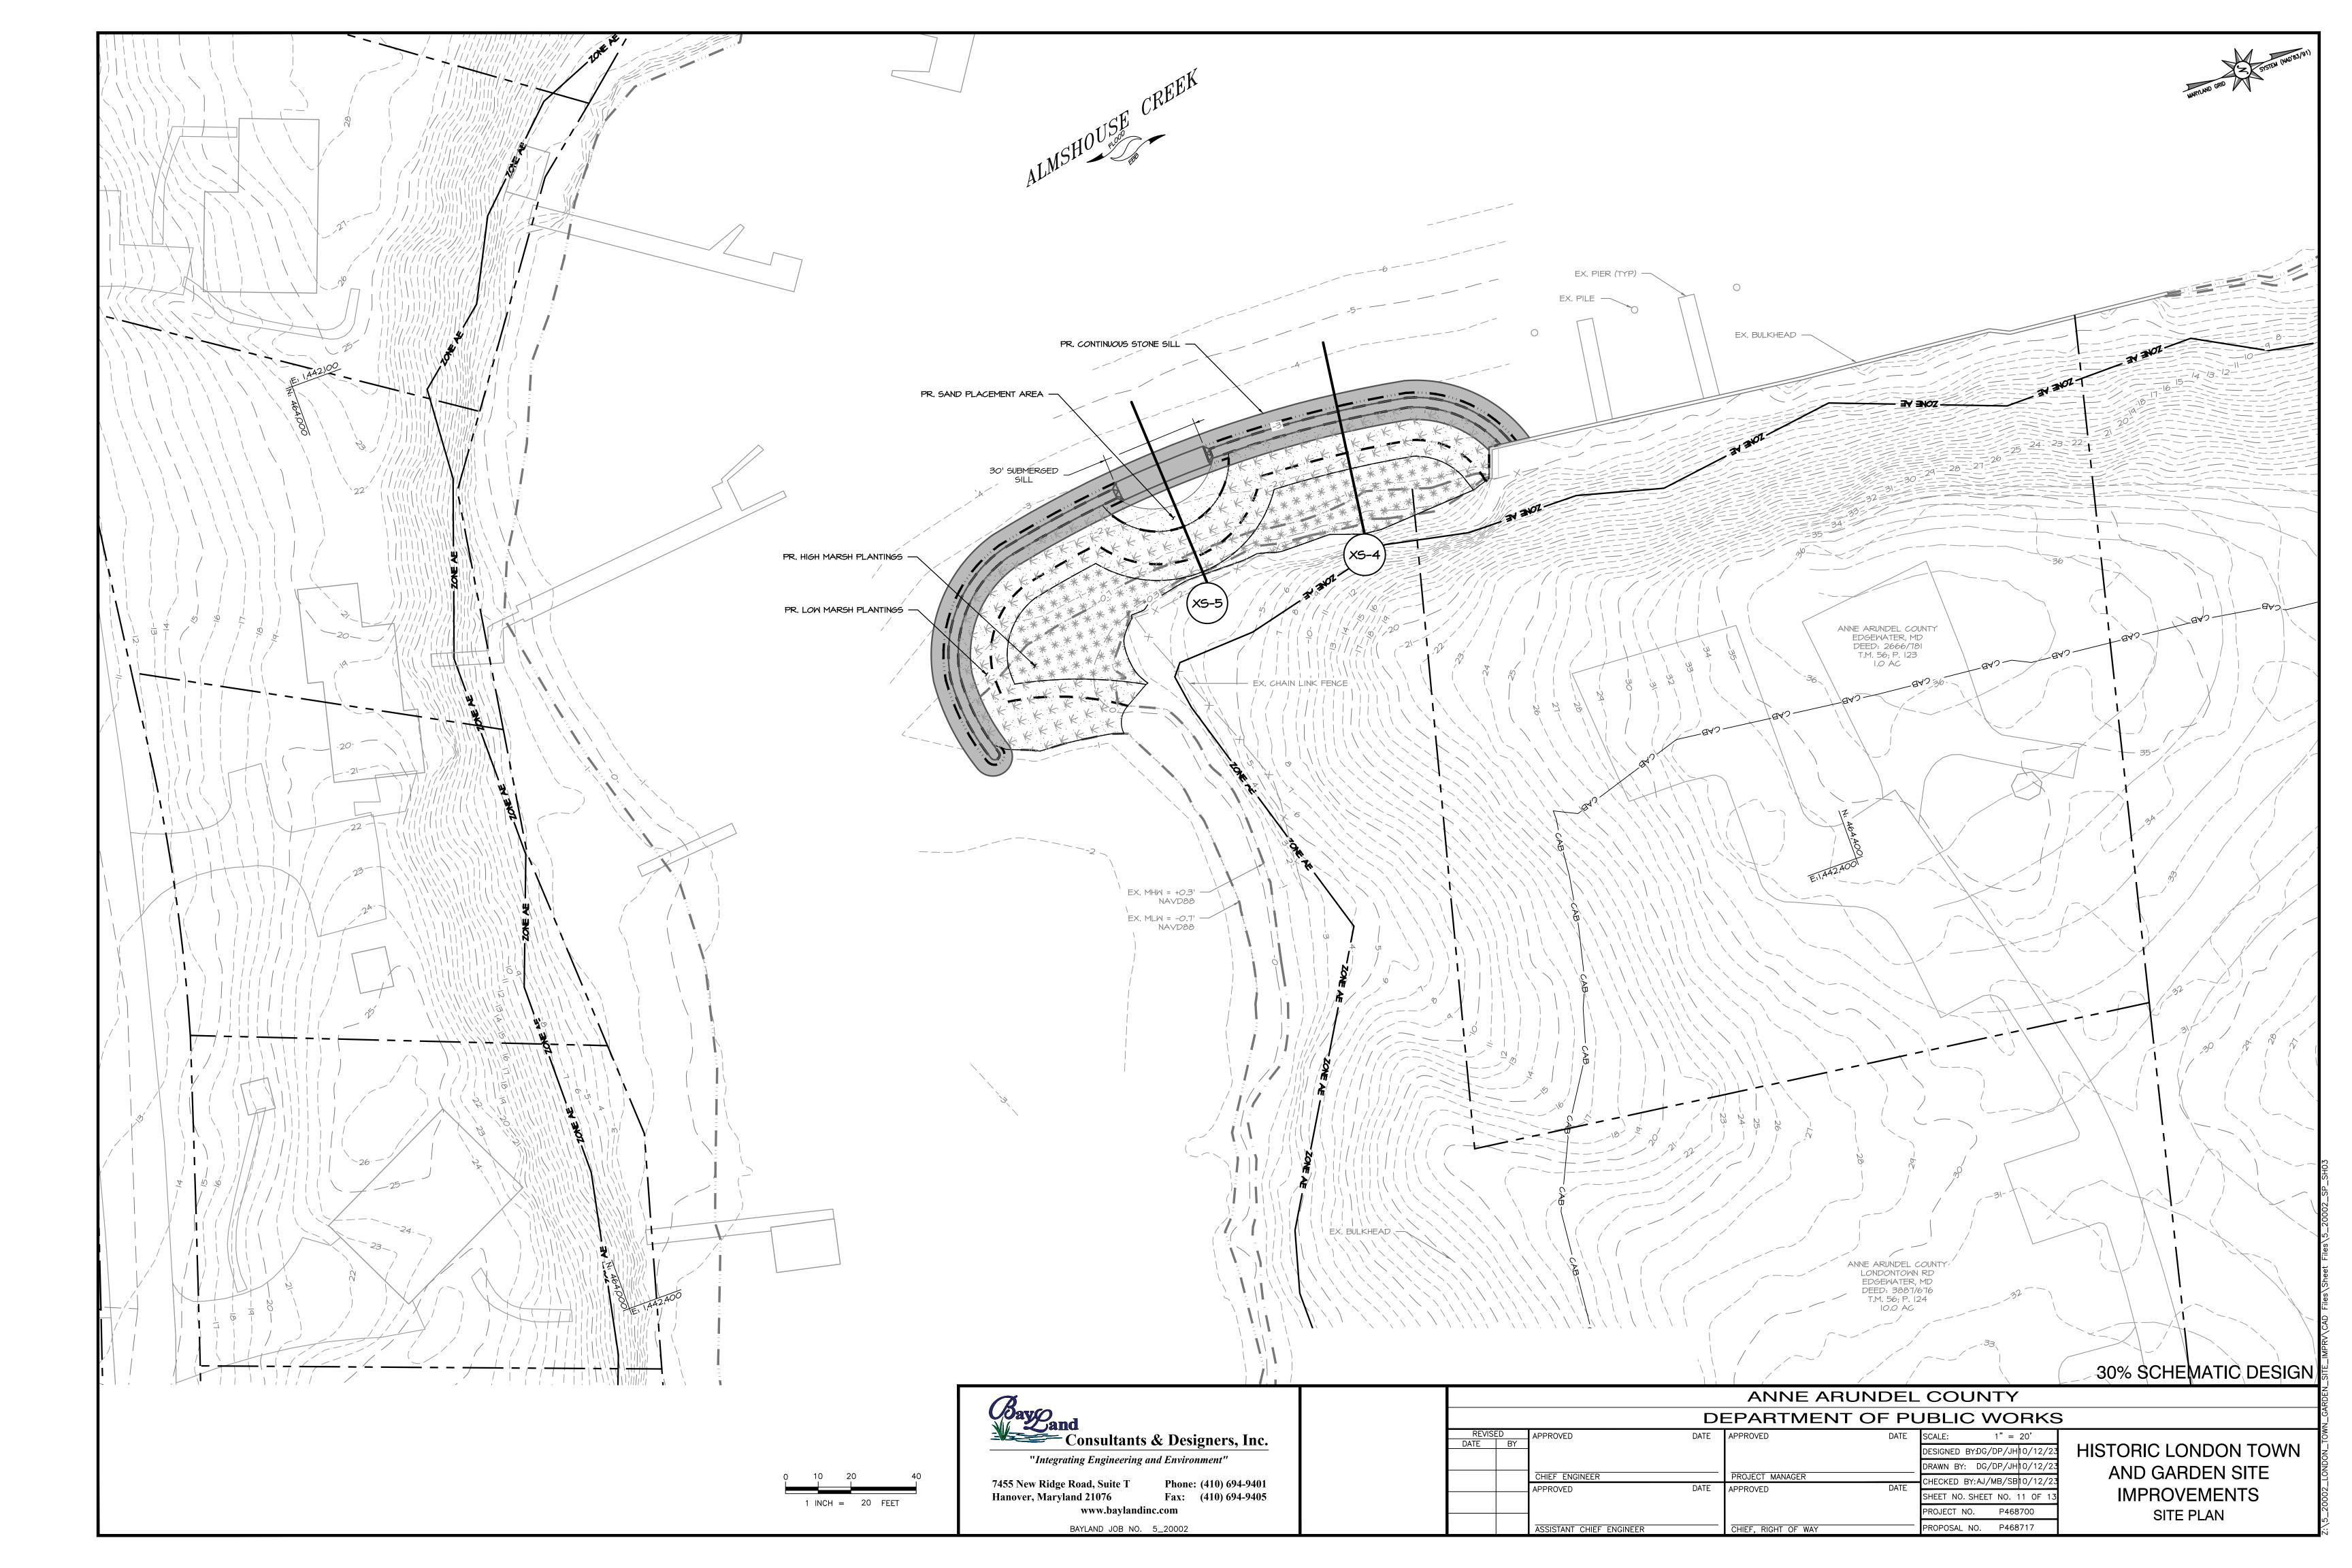

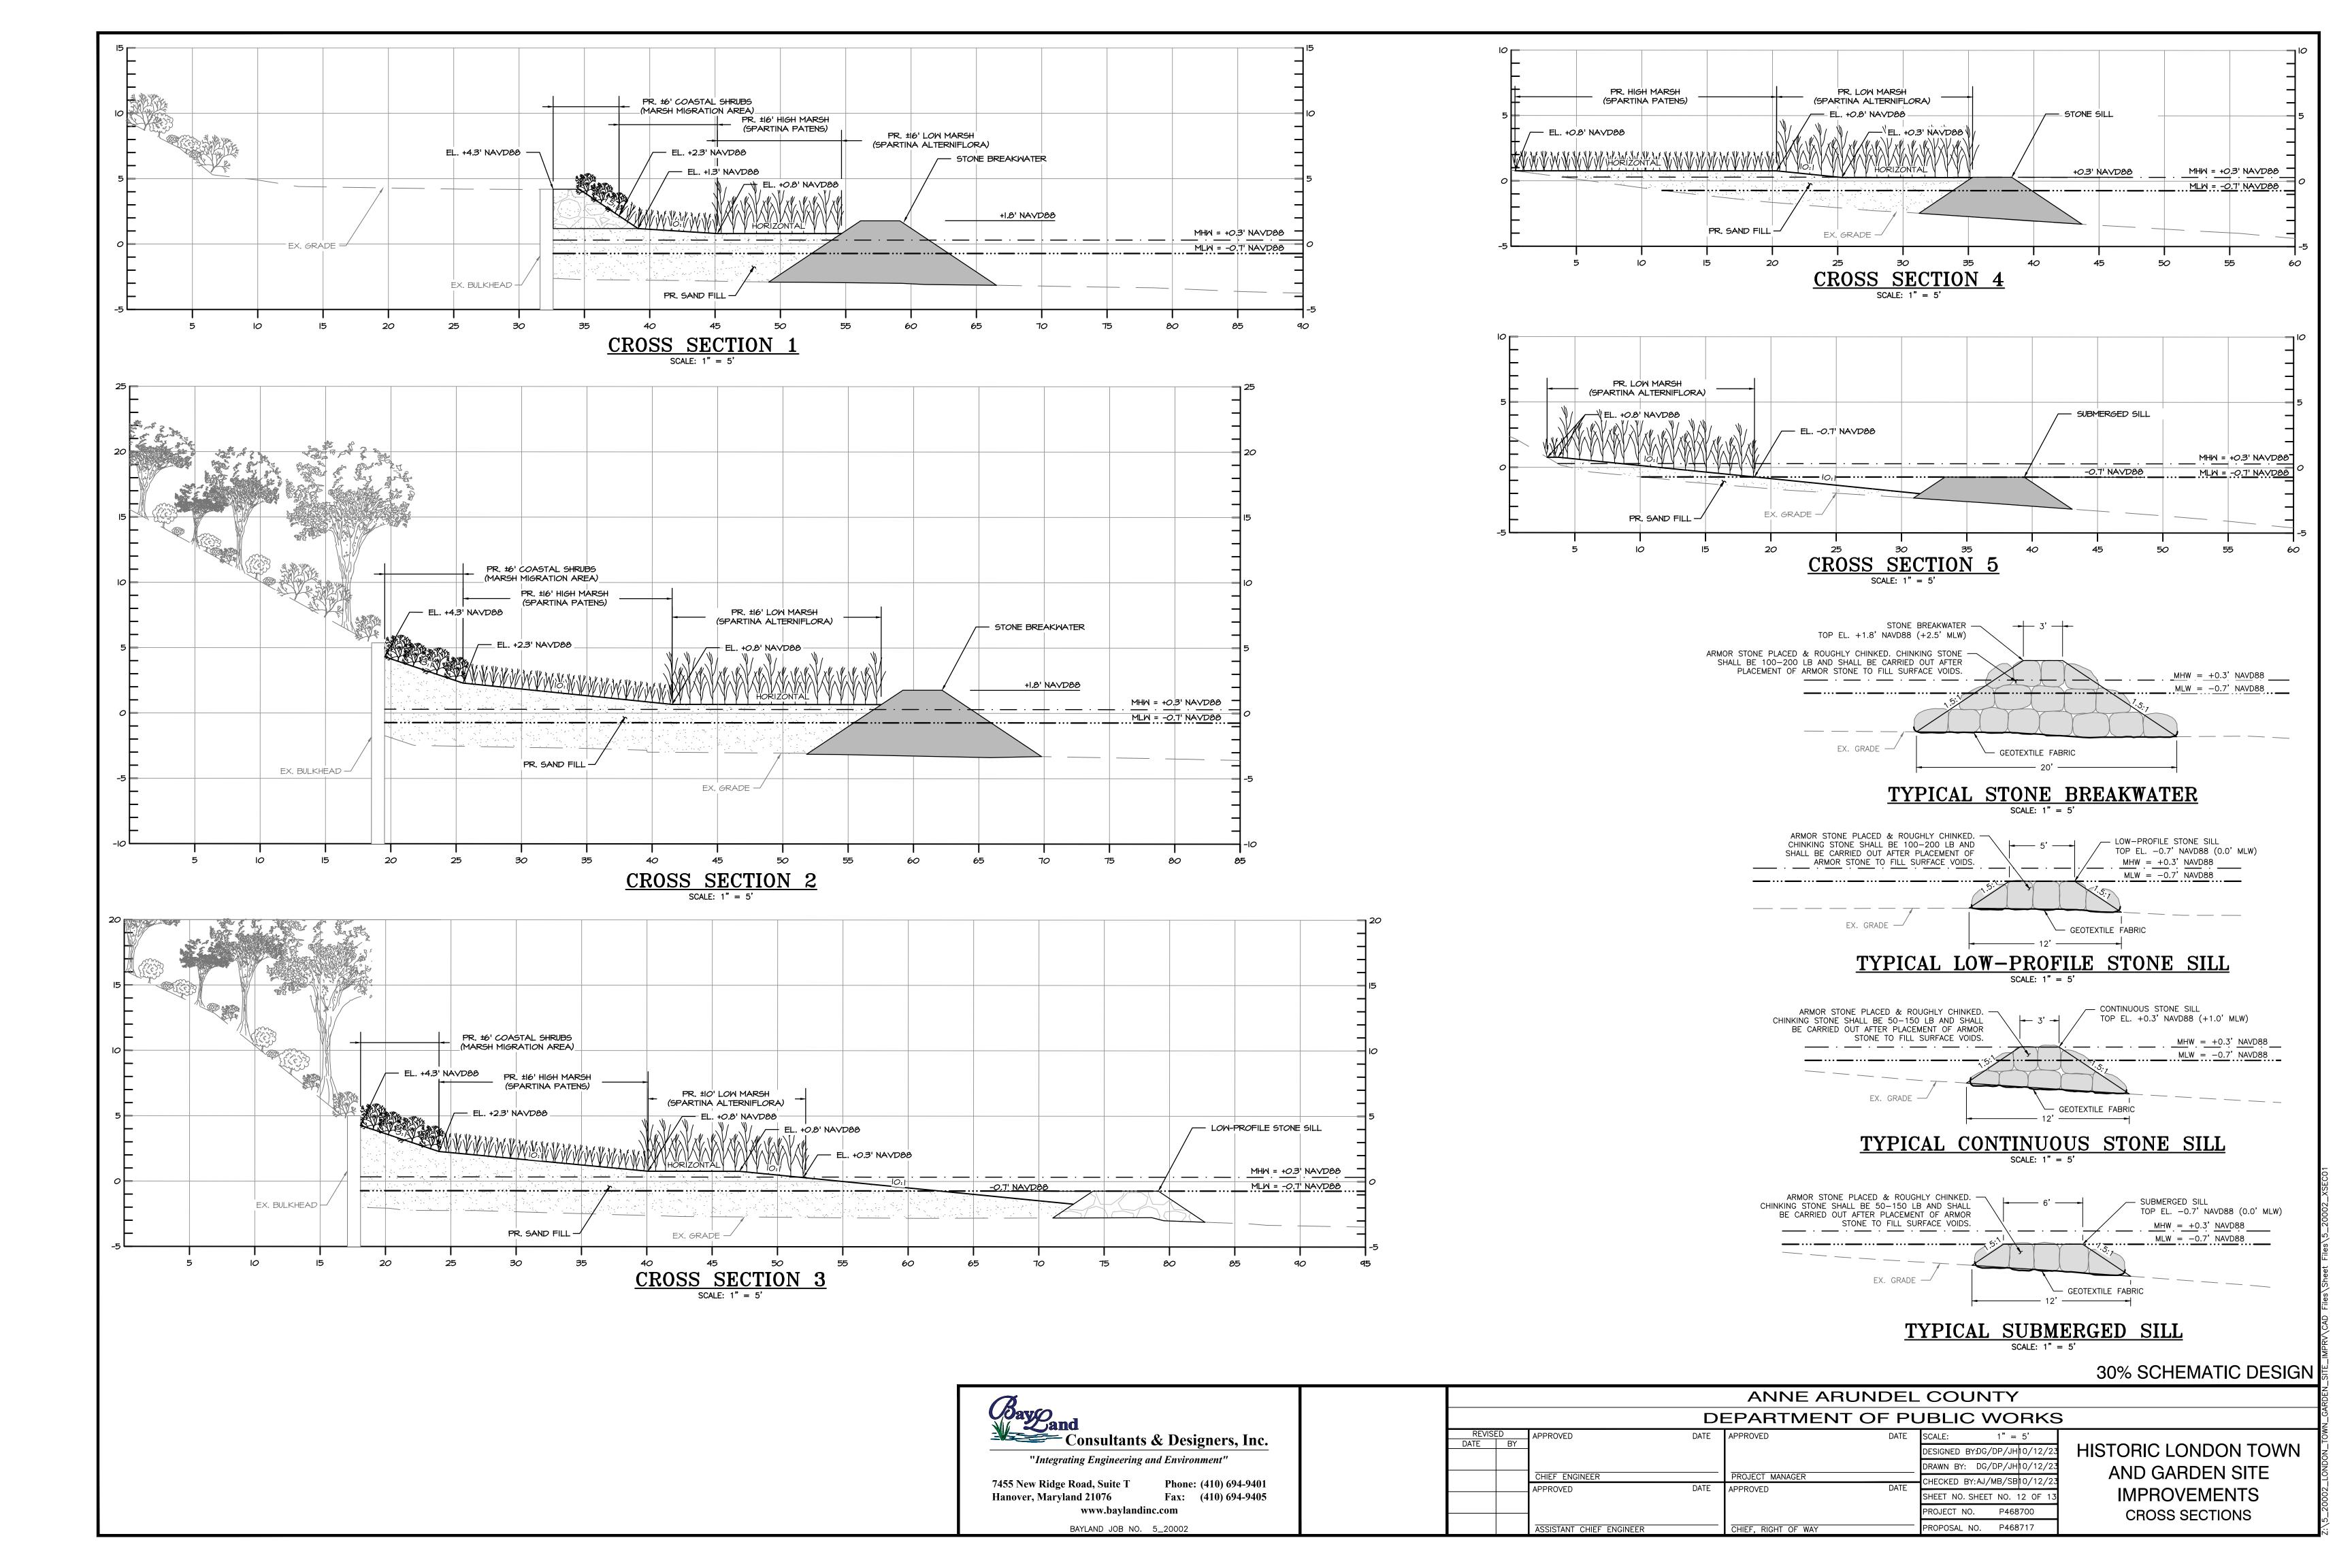

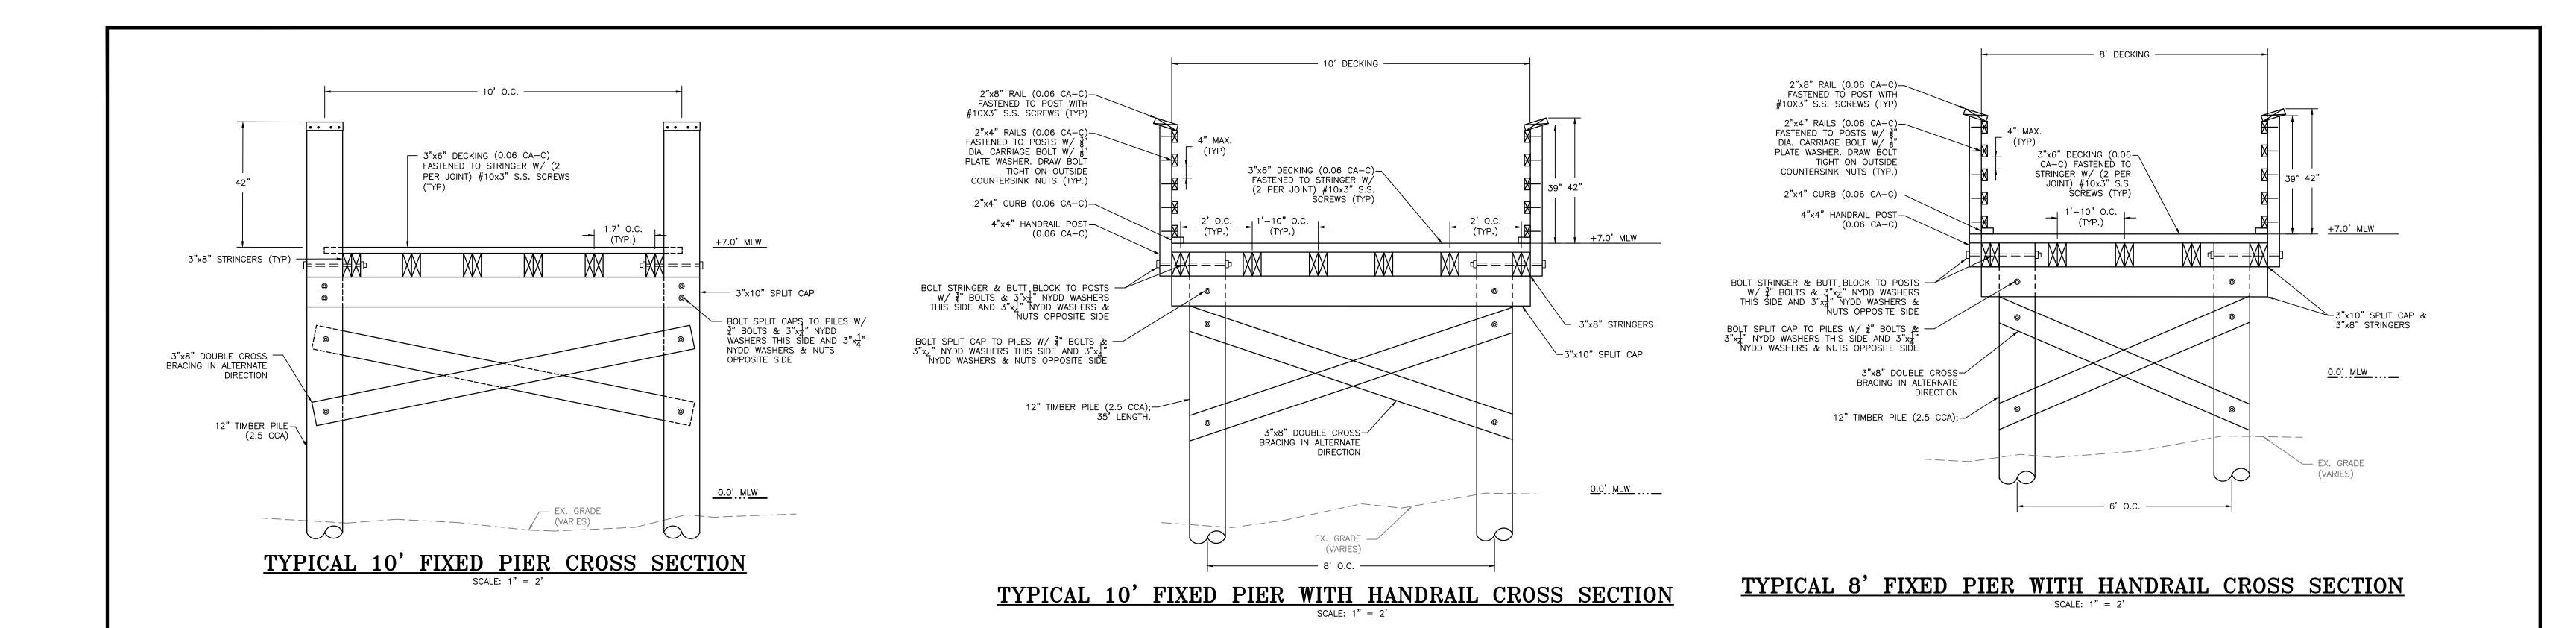

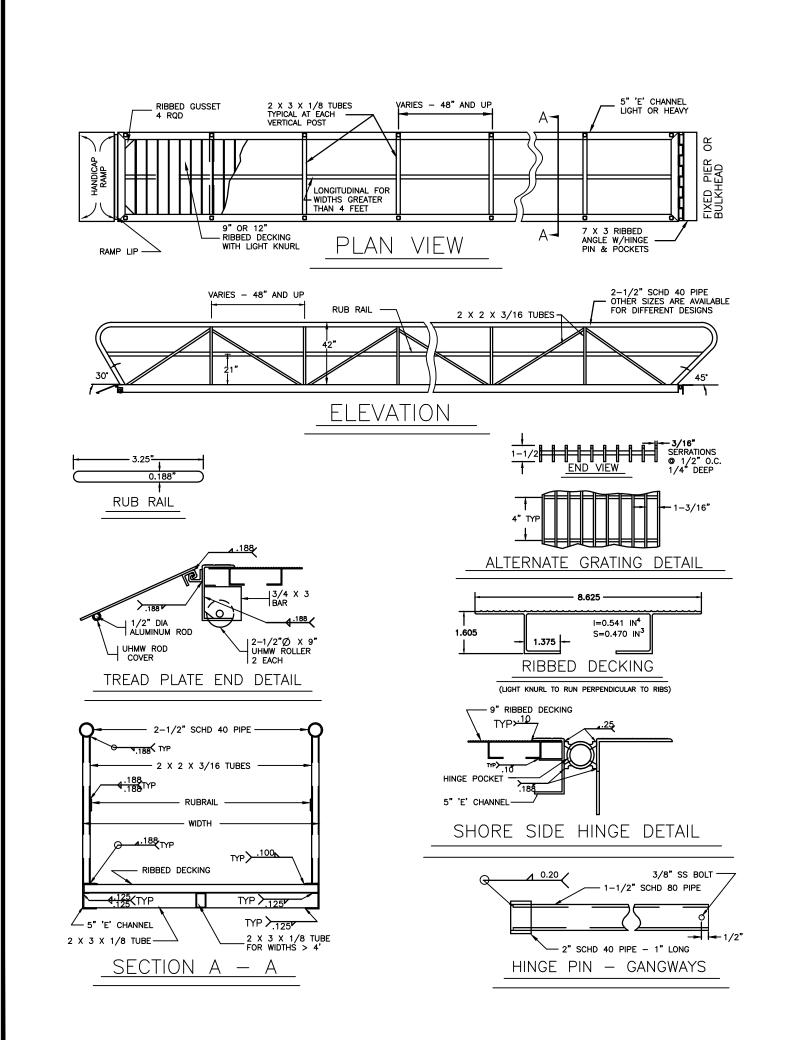

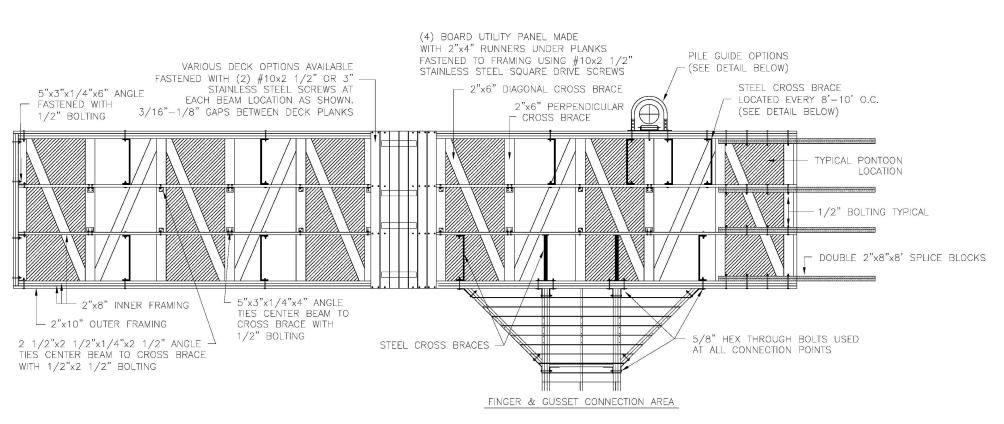

TYPICAL MEECO SULLIVAN FLOATING PIER PLAN SCALE: NTS

	S DECKING (9 S AVAILABLE	5) SETS OF 1/2" BOLTS AT EACH SEAM AREA	IRON CLEAT VARIOUS SIZES AVAILABLE 4' APART APART	OPTIONAL DOCK	OR STAINLESS	
						: :
4'x8'x16" PONTOON	4'x8'x16" PONTOON	4'x8'x16" PONTOON	4'x8'x16" PONTOON	4'x8'x16" PONTOON	4'x8'x16" PONTOON	

TYPICAL MEECO SULLIVAN FLOATING PIER PROFILE

30% SCHEMATIC DESIGN

			ANNE ARUNDEL	COUNTY	
Coay Cand		DE	EPARTMENT OF PU	JBLIC WORKS	
Consultants & Designers, Inc.	REVISED AID DATE BY	APPROVED DATE		SCALE: AS SHOWN DESIGNED BY:DG/DP/JH 0/12/23	HISTORIC LONDON TOWN
"Integrating Engineering and Environment"		CHIEF ENGINEER		DRAWN BY: DG/DP/JH10/12/23 CHECKED BY:AJ/MB/SB10/12/23	AND GARDEN SITE
7455 New Ridge Road, Suite T Phone: (410) 694-9401 Hanover, Maryland 21076 Fax: (410) 694-9405	Al	APPROVED DATE	APPROVED DATE	SHEET NO. SHEET NO. 13 OF 13	IMPROVEMENTS §
www.baylandinc.com BAYLAND JOB NO. 5_20002		ASSISTANT CHIEF ENGINEER	CHIEF, RIGHT OF WAY	PROJECT NO. P468700 PROPOSAL NO. P468717	PIER DETAILS