
1. a.	I (WE) CERTIFY THAT: ALL DEVELOPMENT AND CONSTRUCTION WILL BE DONE IN ACCORDANCE WITH THIS SEDIMENT AND EROSION	
1.	CONTROL PLAN, AND FURTHER, AUTHORIZE THE RIGHT OF ENTRY FOR PERIODIC ON-SITE EVALUATION BY THE ANNE ARUNDEL SOIL CONSERVATION DISTRICT (AASCD) BOARD OF SUPERVISORS OR THEIR AUTHORIZED AGENTS	S.
).	ANY RESPONSIBLE PERSONNEL INVOLVED IN THE CONSTRUCTION PROJECT WILL HAVE A CERTIFICATE OF ATTENDANCE FROM THE MARYLAND DEPARTMENT OF THE ENVIRONMENT'S APPROVED TRAINING PROGRAM FOR THE CONTROL OF SEDIMENT AND EROSION BEFORE BEGINNING THE PROJECT. RESPONSIBLE PERSONNEL ON SITE:	
-	IF APPLICABLE, THE APPROPRIATE ENCLOSURE WILL BE CONSTRUCTED AND MAINTAINED ON SEDIMENT BASIN(S) INCLUDED IN THIS PLAN. SUCH STRUCTURE(S) WILL BE IN COMPLIANCE WITH THE ANNE ARUNDEL COUNTY CODE.	
	THE DEVELOPER IS RESPONSIBLE FOR THE ACQUISITION OF ALL EASEMENTS, RIGHT, AND/OR RIGHTS-OF-WAY TH/ BE REQUIRED FOR THE SEDIMENT AND EROSION CONTROL PRACTICES, STORM WATER MANAGEMENT PRACTICES DISCHARGE OF STORM WATER ONTO OR ACROSS ADJACENT OR DOWNSTREAM PROPERTIES INCLUDED IN THE PL FOR INITIAL SOIL DISTURBANCE OR RE-DISTURBANCE, PERMANENT AND/OR TEMPORARY STABILIZATION PER THE AASCD VEGETATIVE ESTABLISHMENT SHALL BE COMPLETED WITHIN THREE CALENDAR DAYS FOR THE SURFACE OF CONTROLS, DIKES, SWALES, DITCHES, PERIMETER SLOPES AND ALL SLOPES GREATER THAN 3 HORIZONTAL TO 1 V (3:1) AND SEVEN DAYS FOR ALL OTHER DISTURBED OR GRADED AREAS ON THE PROJECT SITE.	S AND T .AN. OF ALL
•	THE GRADING AND SEDIMENT CONTROL APPROVAL ON THIS PLAN EXTENDS ONLY TO THOSE AREAS WITHIN THE L OF DISTURBANCE.	.IMITS
•	THE APPROVAL OF THIS PLAN FOR SEDIMENT AND EROSION CONTROL DOES NOT RELIEVE THE DEVELOPER/CONS FROM COMPLYING WITH FEDERAL, STATE OR COUNTY REQUIREMENTS PERTAINING TO ENVIRONMENTAL ISSUES. THE DEVELOPER MUST REQUEST THAT THE SEDIMENT AND EROSION CONTROL INSPECTOR APPROVE WORK COM	IPLETEI
	IN ACCORDANCE WITH THE APPROVED EROSION AND SEDIMENT CONTROL PLAN, THE GRADING OR BUILDING PERI AND THE ORDINANCE.	MII,
, 3_	ALL MATERIAL SHALL BE TAKEN TO A SITE WITH AN APPROVED SEDIMENT AND EROSION CONTROL PLAN. FIRST PHASE INSPECTION AND APPROVAL OF THE SEDIMENT AND EROSION CONTROL INSPECTOR SHALL BE REQUUPON COMPLETION OF THE INSTALLATION OF EROSION AND SEDIMENT CONTROLS PRIOR TO PROCEEDING WITH A OTHER EARTH DISTURBANCE OR GRADING. OTHER BUILDING OR GRADING INSPECTION APPROVALS MAY NOT BE AUTHORIZED UNTIL THE INITIAL APPROVAL BY THE SEDIMENT AND EROSION CONTROL INSPECTOR IS GIVEN. INSPECTION AND PERMITS MAY ALSO REQUIRE THAT AN INSPECTION AND CERTIFICATION OF THE INSTALLATION OF SEDIMENT CONTROL ALSO BE PERFORMED BY A DESIGN PROFESSIONAL PRIOR TO CONSTRUCTION COMMENCING.	ANY ECTION
	APPROVAL FROM THE INSPECTOR MUST BE REQUESTED ON FINAL STABILIZATION OF ALL SITES PRIOR TO REMOVAL SEDIMENT AND EROSION CONTROLS.	AL OF
0.	EXISTING TOPOGRAPHY MUST BE FIELD VERIFIED BY RESPONSIBLE PERSONNEL TO THE SATISFACTION OF THE SE CONTROL INSPECTOR PRIOR TO COMMENCING WORK.	EDIMEN
	ATURE OF DEVELOPER/OWNER DATE T NAME:	
ritli Addi	E: RESS: ANNE ARUNDEL COUNTY DEPARTMENT OF PUBLIC WORKS 2662 RIVA ROAD ANNAPOLIS, MARYLAND 21401	
ELE	PHONE NUMBER:	
	NSULTANT'S CERTIFICATION DEVELOPER'S PLAN TO CONTROL SILT AND EROSION IS ADEQUATE TO CONTAIN THE SILT AND EROSION	
OWN MD F	MENT CONTROL. I HAVE REVIEWED THIS EROSION AND SEDIMENT CONTROL PLAN WITH THE ER/DEVELOPER. .E. LICENSE #27734	
	AND SURVEYOR LICENSE #	
	ANDSCAPE ARCHITECT #	
	DATE	
NTIC NOTE	STATE ZIP CODE E: THE CONSULTANT'S CERTIFICATION MUST BE SIGNED AND SEALED BY A PROFESSIONAL	
ING	NEER IF THE SITE LIES WITHIN THE SEVERN RIVER WATERSHED.	
	ALL CONSTRUCTION SHALL BE IN ACCORDANCE WITH ANNE ARUNDEL COUNTY STANDARD SPECIFICATIONS AND/OR DETAILS FOR CONSTRUCTION AND THE STATE HIGHWAY ADMINISTRATION'S HIGHWAY DRAINAGE MANUAL STANDARD SPECIFICATIONS AND DETAILS	
	FOR CONSTRUCTION UNLESS OTHERWISE NOTED. THE EXISTING UTILITIES AND OBSTRUCTIONS SHOWN ARE FROM THE BEST AVAILABLE RECORDS AND SHALL BE VERIFIED BY THE CONTRACTOR TO HIS SATISFACTION PRIOR TO CONSTRUCTION. NECESSARY PRECAUTIONS SHALL BE TAKEN BY THE CONTRACTOR TO PROTECT EXISTING SERVICES AND MAINS AND ANY DAMAGE TO THEM SHALL BE REPAIRED IMMEDIATELY AT HIS OWN EXPENSE.	
	THE CONTRACTOR SHALL CONTACT "MISS UTILITY" AT 1-800-257-7777 A MINIMUM OF 96 HOURS IN ADVANCE OF ANY EXCAVATION, BORING, PILE DRIVING AND/OR DIGGING FOR THE LOCATION OF GAS, ELECTRIC, TELEPHONE, WATER AND SEWER LINES,	
	MECHANICAL EXCAVATION SHALL NOT BE CONDUCTED WITHIN 3 FEET HORIZONTALLY OR WITHIN 2 FEET VERTICALLY OF KNOWN UTILITY LOCATIONS. HAND OR SOFT DIGGING SHALL BE DONE WITHIN THESE LIMITS. UNDERGROUND UTILITIES, ONCE UNCOVERED, SHALL BE PROTECTED FROM BEING STRUCK BY EQUIPMENT.	14.
	IT SHALL BE DISTINCTLY UNDERSTOOD THAT FAILURE TO MENTION SPECIFICALLY ANY WORK WHICH WOULD NATURALLY BE REQUIRED TO COMPLETE THE PROJECT SHALL NOT RELIEVE THE CONTRACTOR OF HIS RESPONSIBILITY TO COMPLETE SUCH WORK.	15.
	ALL EXCESS SOIL SHALL BE REMOVED FROM THE SITE AND DISPOSED OF AT AN APPROVED DISPOSAL LOCATION.	
•	DISTURBANCES THAT DO NOT DRAIN TO A SEDIMENT CONTROL DEVICE SHALL BE STABILIZED BY THE END OF THE WORKDAY. NO MORE AREA SHALL BE DISTURBED THAN CAN BE STABILIZED BY THE END OF THE WORKDAY. NO DISTURBED AREA SHALL BE LEFT UNSTABILIZED OVERNIGHT UNLESS THE RUNOFF IS DIRECTED TO AN APPROVED SEDIMENT CONTROL DEVICE. SLOPES SHALL BE STABILIZED IMMEDIATELY WITH TOPSOIL, SEED AND EROSION CONTROL MATTING (IF REQUIRED). SEE NOTE #16.	16.
		17
	ALL FILL AREAS SHALL BE CLEANED OF ALL VEGETATION AND DEBRIS PRIOR TO THE PLACEMENT OF FILL. FILL MATERIAL SHALL BE PLACED IN CONTROLLED LIFTS WITH A MAXIMUM THICKNESS OF 8" PRIOR TO COMPACTION THAT IS CONTINUOUS OVER THE ENTIRE AREA OF FILL EACH LAYER OF FILL SHALL BE COMPACTED WITH THE MINIMUM NUMBER OF PASSES NECESSARY TO PRODUCE A FULL ASYMPTOTIC COMPACTION.	17. 18.
	ALL FILL AREAS SHALL BE CLEANED OF ALL VEGETATION AND DEBRIS PRIOR TO THE PLACEMENT OF FILL. FILL MATERIAL SHALL BE PLACED IN CONTROLLED LIFTS WITH A MAXIMUM THICKNESS OF 8" PRIOR TO COMPACTION THAT IS CONTINUOUS OVER THE ENTIRE AREA OF FILL EACH LAYER OF FILL SHALL BE COMPACTED WITH THE MINIMUM NUMBER OF PASSES NECESSARY TO PRODUCE A FULL	
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0.	ALL FILL AREAS SHALL BE CLEANED OF ALL VEGETATION AND DEBRIS PRIOR TO THE PLACEMENT OF FILL. FILL MATERIAL SHALL BE PLACED IN CONTROLLED LIFTS WITH A MAXIMUM THICKNESS OF 8" PRIOR TO COMPACTION THAT IS CONTINUOUS OVER THE ENTIRE AREA OF FILL EACH LAYER OF FILL SHALL BE COMPACTED WITH THE MINIMUM NUMBER OF PASSES NECESSARY TO PRODUCE A FULL ASYMPTOTIC COMPACTION. ALL STONE USED FOR THE PROTECTIONS WORK SHALL BE DURABLE QUARRIED STONE. THE STONE SHALL BE HARD AND ANGULAR, FREE FROM EITHER LAMINATIONS, WEAK CLEAVAGES, OR UNDESIRABLE WEATHERING, AND OF SUCH CHARACTER THAT IT WILL NOT DISINTEGRATE FROM THE ACTION OF AIR, SALT, WATER, OR HANDLING. SEDIMENTARY STONE WILL GENERALLY BE UNACCEPTABLE. INDIVIDUAL STONES WILL BE FREE FROM THIN, SLABBY PIECES HAVING A MAXIMUM DIMENSION OF MORE THAN THREE AND ONE-HALF TIMES THE LEAST DIMENSION. ANY EXCAVATION THAT MEETS SAND FILL REQUIREMENTS MAY BE REUSED. OTHERWISE, UNSUITABLE MATERIAL IS TO BE DISPOSED	18. 19. 20.
7. 3. 0. 1.	ALL FILL AREAS SHALL BE CLEANED OF ALL VEGETATION AND DEBRIS PRIOR TO THE PLACEMENT OF FILL. FILL MATERIAL SHALL BE PLACED IN CONTROLLED LIFTS WITH A MAXIMUM THICKNESS OF 8" PRIOR TO COMPACTION THAT IS CONTINUOUS OVER THE ENTIRE AREA OF FILL EACH LAYER OF FILL SHALL BE COMPACTED WITH THE MINIMUM NUMBER OF PASSES NECESSARY TO PRODUCE A FULL ASYMPTOTIC COMPACTION. ALL STONE USED FOR THE PROTECTIONS WORK SHALL BE DURABLE QUARRIED STONE. THE STONE SHALL BE HARD AND ANGULAR, FREE FROM EITHER LAMINATIONS, WEAK CLEAVAGES, OR UNDESIRABLE WEATHERING, AND OF SUCH CHARACTER THAT IT WILL NOT DISINTEGRATE FROM THE ACTION OF AIR, SALT, WATER, OR HANDLING. SEDIMENTARY STONE WILL GENERALLY BE UNACCEPTABLE. INDIVIDUAL STONES WILL BE FREE FROM THIN, SLABBY PIECES HAVING A MAXIMUM DIMENSION OF MORE THAN THREE AND ONE-HALF TIMES THE LEAST DIMENSION. ANY EXCAVATION THAT MEETS SAND FILL REQUIREMENTS MAY BE REUSED. OTHERWISE, UNSUITABLE MATERIAL IS TO BE DISPOSED OF AT AN APPROVED LOCATION.	18. 19. 20.


CAUTION:

IF THIS DRAWING IS A REDUCTION, USE THE GRAPHIC SCALES.

ANNE ARUNDEL COUNTY MARYLAND DEPARTMENT OF PUBLIC WORKS DEALE COMMUNITY PARK

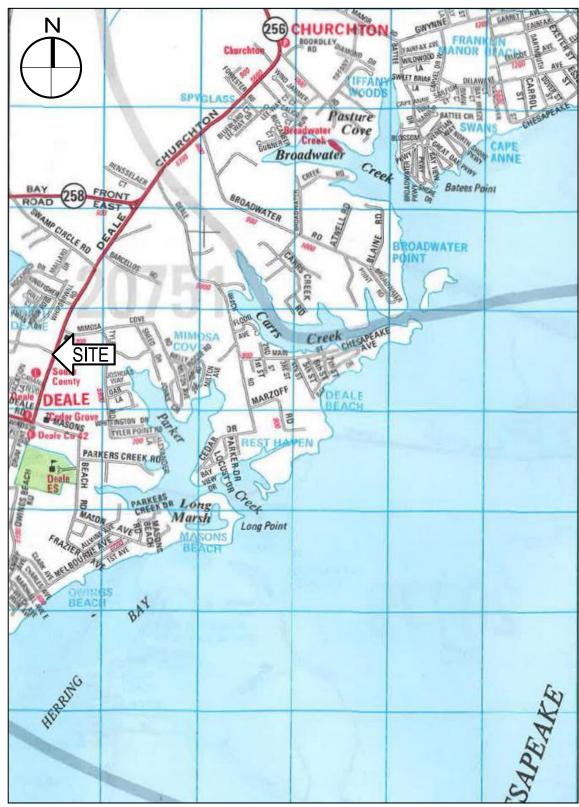

- DISTURBED AREAS SHALL HAVE PERMANENT OR TEMPORARY STABILIZATION COMPLETED WITHIN: EE CALENDAR DAYS ON SLOPES GREATER THAN 3:1 AND TO THE SURFACE OF ALL PERIMETER SEDIMENT CONTROLS. EN CALENDAR DAYS AS TO ALL OTHER DISTURBED OR GRADED AREAS.
- NOT TO BE REMOVED SHALL BE PROTECTED WITH TREE PROTECTION FENCING OR TREE REINFORCED PLANKING.
- A SUFFICIENT DESIGN SHEAR STRESS FOR THE APPLICATION OR AS SHOWN ON THE APPROVED SEDIMENT AND EROSION ITROL PLANS.
- L BE SWEPT BEFORE THE END OF EACH WORK DAY.
- STAKING, RE-STAKING, AND CUT SHEETS SHALL BE PERFORMED BY A REGISTERED LAND SURVEYOR OR PROFESSIONAL INEER AT THE CONTRACTOR' S EXPENSE.
- CONSTRUCTION TO BE PERFORMED IN ACCORDANCE WITH STATE OF MARYLAND OCCUPATIONAL SAFETY LAWS.
- ITRACTOR MUST ENSURE THAT COPIES OF FEDERAL, STATE, AND COUNTY PERMITS ARE POSTED ON SITE PRIOR TO THE START ANY WORK.
- AS, ROADS, AND PAVED AREAS, ETC.

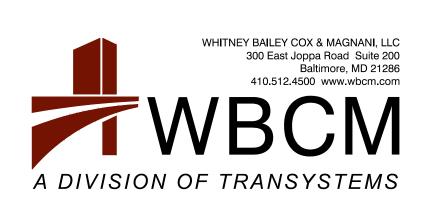


BID SET SUBMISSION - NOVEMBER 7, 2023 DEALE CHURCHTON ROAD, DEALE, MARYLAND 20751 PROJECT NO. P582000, CONTRACT NO. P582001

COPYRIGHT ADC, THE MAP PEOPLE PERMITTED USE NUMBER 20506148 MAP 34, A-6, 25TH EDITION

TREES WITH A DIAMETER GREATER THAN 12 INCHES WITHIN THE LIMIT OF DISTURBANCE SHALL NOT BE REMOVED UNLESS PRIOR ROVAL IS OBTAINED OR EXPLICITLY SHOWN ON THE PLANS TO BE REMOVED. ALL TREES WITHIN THE LIMIT OF DISTURBANCE, THAT DISTURBED AREAS WITH SLOPES GREATER THAN 3:1 SHALL BE STABILIZED WITH TEMPORARY SOIL STABILIZATION MATING THAT ROADS SHALL BE CLEANED AND CLEARED BY THE END OF EACH WORK DAY. ANY MUD OR ROCKS TRACKED ON THE ROADWAYS

ITRACTOR SHALL RESTORE ALL AREAS IMPACTED BY CONSTRUCTION ACTIVITY. THIS SHALL INCLUDE BUT NOT LIMITED TO GRASS

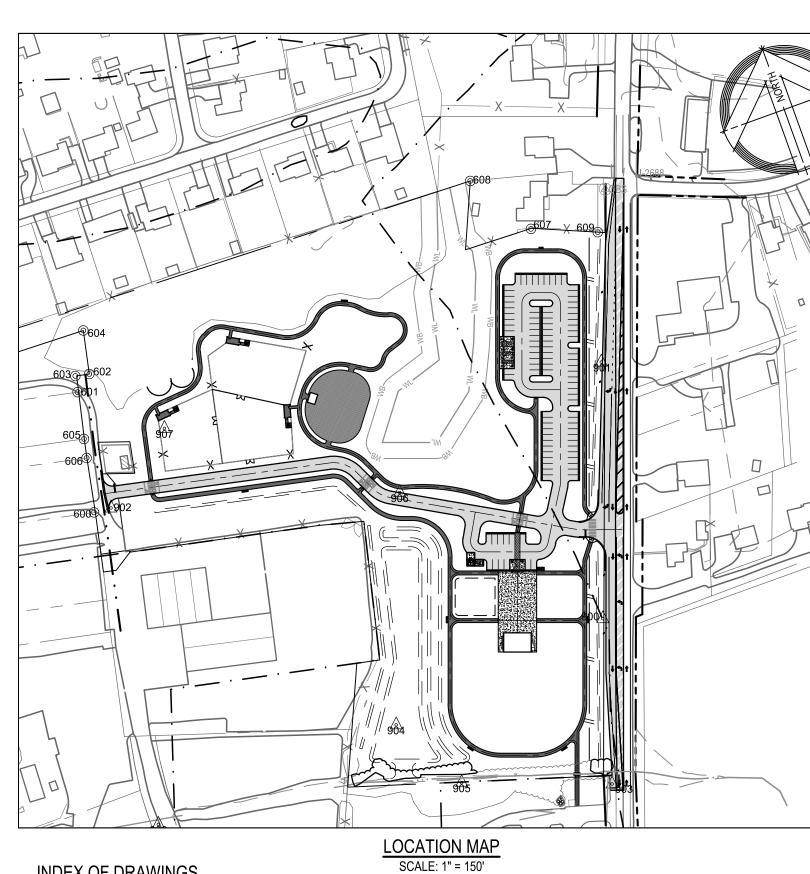

INDEX OF DRAWINGS


	DIVAMINOO				
<u>CIVIL</u>					
SHEET NO.	SHEET TITLE				
1.	COVER SHEET	29.	FROSION	AND SEDIMEN	IT CONTROL-PHASE #1
2.	OVERALL EXISTING CONDITIONS PLAN	30.			IT CONTROL-PHASE #2
3.	DEMOLITIONS PLAN	31.			IT CONTROL NOTES
4.	DEMOLITIONS PLAN	32.			IT CONTROL DETAILS
5.	OVERALL SITE LAYOUT PLAN	33.			IT CONTROL DETAILS
6.	SITE LAYOUT PLAN	34.		STAND DELINE	
7.	SITE LAYOUT PLAN	35.		CONSERVATIO	
8.	SITE DETAILS	36.			N PLAN NOTES AND DETAILS
9.	SITE DETAILS	ROADWAY IMPR			
10.	SITE DETAILS	SHEET NO.	SHEET T	-	
11.	SITE DETAILS	OHLLT NO.	UNELT I		
12.	SITE DETAILS	37.	ROADWA	Y IMPROVEME	NTS PLAN AND DETAILS
13.	OVERALL GRADING PLAN	38.	SIGNING	AND PAVEMEN	T MARKING PLAN
14.	GRADING PLAN	39.	MAINTEN	ANCE OF TRAF	FIC PLAN
15	GRADING PLAN	40.	LANDSCA	APE PLAN	
16.	PROFILES	41.	ROADWA	Y SECTIONS	
17.	STORMWATER MANAGEMENT OVERALL PLAN	42.	ROADWA	Y SECTIONS	
18.	STORMWATER MANAGEMENT PART PLAN	STRUCTURAL			
19.	STORMWATER MANAGEMENT PART PLAN	SHEET NO.	SHEET T		
20.	STORMWATER MANAGEMENT DETAILS	SHEET NO.			
21.	STORMWATER MANAGEMENT NOTES	43.	GENERA	L NOTES	
22.	CRITICAL AREA PLAN	44.	PAVILION	I FOUNDATION	PLAN
23.	EXISTING DRAINAGE AREA MAP	ELECTRICAL			
24.	PROPOSED DRAINAGE AREA MAP				
25.	WATER QUALITY MAP	SHEET NO.	<u>SHEET T</u>	IILE	
26.	LANDSCAPE PLAN	45.	ELECTR	CAL LEGEND	
27.	LANDSCAPE PLAN	46.		SITE PLAN ELI	ECTRICAL
28.	LANDSCAPE NOTES AND DETAILS	47.		& RISER DIAGR	
	REVISIONS				
NO.	DESCRIPTION	BY		DATE	
					-
					APPROVED
					CHIEF ENGINEER

approved by me, and that I am a duly licensed professional engineer under the laws of the State of Maryland. _icense #27734 Expiration Date: 07/12/2024

nereby certify that these documents were prepared or

ASSISTANT CHIEF ENGIN

APPROVED

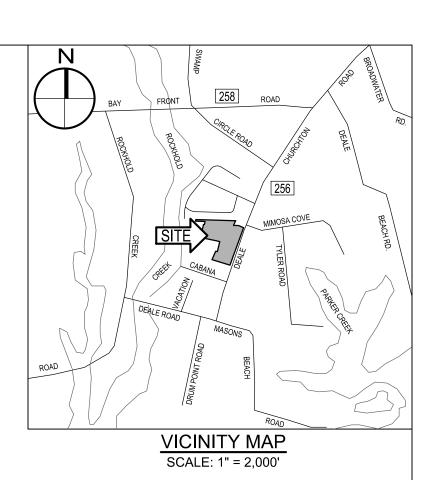


DESCRIPTION	EXISTING	DEMOLISH / REMOVE	NEW
BUILDING	EX. BLDG		
BITUMINOUS CONCRETE PAVING	EX. MACADAM		
PORTLAND CEMENT CONCRETE	EX. CONC.		
			4
BITUMINOUS CONCRETE MILL & OVERLAY	EX. MACADAM		
BITUMINOUS CONCRETE PEDESTRIAN WA	LK		
DECIDUOUS / EVERGREEN TREES	₩ <u>4</u> 12" ξ ^{(2,2} 6" (-) 3"	ﷺ 12" ﷺ 6" (🟹 3"	A share a shar
CLEAN OUT	۲۰/۱۹ کی تک ⊗ c.o.		
DRAIN INLET			\smile
ELECTRIC MH	Ē		
FIRE HYDRANT			
GAS VALVE	Ğ♥		
HAND BOX	⊠н.в.	⊠н.в.	
INLET MH	0		
UTILITY POLE	, C	Ŕ	
SANITARY MH	S	T	
SIGN (ONE-POST)			
STORM DRAIN MH	\bigcirc	-	Ó
STREET LIGHT	¢		U
TRAVERSE STATION			
BOLLARD	<u></u>	0	
WATER VALVE	\odot	\odot	
SPOT ELEVATION	+ 9.5		
MAJOR CONTOUR -	10		+ 9.5
	9		10 9
	Ŭ		y
CONC. CURB	· · · · · · · · · · · · · · · · · · ·		
SURVEY LIMITS ·	XXX		— x—— x——
			//
SPLIT RAIL FENCE LINE			1111
	OHE		
U/G FIBER OPTIC -	FO		
U/G GAS	G		
U/G SANITARY _	SS		
U/G STORM -	D	D	
UG WATER			
U/G COMMUNICATION	C		
PROPERTY LINE _			
RIGHT OF WAY -			
SOIL BORING	SWM#		LOD
LIMIT OF DISTURBANCE	• •		
SOIL LINES	SoA (B/D) SrA (B/D)		



Know what's below. Call before you dig


BID SET

DEPARTMENT OF PUBLIC WORKS							
DATE	DATE APPROVED DATE		DEALE COMMUNITY PARK				
		DRAWN BY: R.S.S.					
	PROJECT MANAGER	CHECKED BY: R.W.H.					
DATE	APPROVED DATE	SHEET NO. 01 OF 47	COVER SHEET				
		PROJECT NO.: P582001					
GINEER	CHIEF, RIGHT-OF-WAY	CONTRACT NO.: P582001					

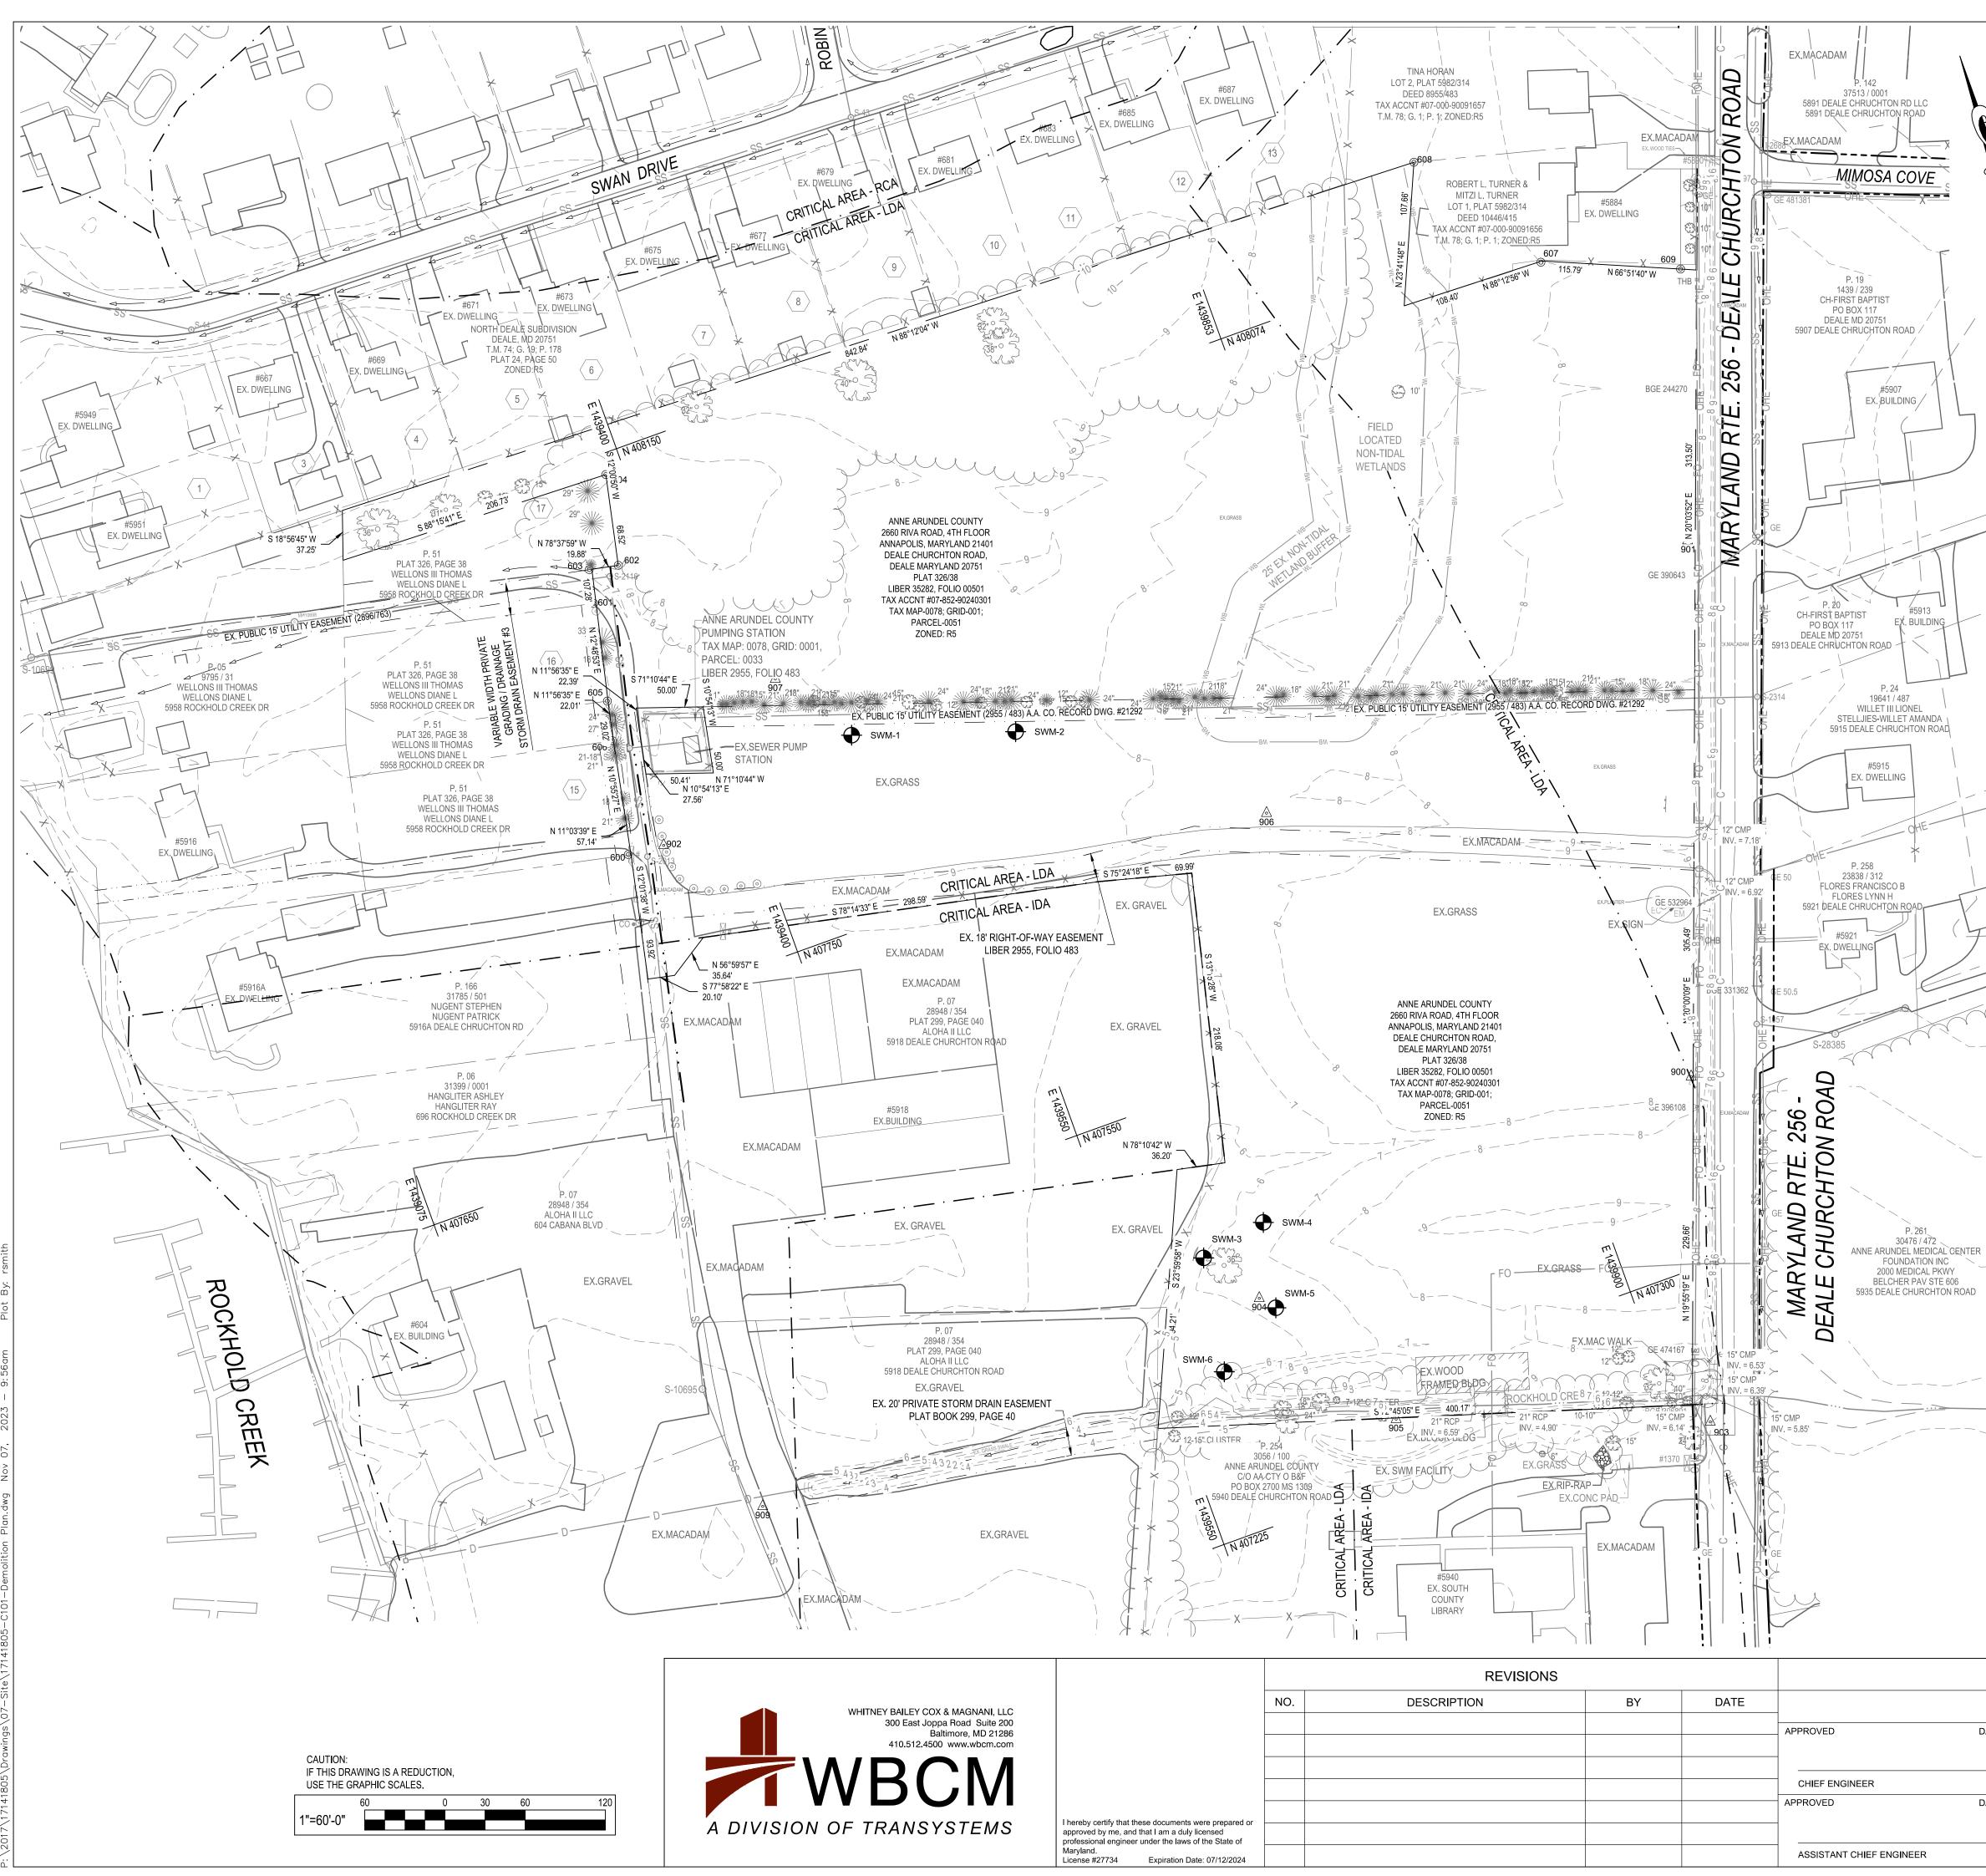

LITILITY SCHEDULE

TILLITY SCI	HEDULE				
TRUCTURE	TOP	DIR.	INVERT	SIZE & TYPE	
-1057	9.36				
-2004	8.27	Ν	-4.51	9-12"	
		S	-4.87	9-12"	
		Е	-5.09	9-12"	
-2013	8.35	Ν	-4.71	9-12"	
		S	-4.83	9-12"	
S-2116	7.79			BOLTED SHUT	
5-2314	8.89	W	3.54	6"	
		S	-0.74	36"	
		Ν	-0.80	36"	
6-2697	9.79	Ν	-1.28	24"	
		Е	-0.74	12"	
		S	-1.26	24"	

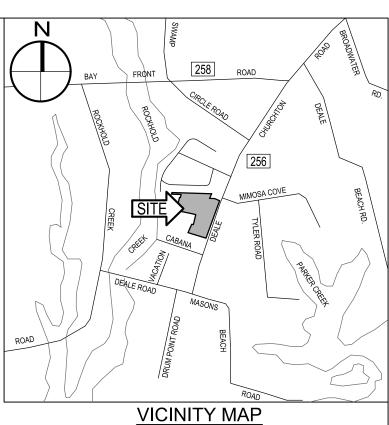

VICINITY MAP SCALE: 1" = 2,000'

LEGEND	
DESCRIPTION	EXISTING
BUILDING	EX. BLDG
BITUMINOUS CONCRETE PAVING	EX. MACADAM
PORTLAND CEMENT CONCRETE	EX. CONC.
BITUMINOUS CONCRETE MILL & OVERLAY	EX. MACADAM

SUF	RVEY TRA	AVERSE C	ONT	ROL LISTING
PT#	NORTHING	EASTING	ELEV.	DESCRIPTION
900	407,435.83	1,439,997.30	8.21	REBAR & CAP
901	407,813.91	1,440,130.68	8.61	REBAR & CAP
902	407,858.86	1,439,332.76	8.32	REBAR & CAP
903	407,187.94	1,439,923.33	8.67	REBAR & CAP
904	407,389.24	1,439,637.19	6.16	REBAR & CAP
905	407,269.48	1,439,702.90	6.65	REBAR & CAP
906	407,728.77	1,439,765.24	7.77	REBAR & CAP
907	407,947.67	1,439,453.50	7.77	REBAR & CAP
909	407,368.65	1,439,235.03	5.24	MAG NAIL SET

BITUMINOUS CONCRETE PEDESTRIAN WALK

#5913

P.261

DECIDUOUS / EVERGREEN TREES	
CLEAN OUT	
DRAIN INLET	
ELECTRIC MH	
FIRE HYDRANT	
GAS VALVE	
HAND BOX	
INLET MH	
UTILITY POLE	
SANITARY MH	
SIGN (ONE-POST)	
STORM DRAIN MH	
STREET LIGHT	
TRAVERSE STATION	
BOLLARD	
WATER VALVE	
SPOT ELEVATION	
MAJOR CONTOUR	
MINOR CONTOUR	
WALL	
CONC. CURB	
SURVEY LIMITS	• •
CHAIN LINK FENCE LINE	
SPLIT RAIL FENCE LINE	
O/H ELECTRIC	
U/G FIBER OPTIC	
U/G GAS	
U/G SANITARY	
U/G STORM	
UG WATER	
U/G COMMUNICATION	
PROPERTY LINE	
RIGHT OF WAY	
SOIL BORING	
LIMIT OF DISTURBANCE	
SOIL LINES	

TREES	3" ZMX = 12" = ~ ~ 6" (~ ~ 3"
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	+ 9.5
	+ 9.5
	9
	XXX
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	FO
	G
	SS
	W
	SWM#
	SoA (B/D)
	20A (B/D)

GENERAL NOTES

THIS PLAT IS BASED UPON A FIELD-RUN TOPOGRAPHIC SURVEY PERFORMED BY WBCM IN SEPTEMBER, 2021 AND REFLECTS SITE CONDITIONS AS OF THAT DATE.

SrA (B/D)


2. COORDINATES AND DIRECTIONS SHOWN HEREON ARE REFERRED TO THE MARYLAND STATE PLANE COORDINATE SYSTEM, NAD 83/2011 AS DETERMINED FROM REAL TIME KINEMATIC SURVEYING AS BROADCAST BY THE LEICA SMARTNET NETWORK.


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- 3. ELEVATIONS SHOWN HEREON ARE REFERRED TO THE NORTH AMERICAN VERTICAL DATUM OF 1988 (NAVD 88), AS DETERMINED BY R.T.K. G.P.S. OBSERVATIONS AS BROADCAST BY THE LEICA SMARTNET NETWORK(GEOID18).
- 4. ADDITIONAL SPOT ELEVATIONS RESIDE IN THE ELECTRONIC VERSION OF THIS DRAWING BUT ARE NOT PLOTTED HEREON.
- 5. THE LOCATION OF EXISTING UNDERGROUND UTILITIES IS SHOWN IN AN APPROXIMATE WAY ONLY. THE DESCRIPTION OF THE UNDERGROUND UTILITIES AS SHOWN HEREON WERE BASED SOLEY UPON FIELD OBSERVATIONS AND HAVE NOT BEEN COMPARED TO OR VERIFIED WITH RECORD UTILITY DRAWINGS OR FIELD TEST PITS. THE SIZE, TYPE AND LOCATION OF THE UTILITY LINES SHOULD BE VERIFIED BY THE USER OF THIS DRAWING.
- IT IS THE CONTRACTOR'S RESPONSIBILITY TO FIELD VERIFY ACTUAL SITE CONDITIONS PRIOR TO THE START OF ANY WORK. THERE IS NO WARRANTY OR GUARANTEE ON THE COMPLETENESS OR CORRECTNESS OF THE EXISTING CONDITION INFORMATION. ANY DISCREPANCY FOUND SHALL BE BROUGHT TO THE IMMEDIATE ATTENTION OF THE ARCHITECT/ENGINEER PRIOR TO THE START OF ANY WORK.
- 7. THE CONTRACTOR SHALL BE RESPONSIBLE FOR NOTIFYING "MISS UTILITY" AT 1-800-257-7777 THREE DAYS PRIOR TO THE START OF ANY EXCAVATION WORK.
- 8. THE WORDS "CERTIFY" OR "CERTIFICATION" AS USED HEREON ARE UNDERSTOOD TO BE AN EXPRESSION OF PROFESSIONAL OPINION BY THE UNDERSIGNED SURVEYOR, BASED UPON HIS BEST KNOWLEDGE, INFORMATION, AND BELIEF. AS SUCH, IT DOES NOT CONSTITUTE A GUARANTEE NOR A WARRANTY, EXPRESSED OR IMPLIED.

BID SET

DEPARTMENT OF PUBLIC WORKS							
DATE	APPROVED DATE	SCALE: 1" = 60'	DEALE COMMUNITY PARK				
		DRAWN BY: R.S.S.					
	PROJECT MANAGER	CHECKED BY: R.W.H.					
DATE	APPROVED DATE	SHEET NO. 02 OF 47	OVERALL EXISTING CONDITIONS				
		PROJECT NO.: P582001					
GINEER	CHIEF, RIGHT-OF-WAY	CONTRACT NO.: P582001					
		•	·				




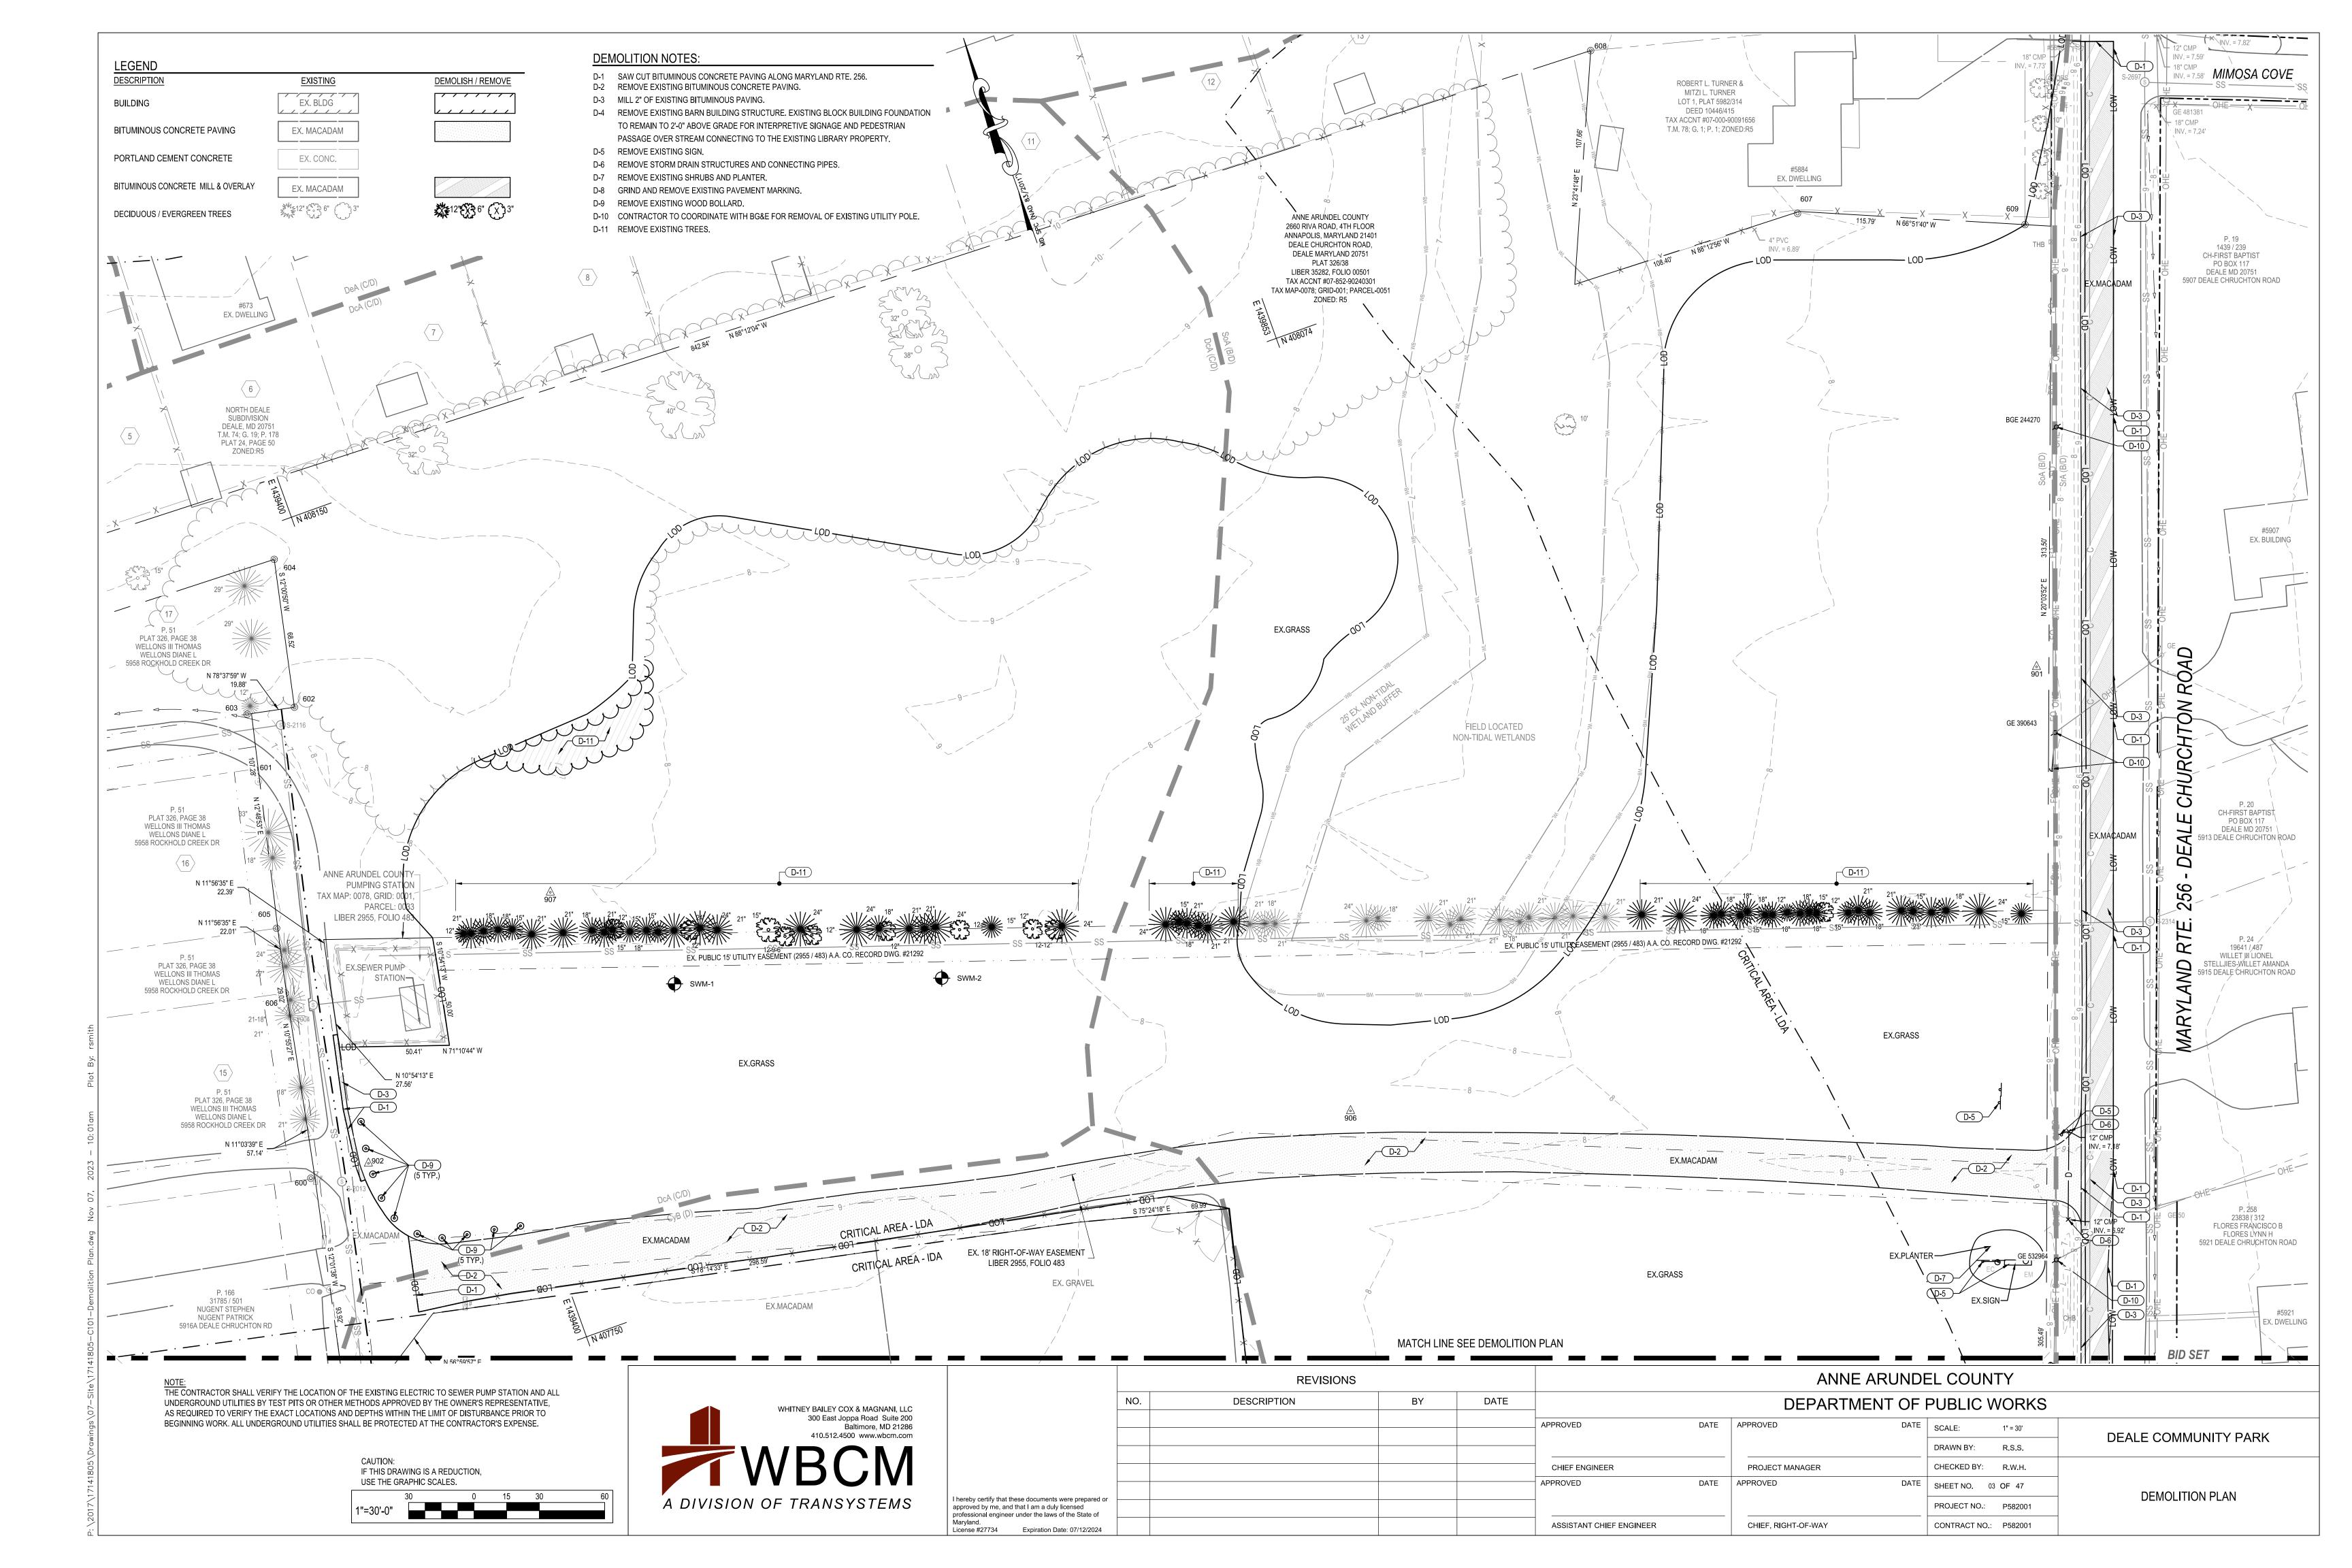

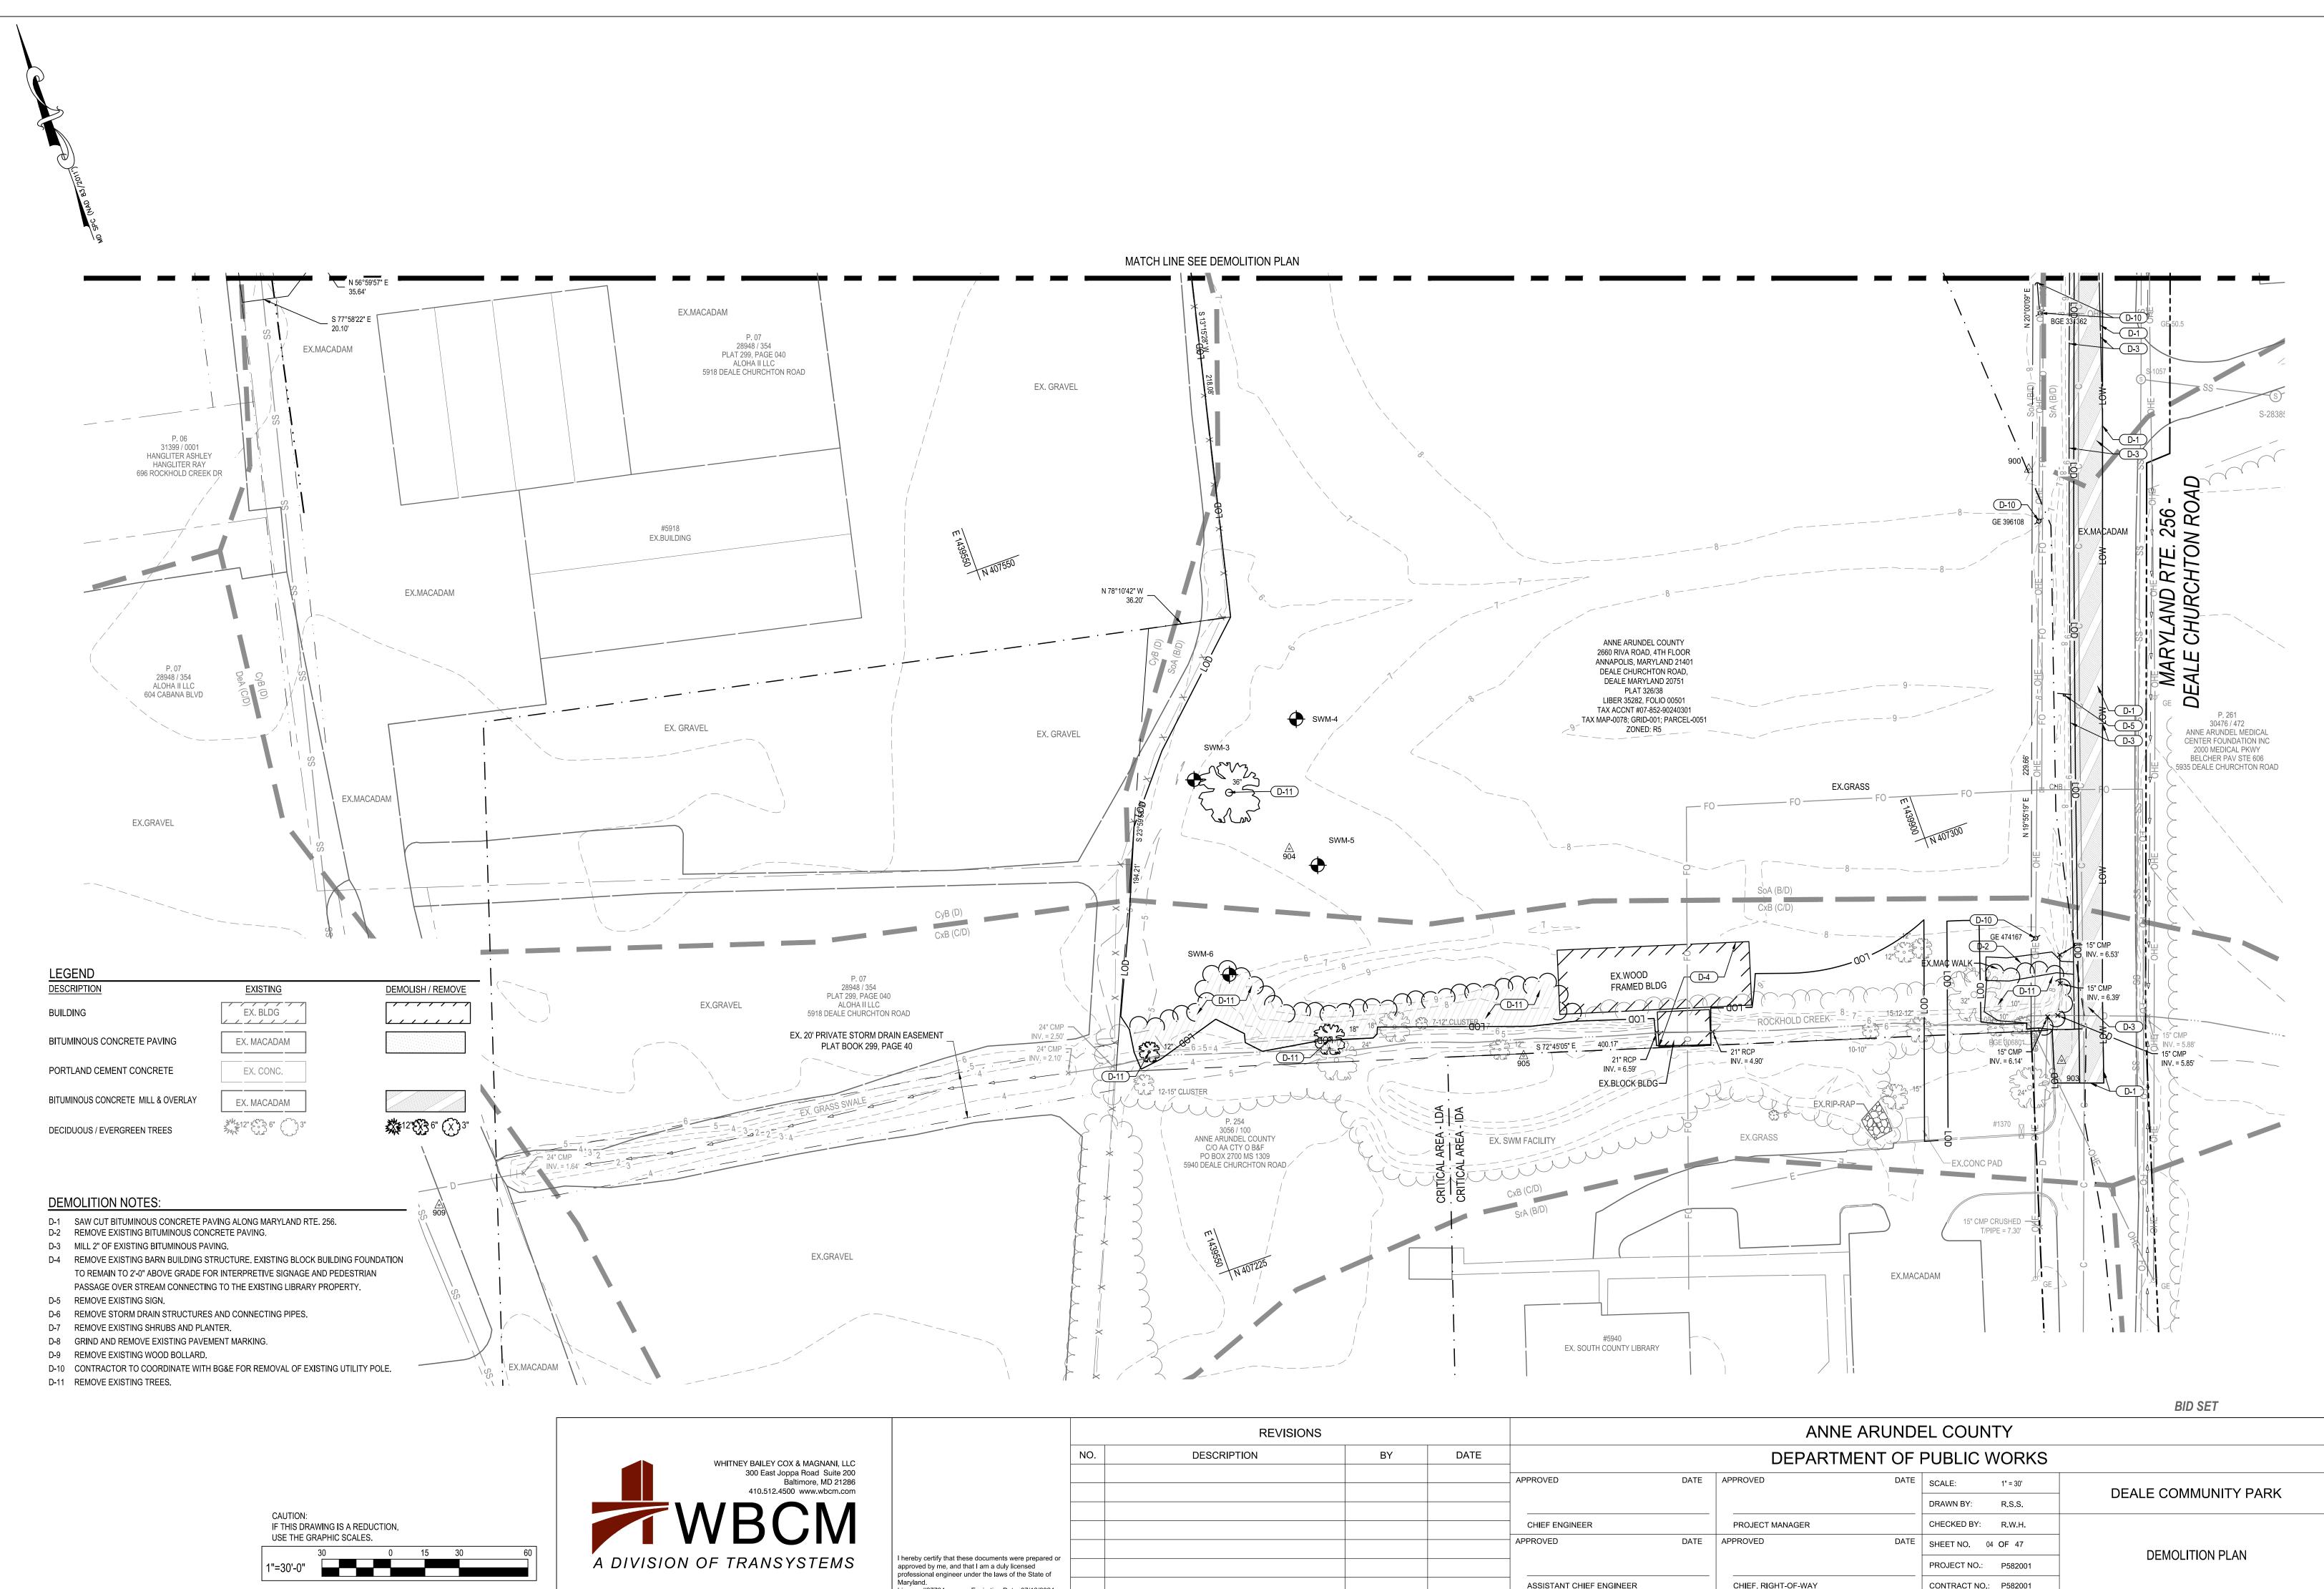	REVISIONS				ANNE ARUNDEL COUNTY				
	NO. DESCRIPTION BY DATE			DATE	DEPARTMENT OF PUBLIC			3LIC WORKS	
					APPROVED DAT	E APPROVED [DATE SCALE: 1" = 30'		
					_		DRAWN BY: R.S.S.	DEALE COMMUNITY PA	
					CHIEF ENGINEER	PROJECT MANAGER	CHECKED BY: R.W.H.		
					APPROVED DAT	E APPROVED [DATE SHEET NO. 04 OF 47	DEMOLITION PLAN	
ents were prepared or duly licensed laws of the State of							PROJECT NO.: P582001		
on Date: 07/12/2024					ASSISTANT CHIEF ENGINEER	CHIEF, RIGHT-OF-WAY	CONTRACT NO.: P582001		


License #27734 Expiration Da

#675 EX. DWELLING #673 EX. DWELLING #671 EX. DWELLING #669 EX. DWELLING #667 EX. DWELLING #5949 EX. DWELLING 206.73 5.88°15'41"E -#5951 EX. DWELLING S 18°56'45" W (N 78°37'59" W 19.88' 603 37.25' \Box N 11°56'35" E m 22.39' N 11°56'35" E 605 22.01' S 71°10'44" E 50.00' 22.01' N 11°03'39" E - 57.14' #5916 EX. DWELLIN X____X N 56°59'57" E 35.64' S 77°58'22" E 20.10' S EX.MACADAM EX.MADAM EX.GRAVEL #604 (, BUILDING 🔪 S-10695 🗳 EX.MACADAM A DIVISION OF TRANSYSTEMS

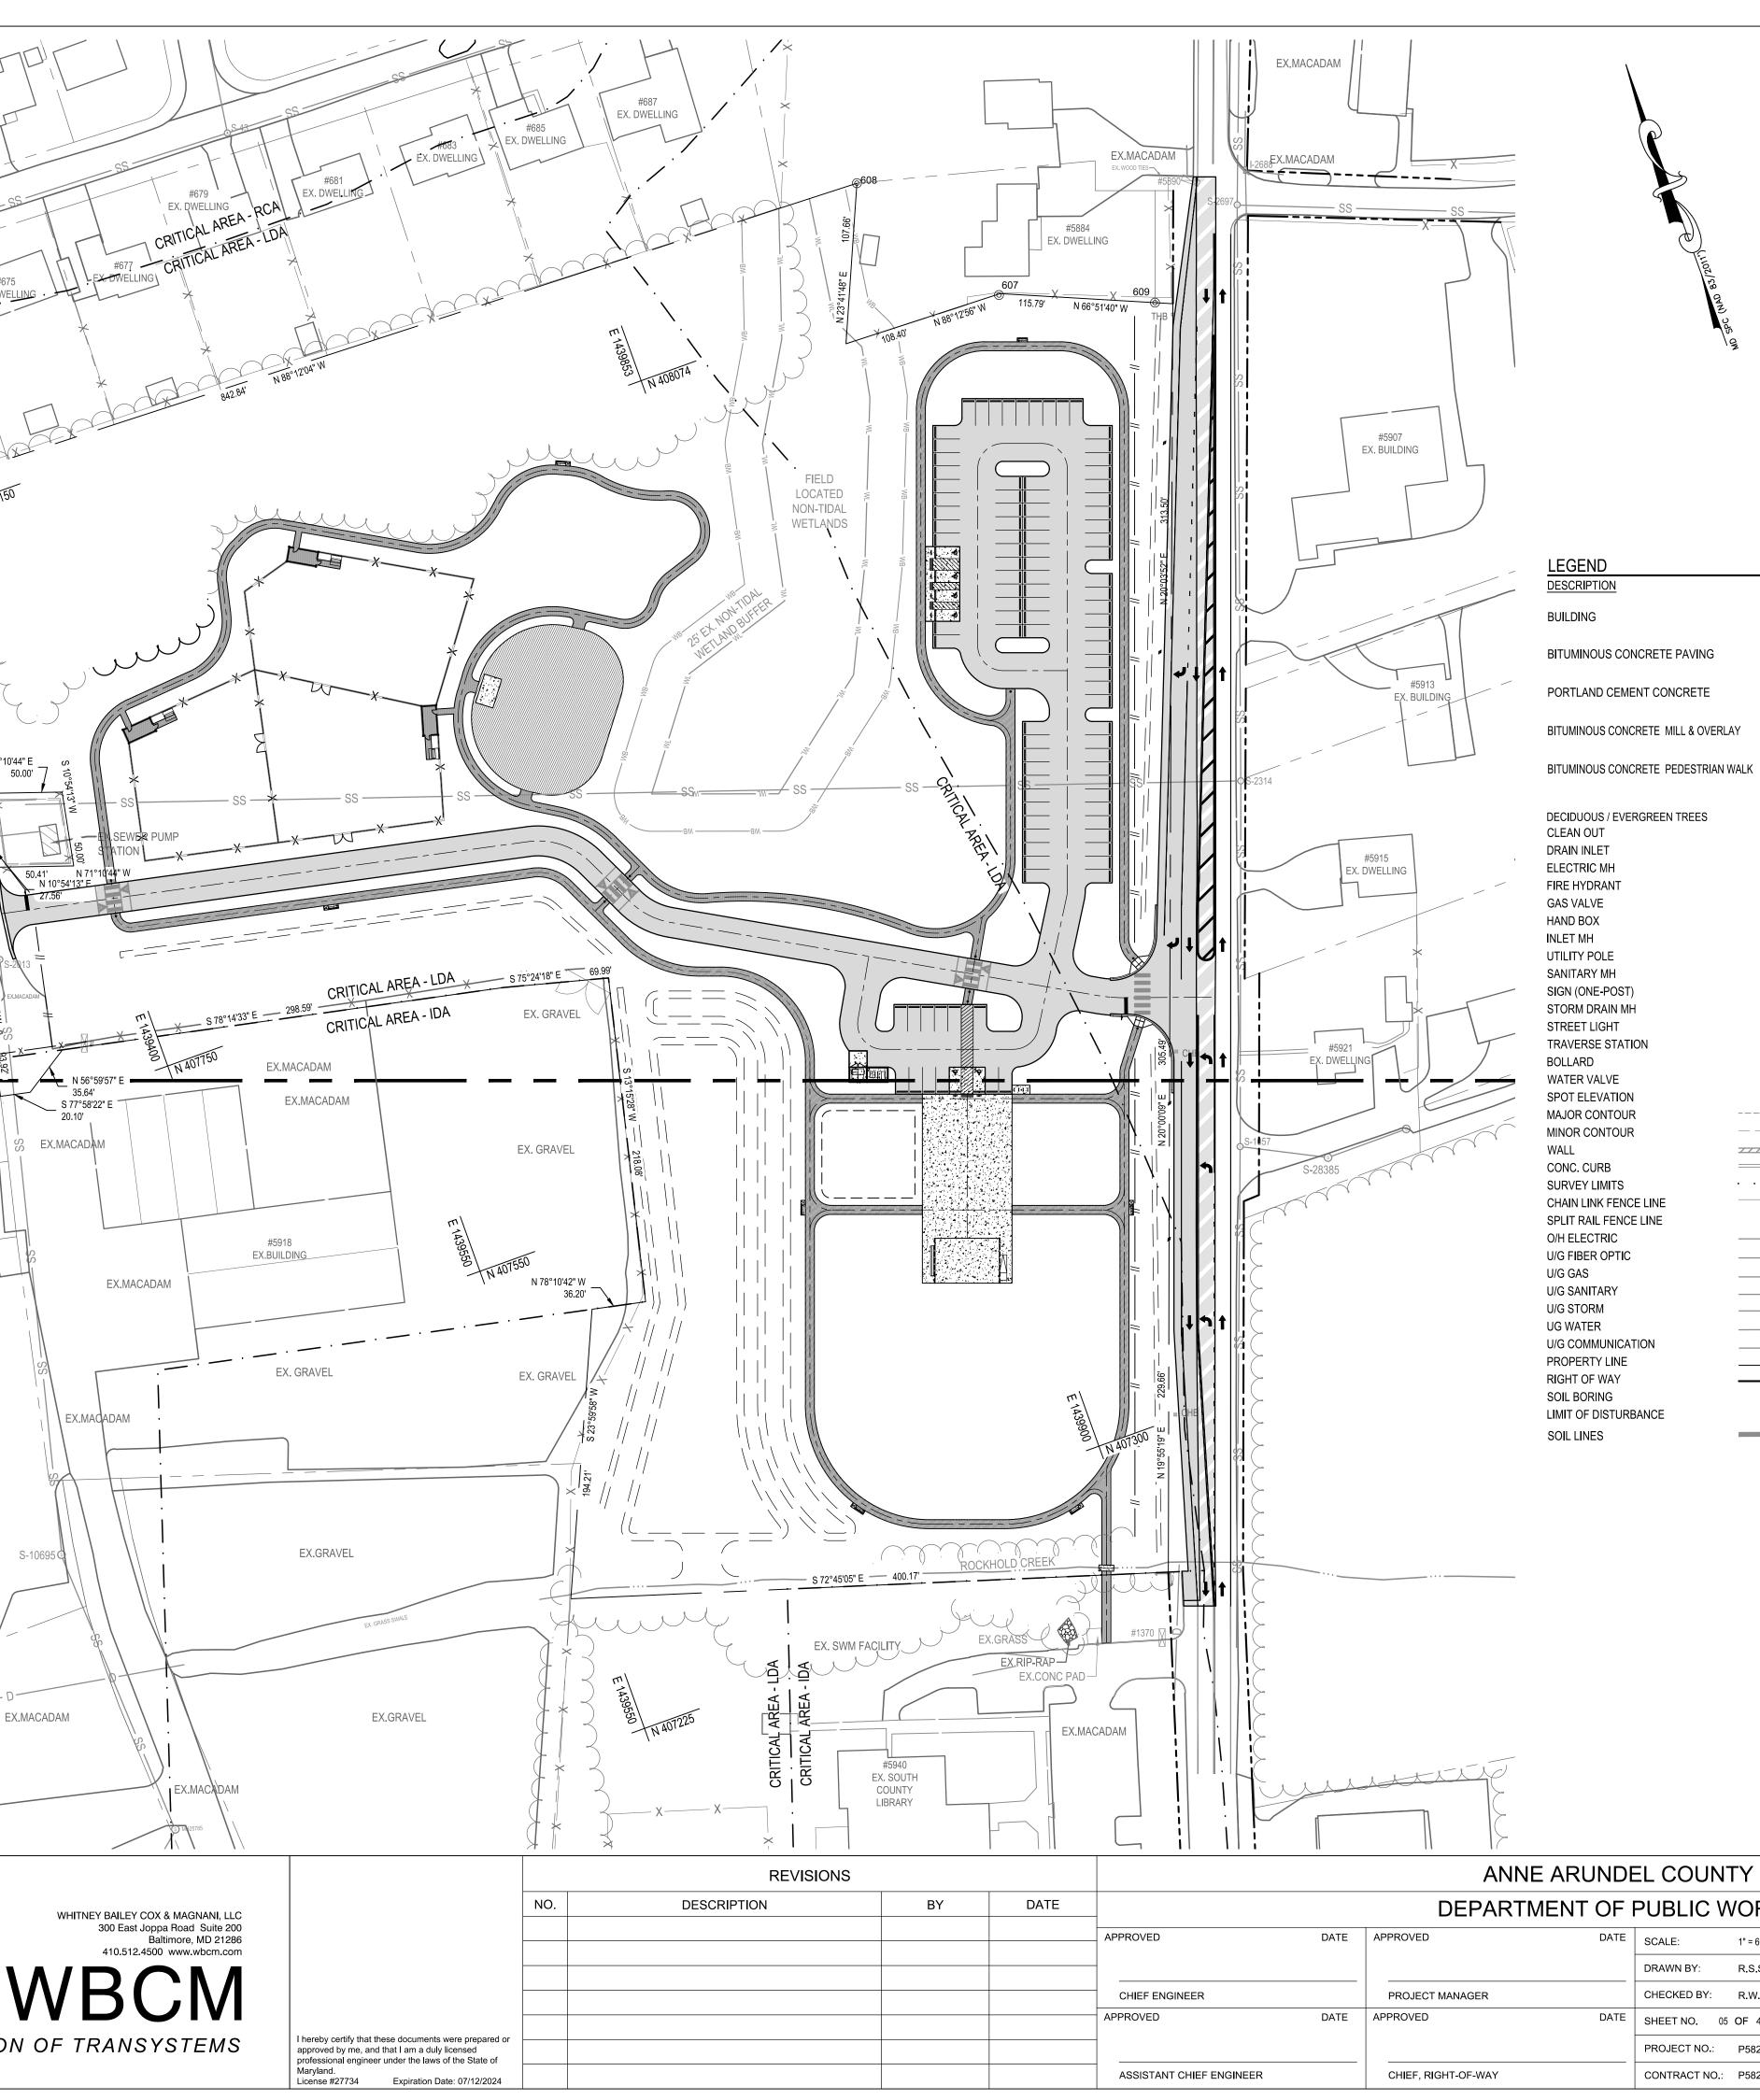



BUILDING	
BITUMINOUS CONCRETE PAVING	
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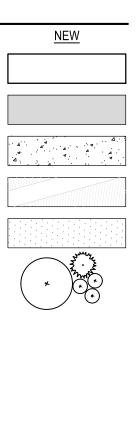


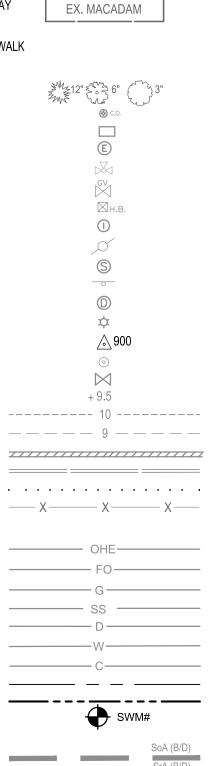
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EX. BLDG

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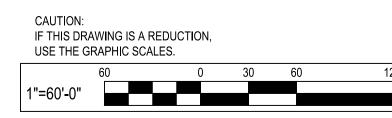
_____ EX. MACADAM _____






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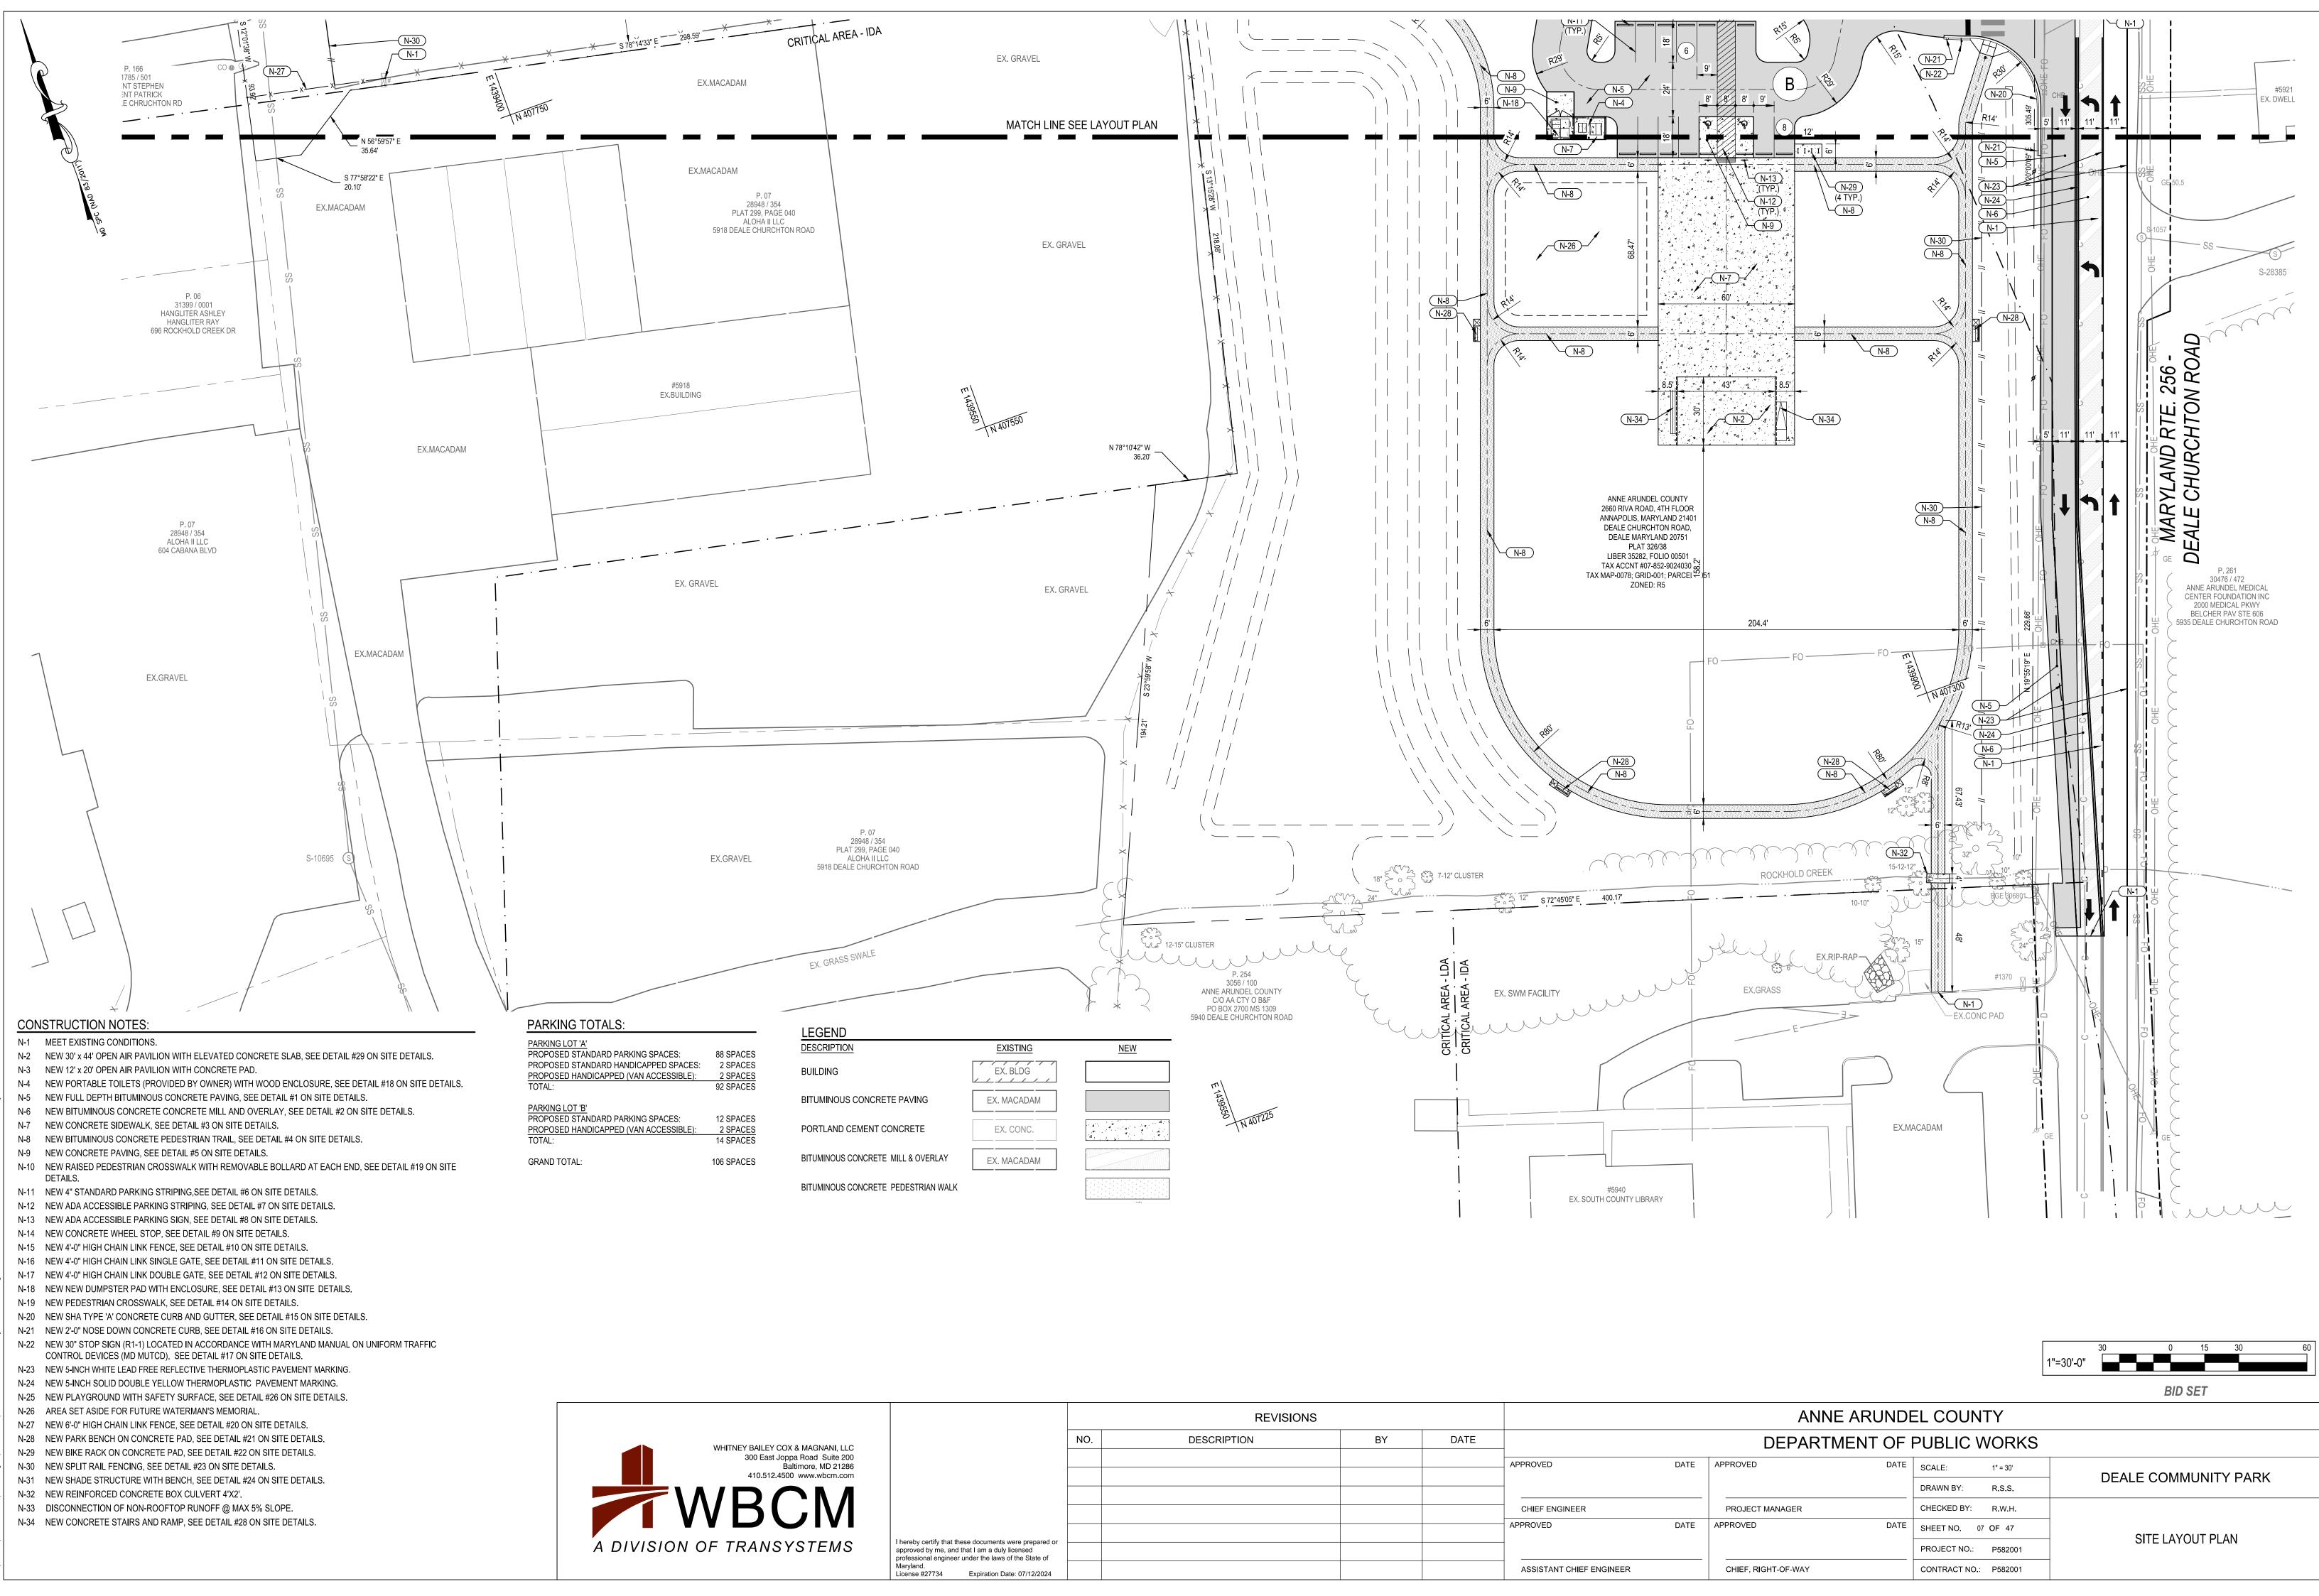

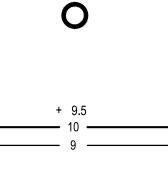
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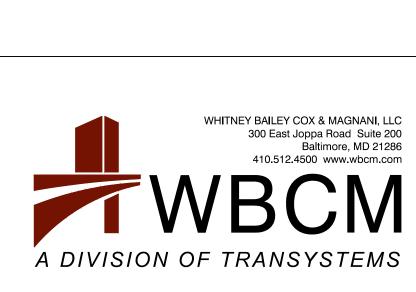
DEPARTMENT OF PUBLIC WORKS						
DATE	APPROVED DATE	SCALE: 1" = 60'	DEALE COMMUNITY PARK			
		DRAWN BY: R.S.S.	DEALE COMMUNITY FARK			
	PROJECT MANAGER	CHECKED BY: R.W.H.				
DATE	APPROVED DATE	SHEET NO. 05 OF 47	OVERALL SITE LAYOUT PLAN			
		PROJECT NO.: P582001	OVERALL SITE LAYOUT PLAN			
IGINEER	CHIEF, RIGHT-OF-WAY	CONTRACT NO.: P582001				





117/17141805\Drawinas\07-Site\17141805-C201-Lavout Plan.dwa Nov 07. 2023 - 10:13am Plot Bv: rsi

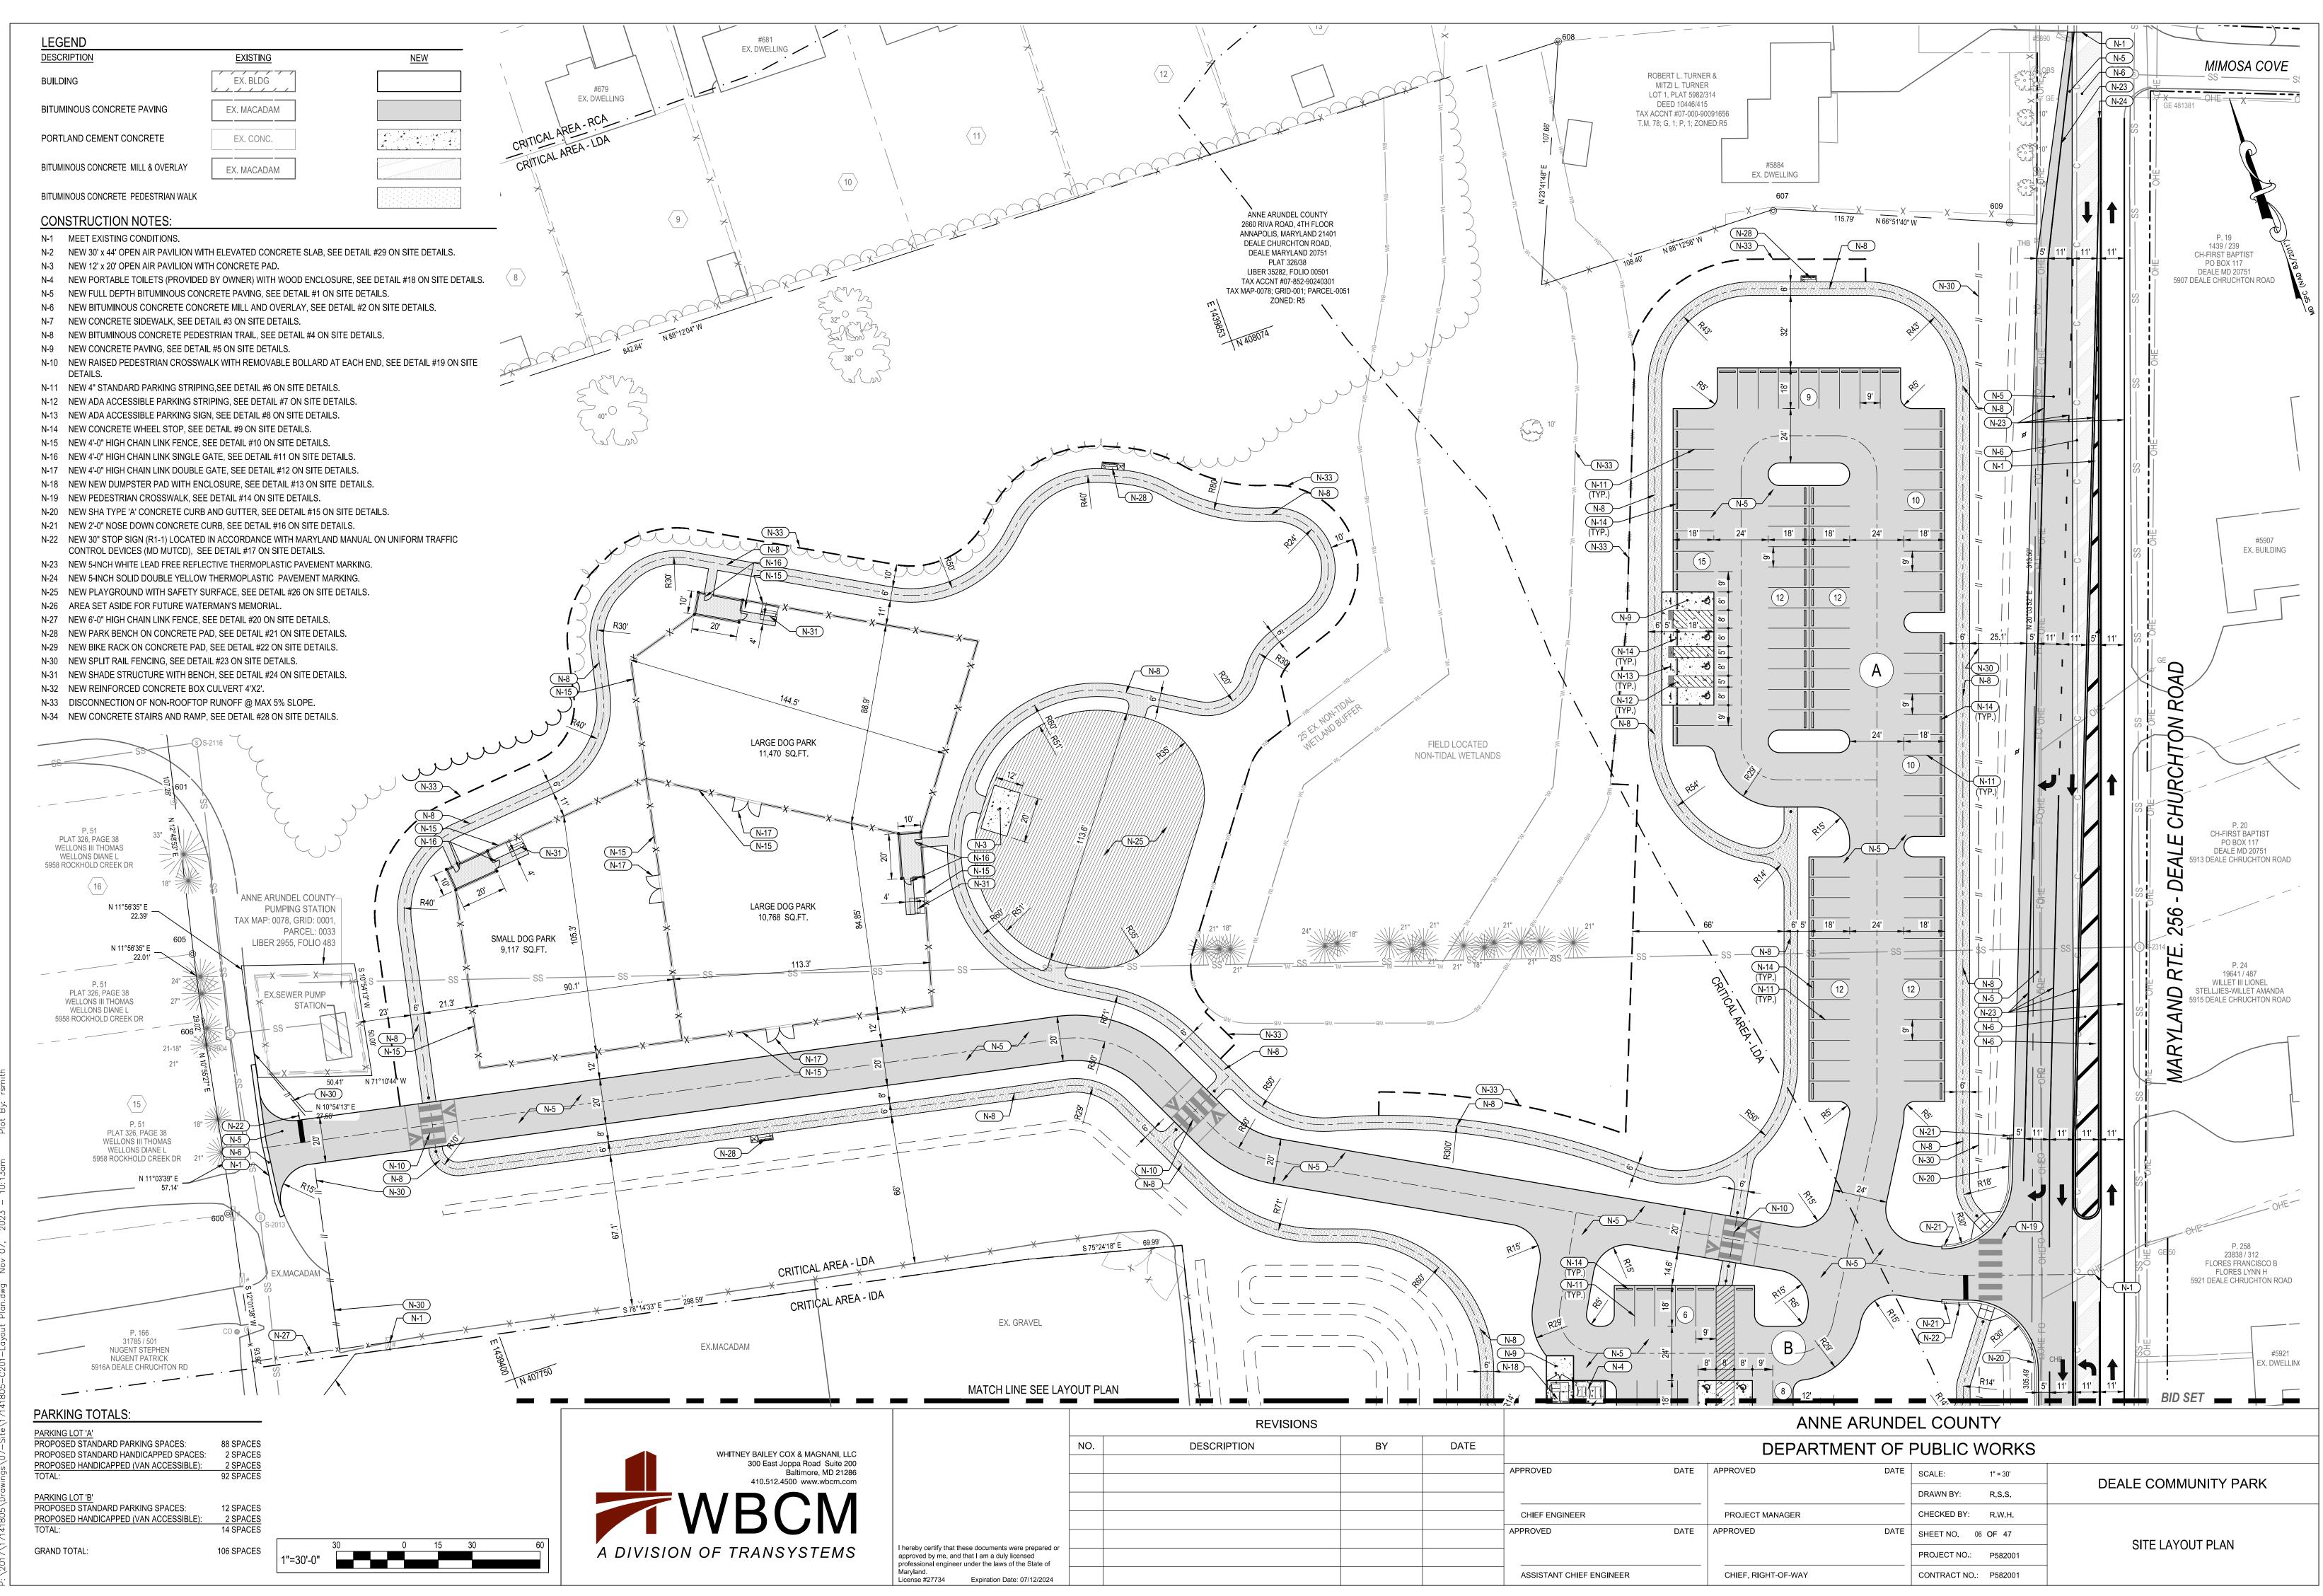

		REVISIONS			
	NO.	DESCRIPTION	BY	DATE	_
					_ APPROVED
					CHIEF ENGINEER
e prepared or used e State of					-
7/12/2024					ASSISTANT CHIEF ENG



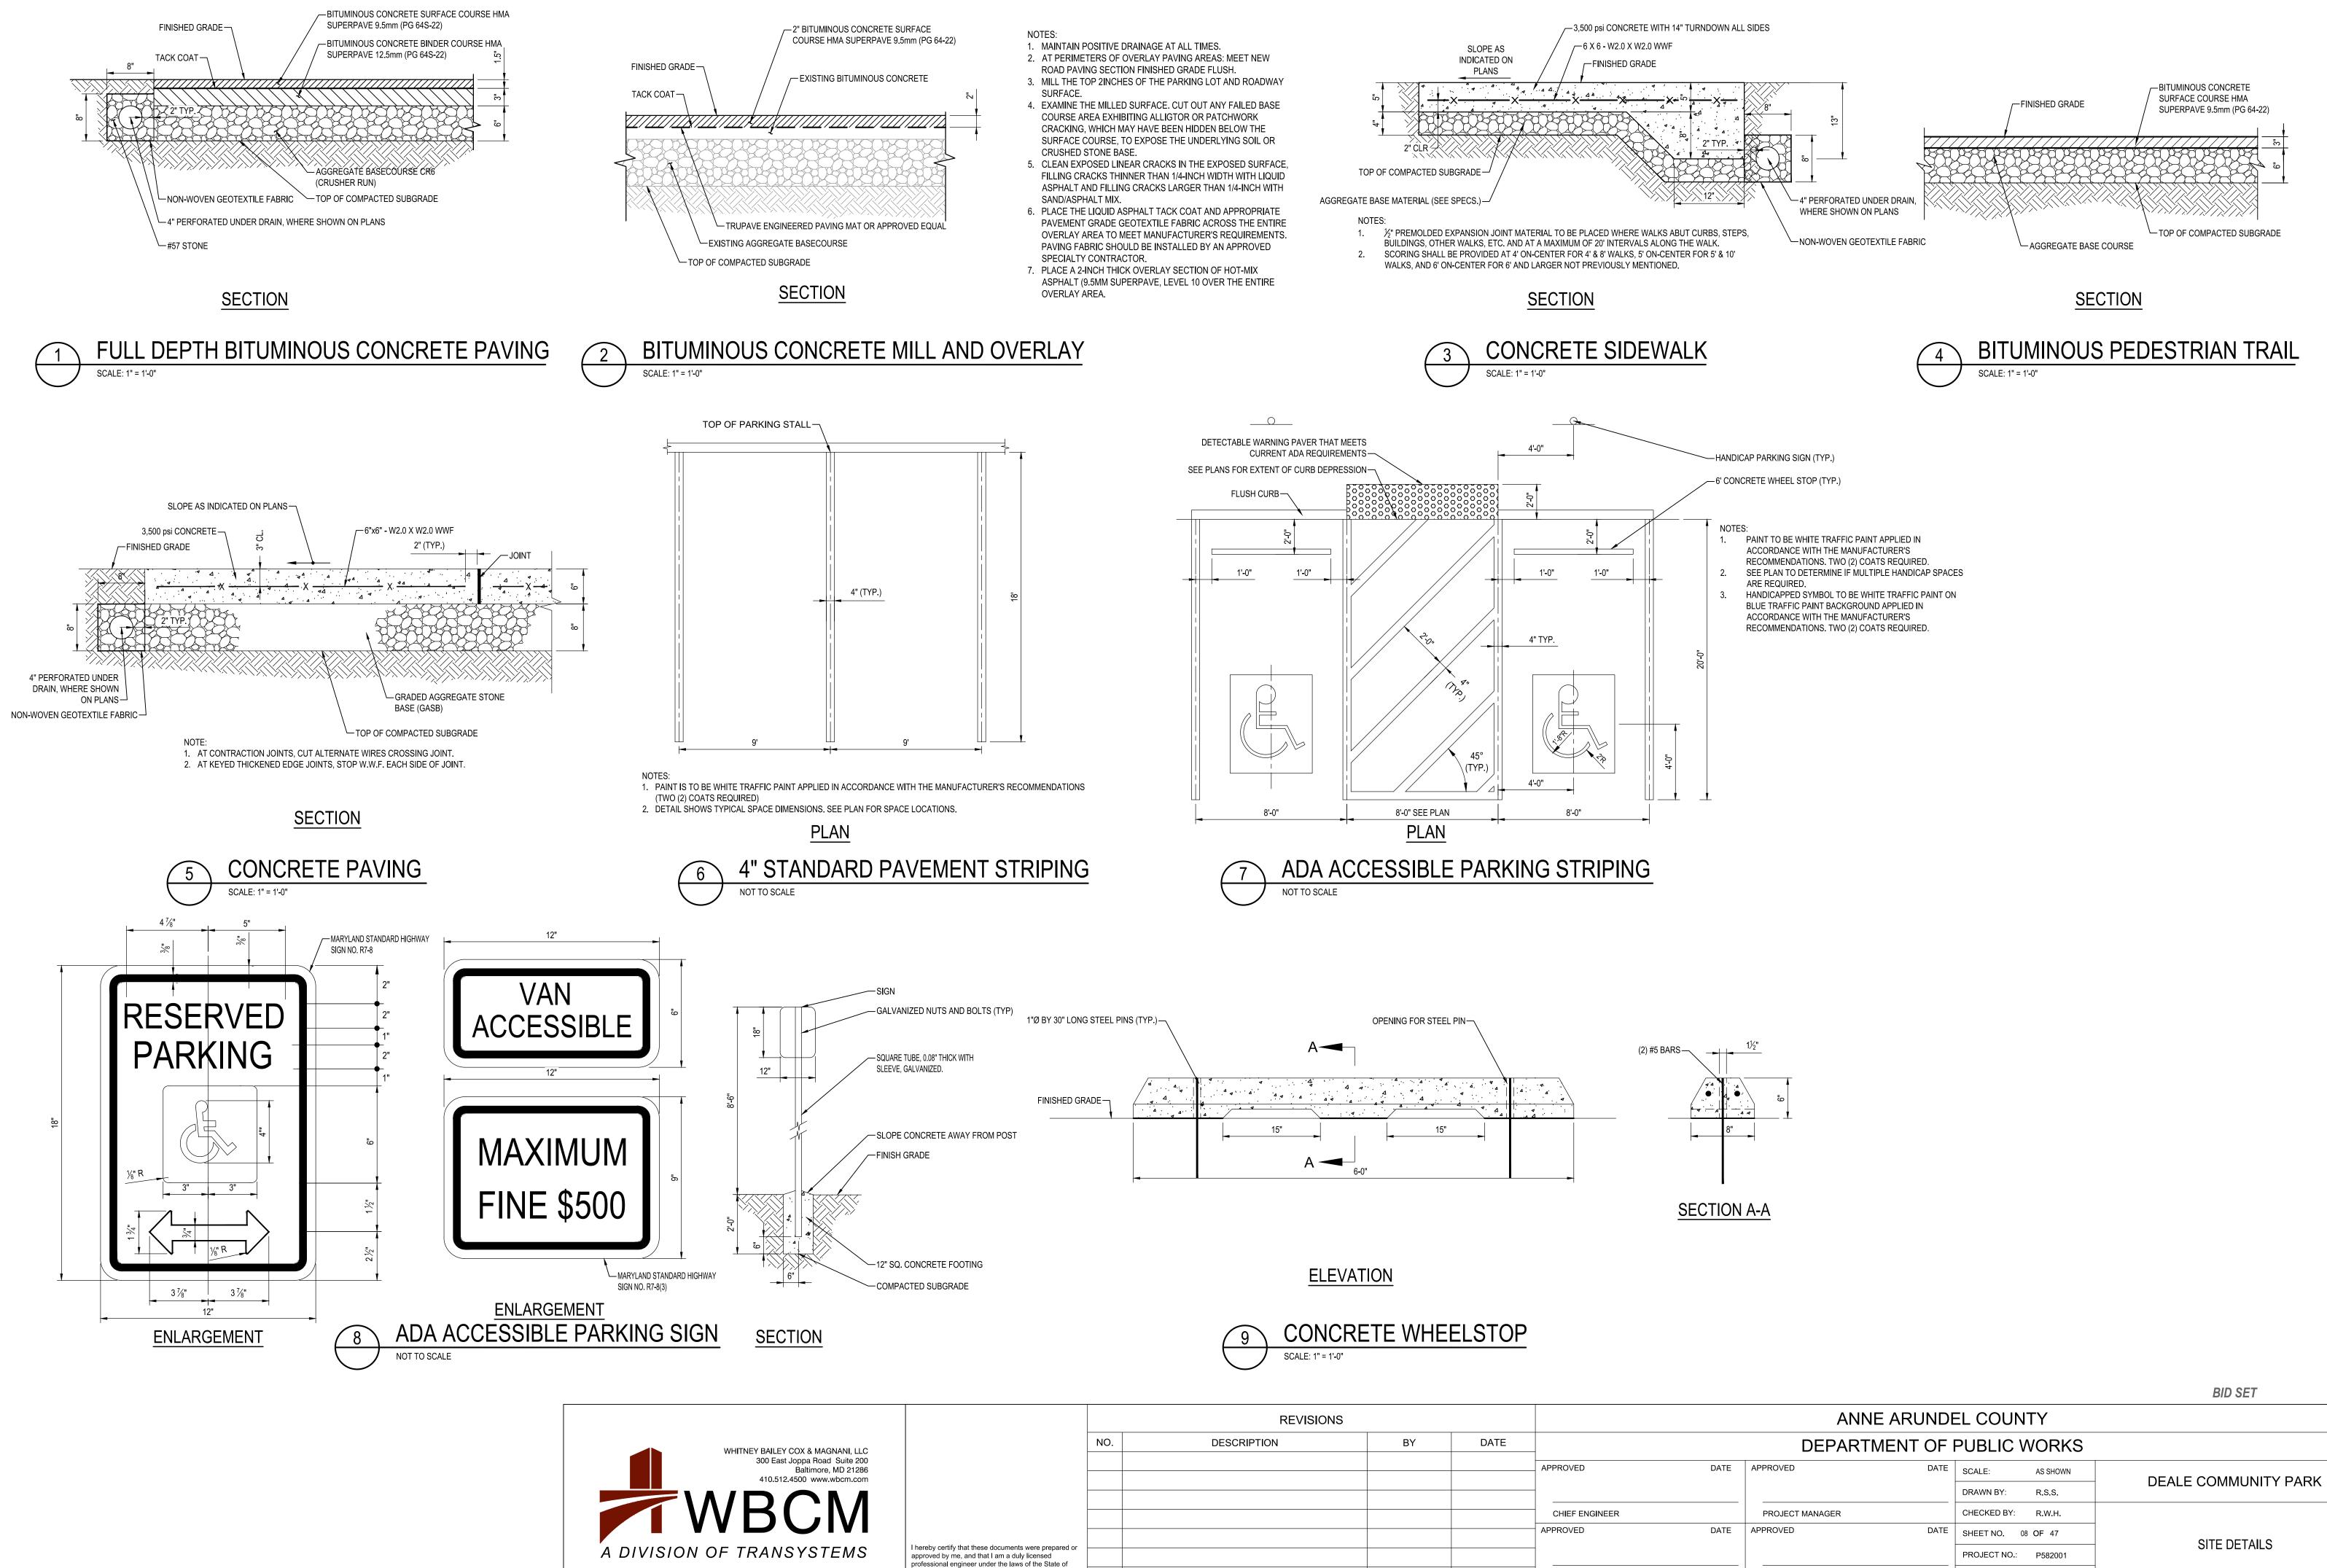


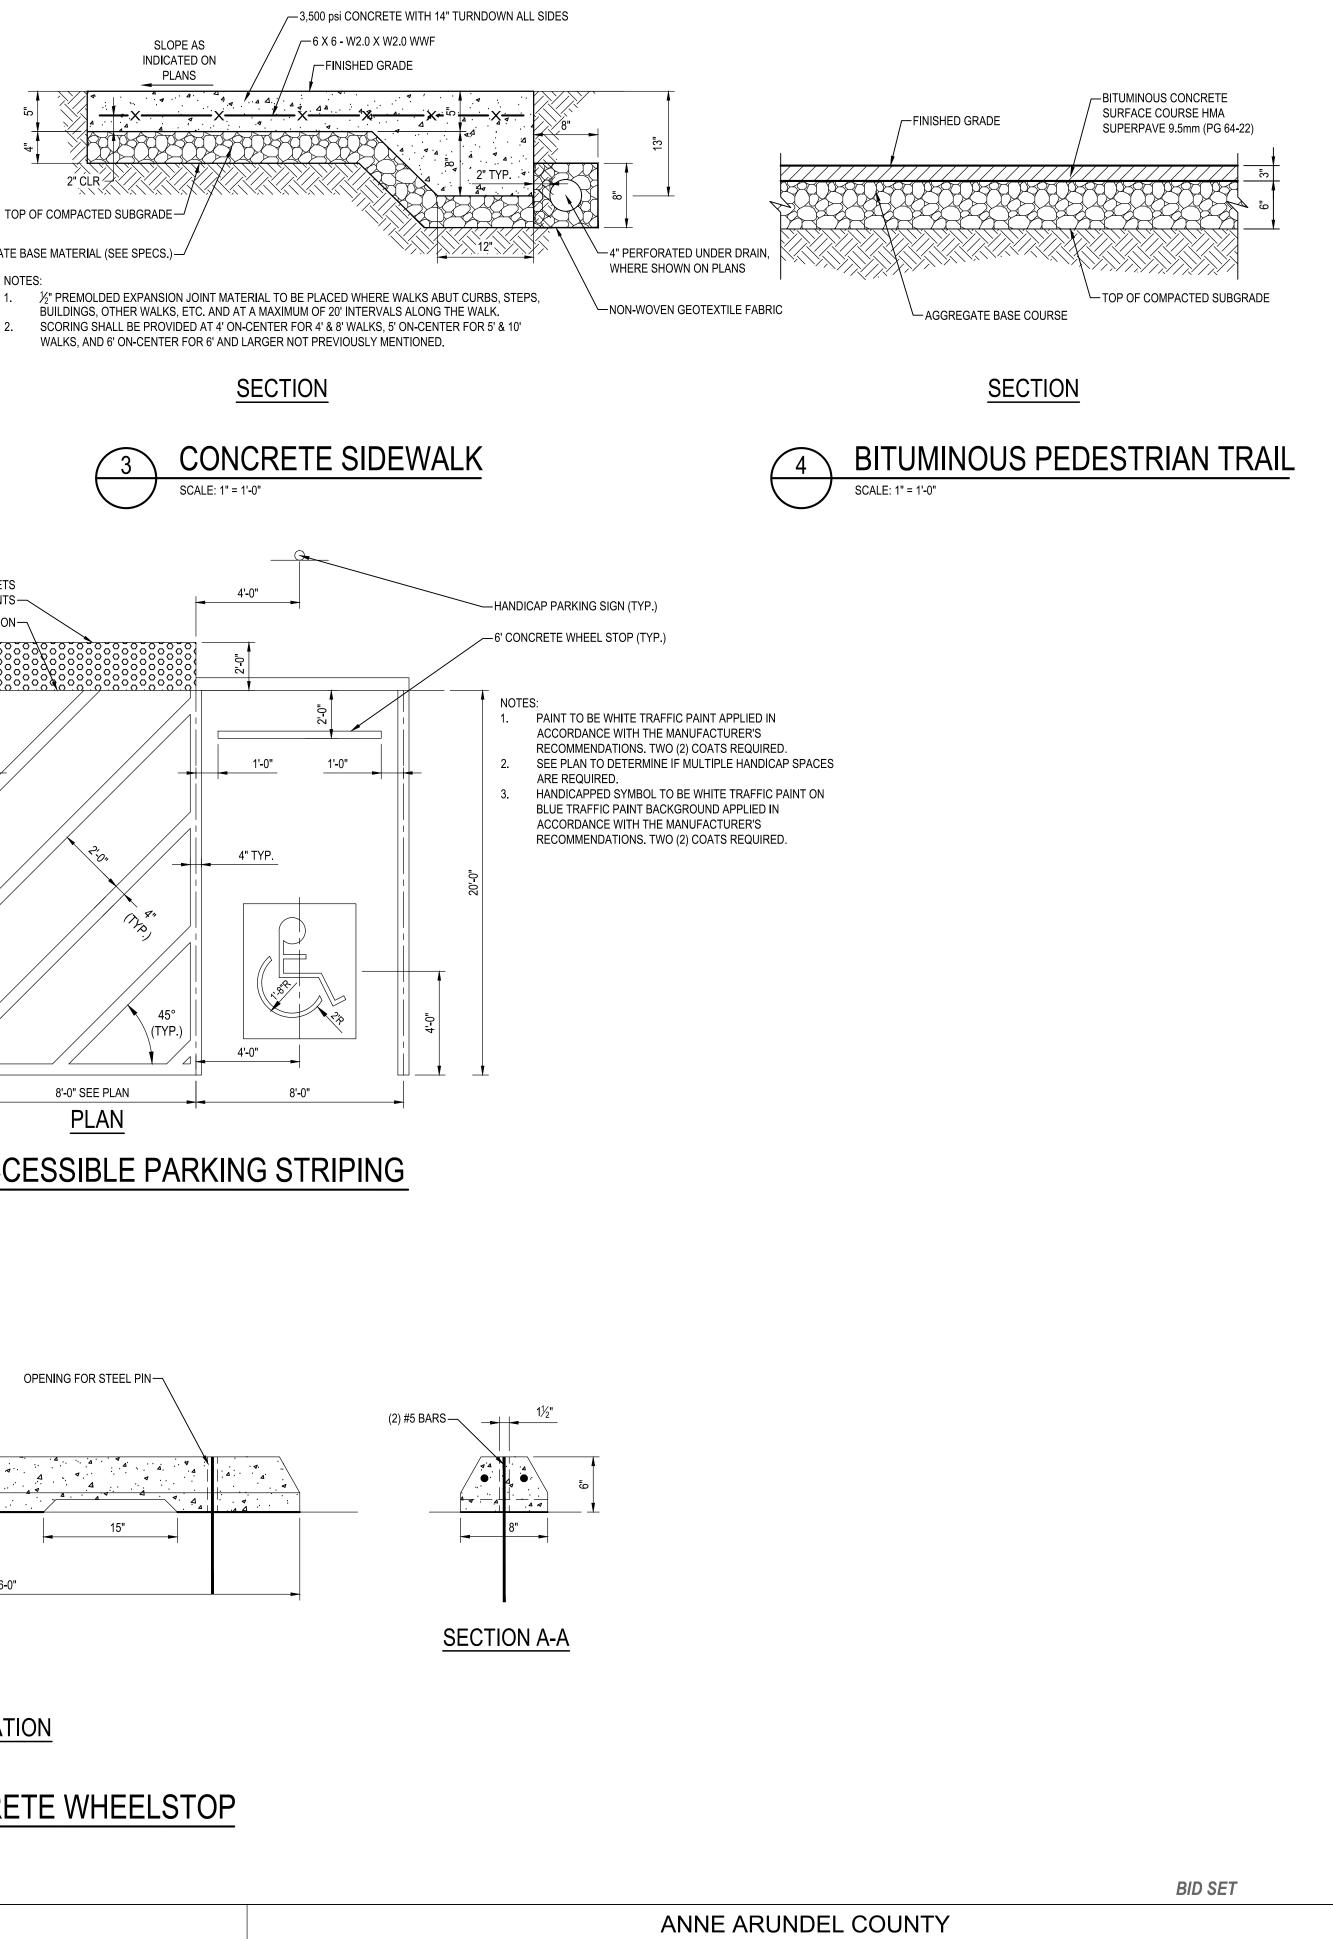


	NO.	DESCRIPTION	BY	DATE	
					CHIEF ENGINEER
					APPROVED
ocuments were prepared or					_
am a duly licensed r the laws of the State of					
piration Date: 07/12/2024					ASSISTANT CHIEF ENGINE

professional engineer under . Maryland License #27734

DEPARTMENT OF PUBLIC WORKS						
DATE	APPROVED DATE	SCALE: AS SHOWN	DEALE COMMUNITY PARK			
		DRAWN BY: R.S.S.	DEALE COMMUNITY PARK			
	PROJECT MANAGER	CHECKED BY: R.W.H.				
DATE	APPROVED DATE	SHEET NO. 08 OF 47	SITE DETAILS			
		PROJECT NO.: P582001	SITE DETAILS			
NGINEER	CHIEF, RIGHT-OF-WAY	CONTRACT NO.: P582001				
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DEPARTMENT OF PUBLIC WORKS						
DATE	APPROVED DATE	SCALE: AS SHOWN	DEALE COMMUNITY PARK			
		DRAWN BY: R.S.S.				
	PROJECT MANAGER	CHECKED BY: R.W.H.				
DATE	APPROVED DATE	SHEET NO. 09 OF 47	SITE DETAILS			
		PROJECT NO.: P582001	SITE DETAILS			
NGINEER	CHIEF, RIGHT-OF-WAY	CONTRACT NO.: P582001				

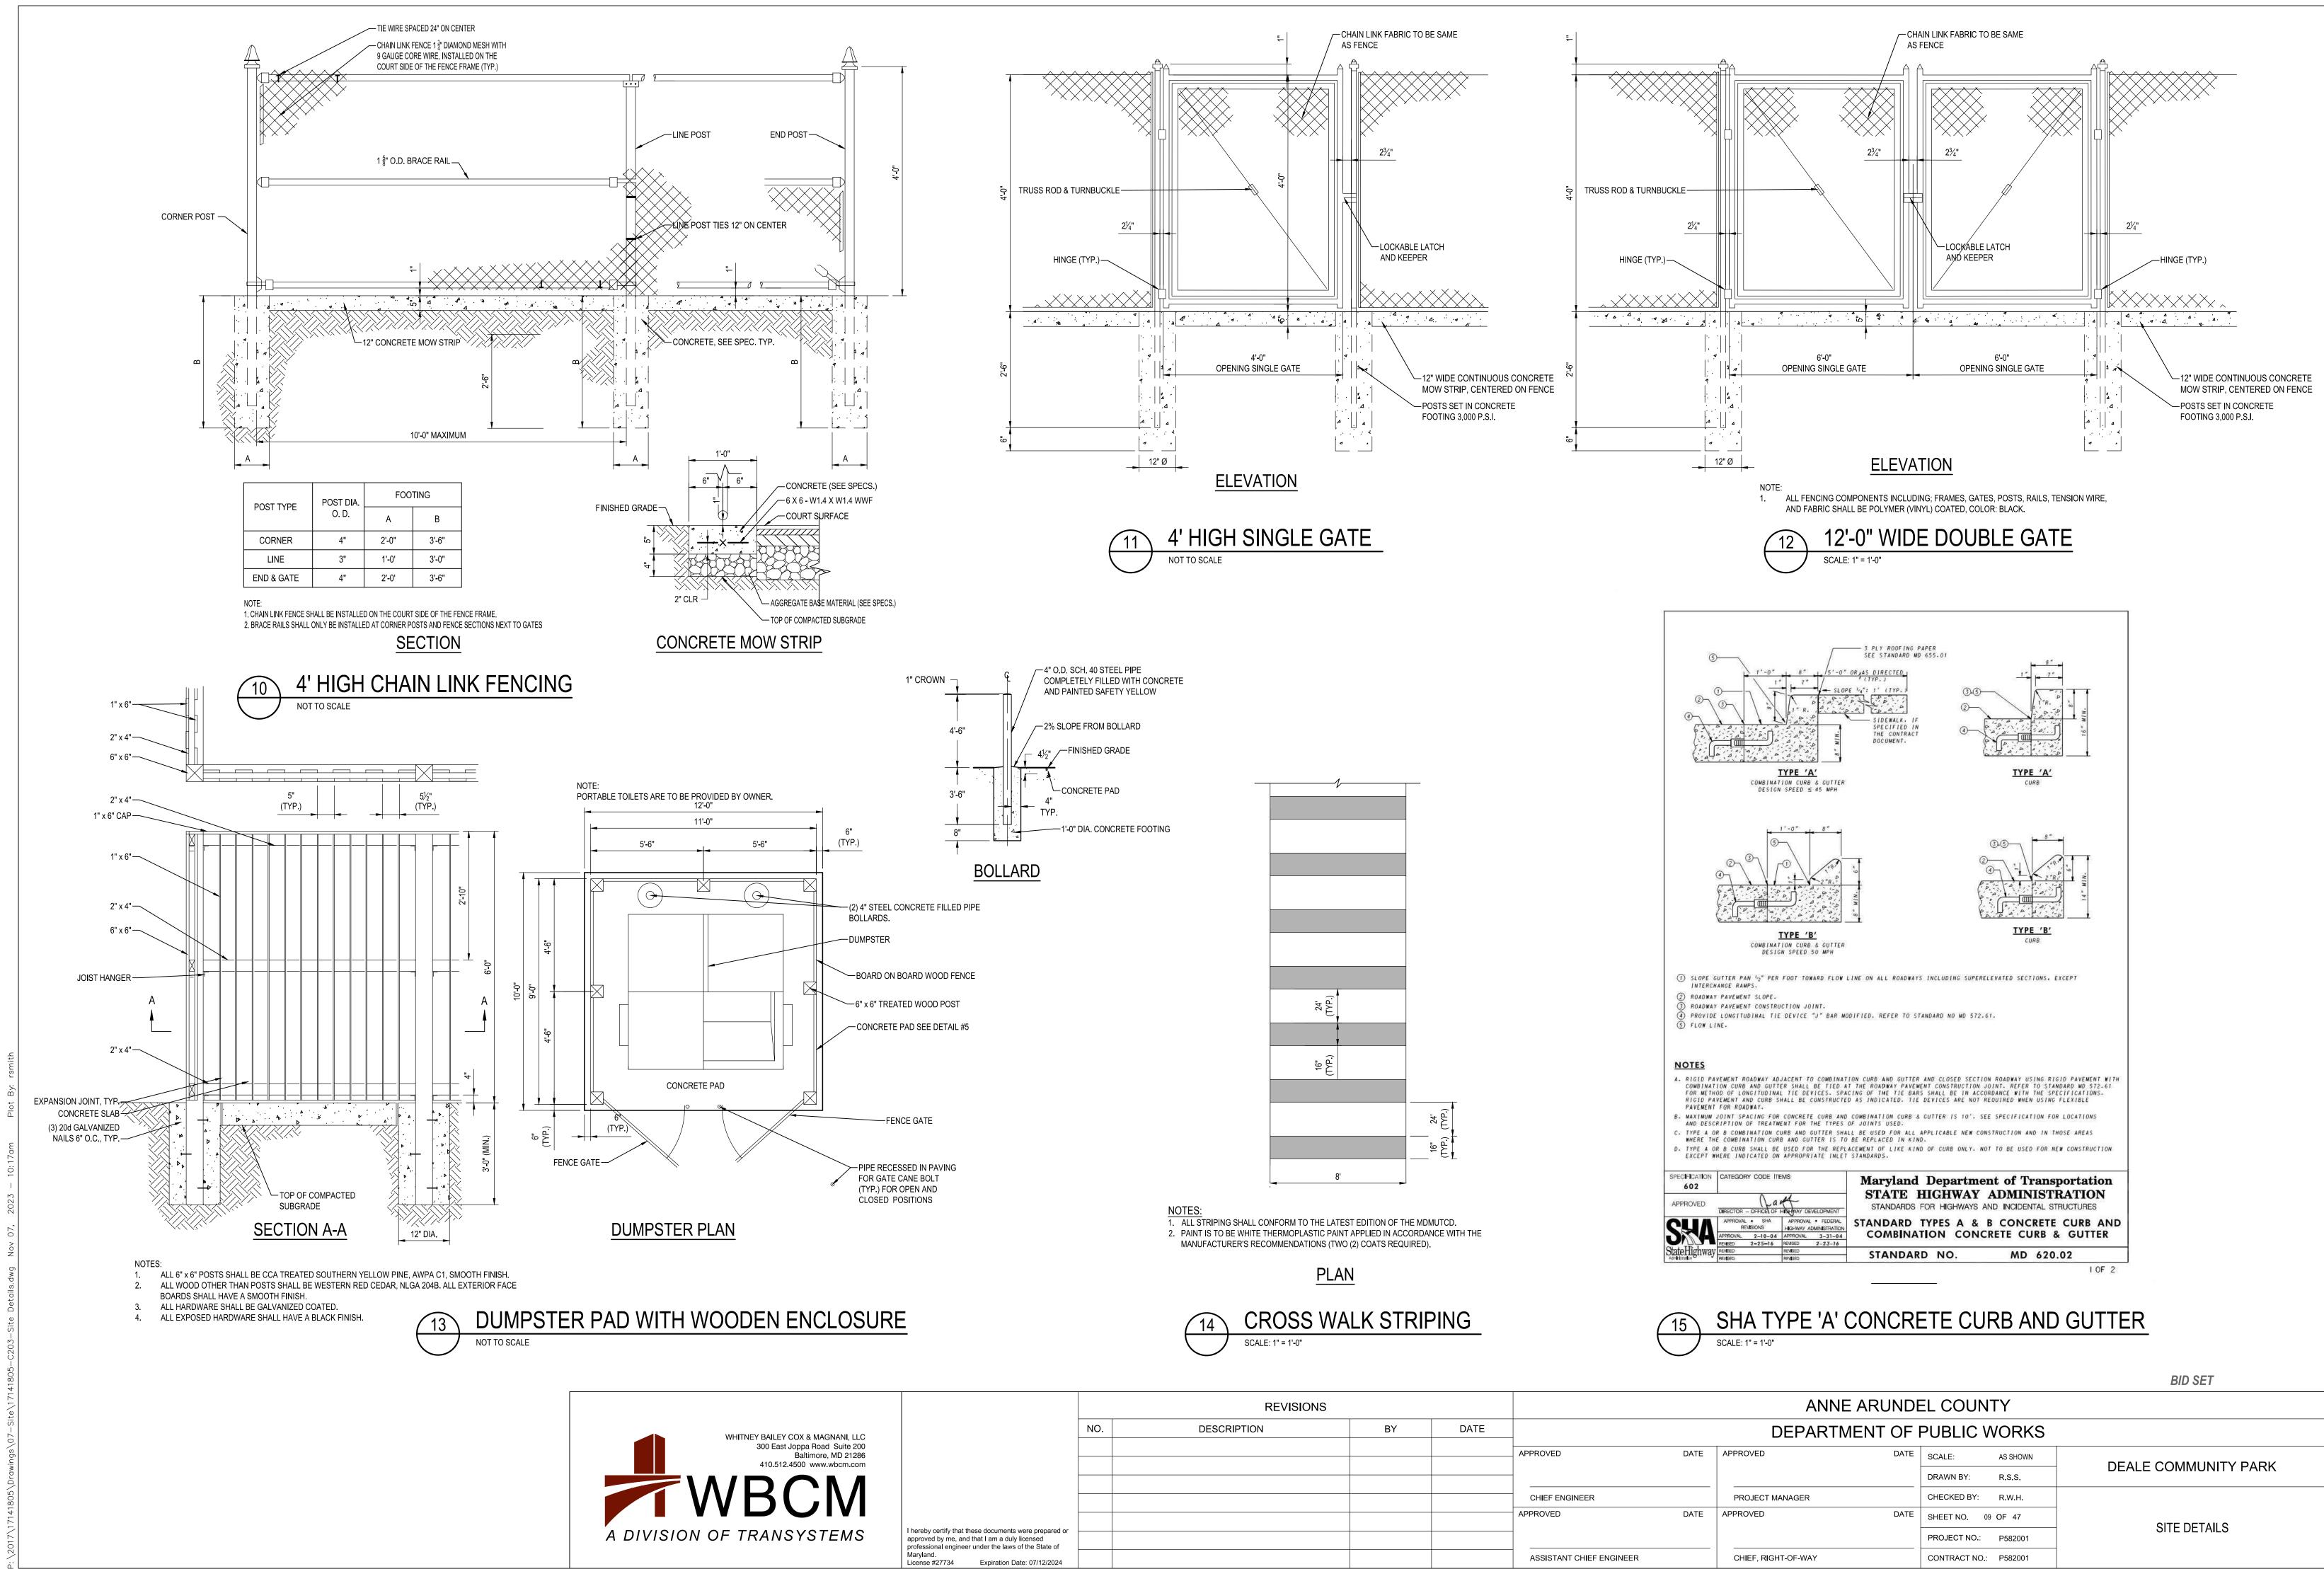


approved by me, and that I am a duly licensed professional engineer under the laws of the State of . Maryland. _icense #27734 Expiration Date: 07/12/2024

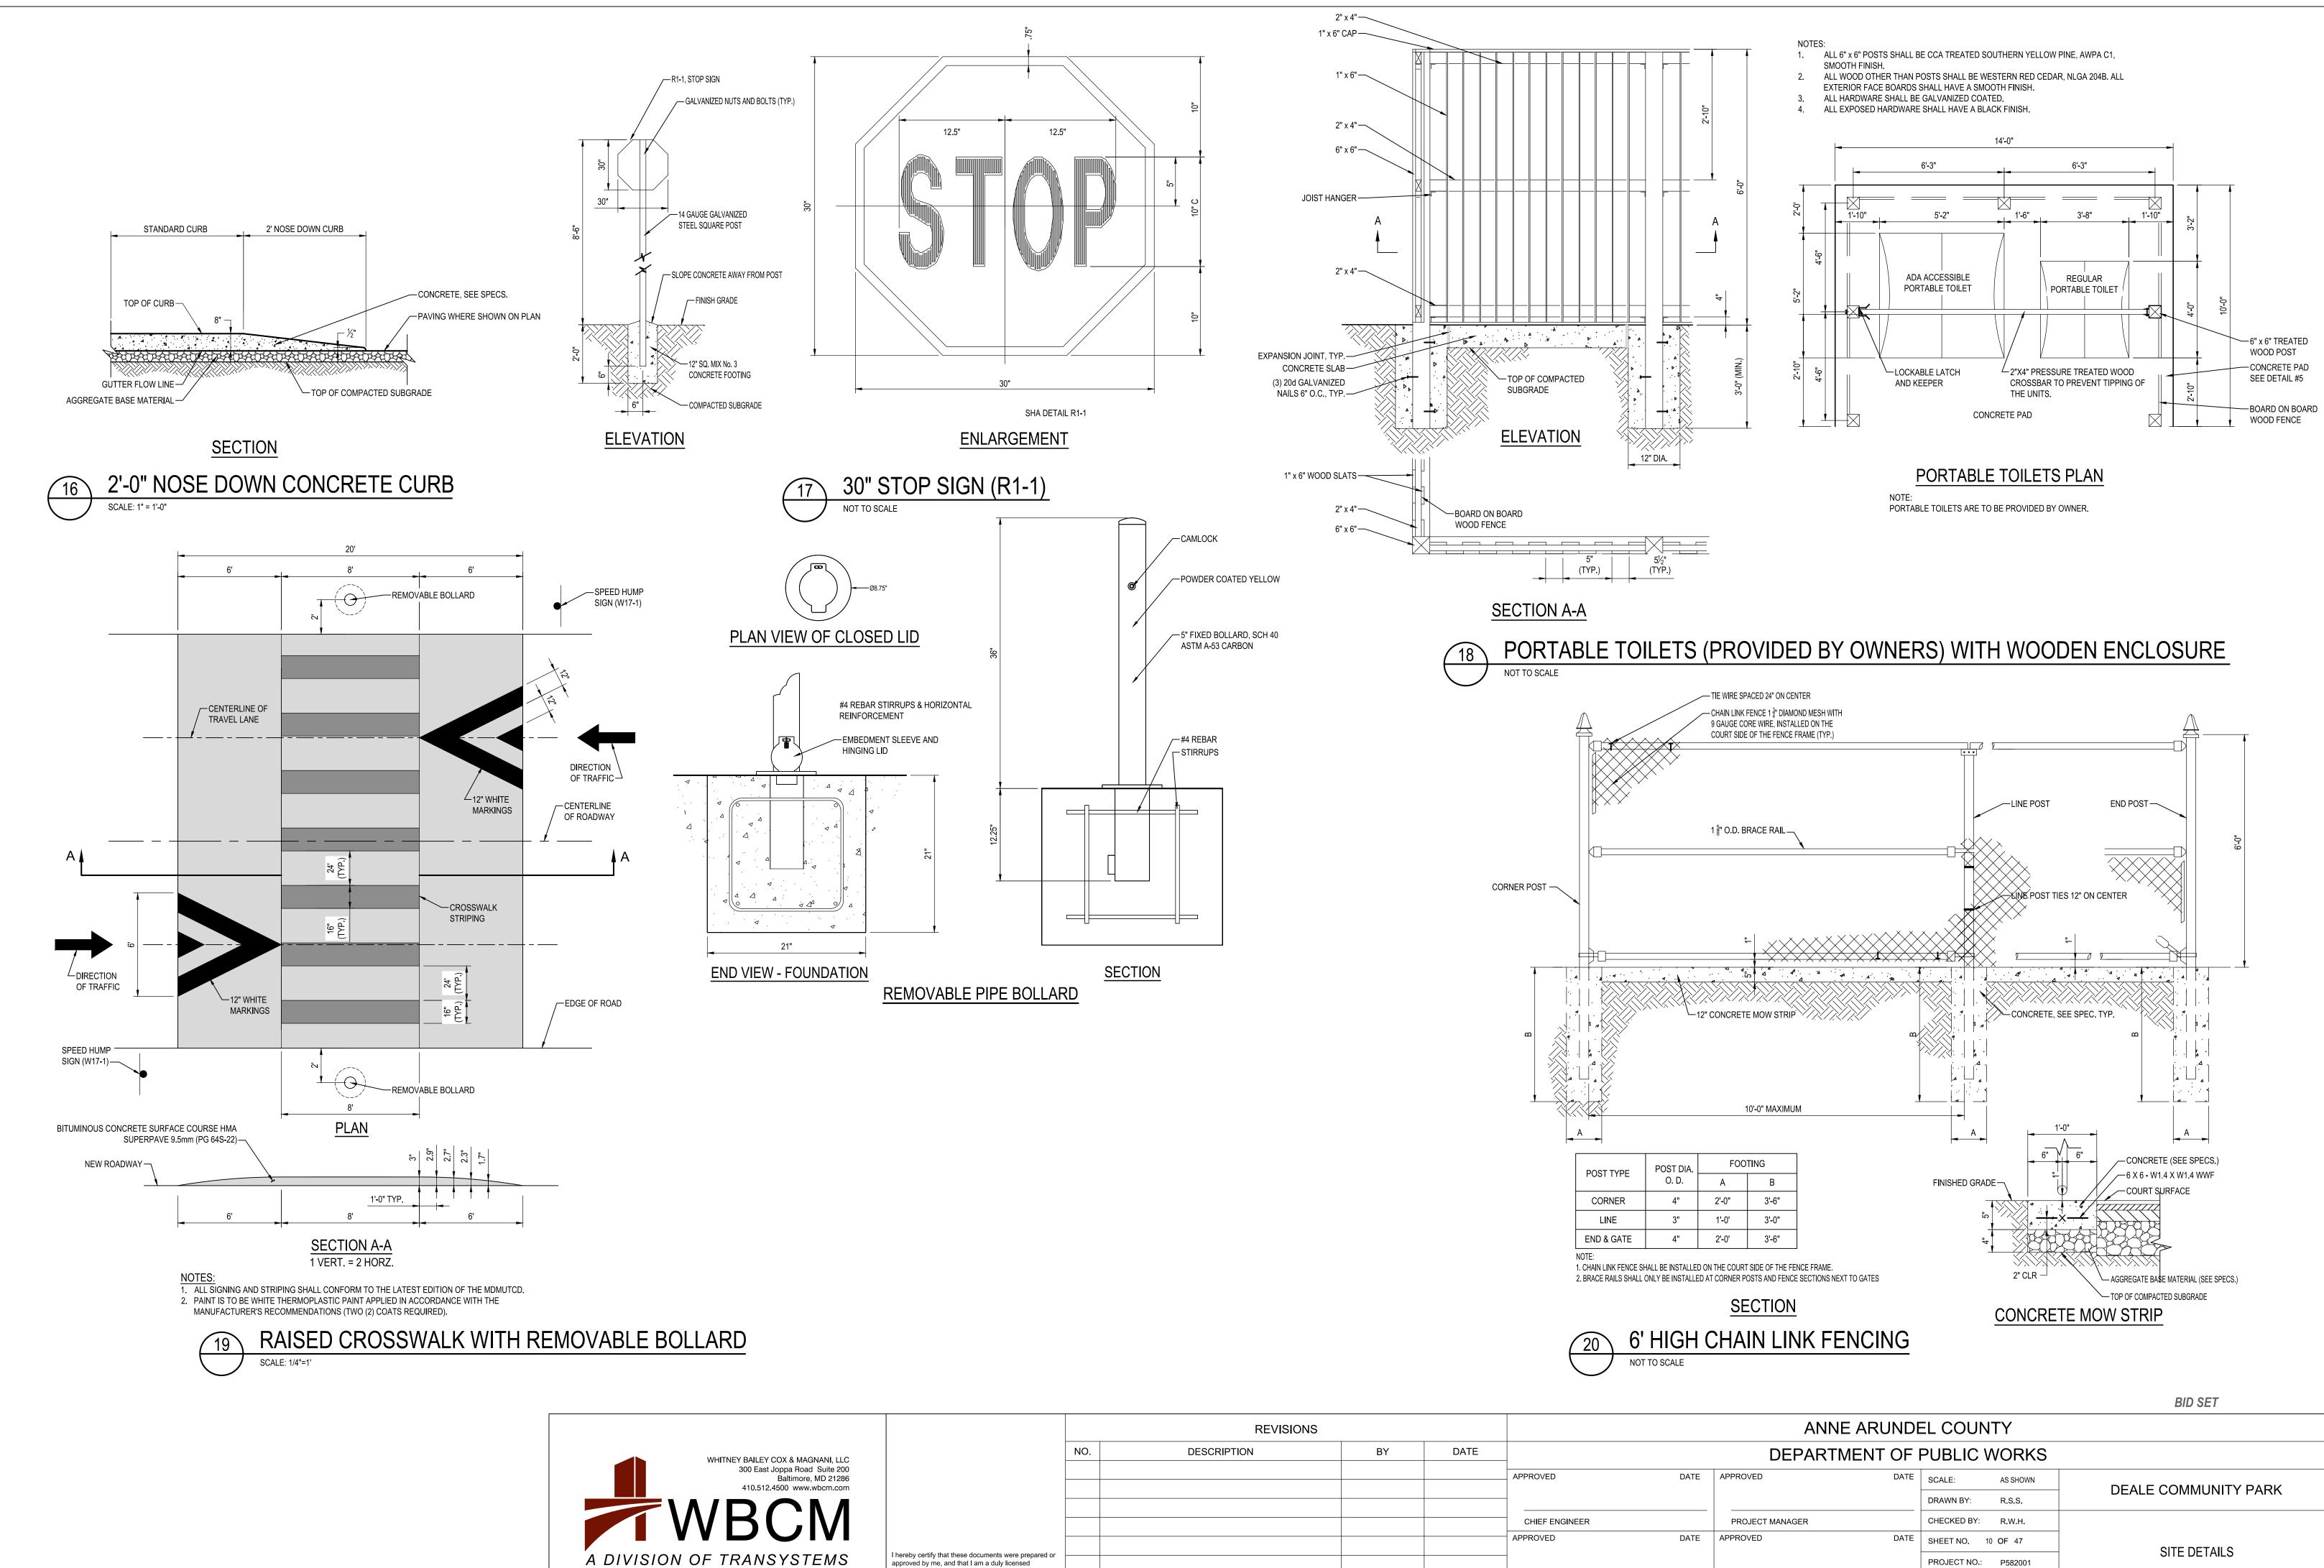
ASSISTANT CHIEF ENGINEER

CHIEF, RIGHT-OF-WAY

CONTRACT NO.: P582001

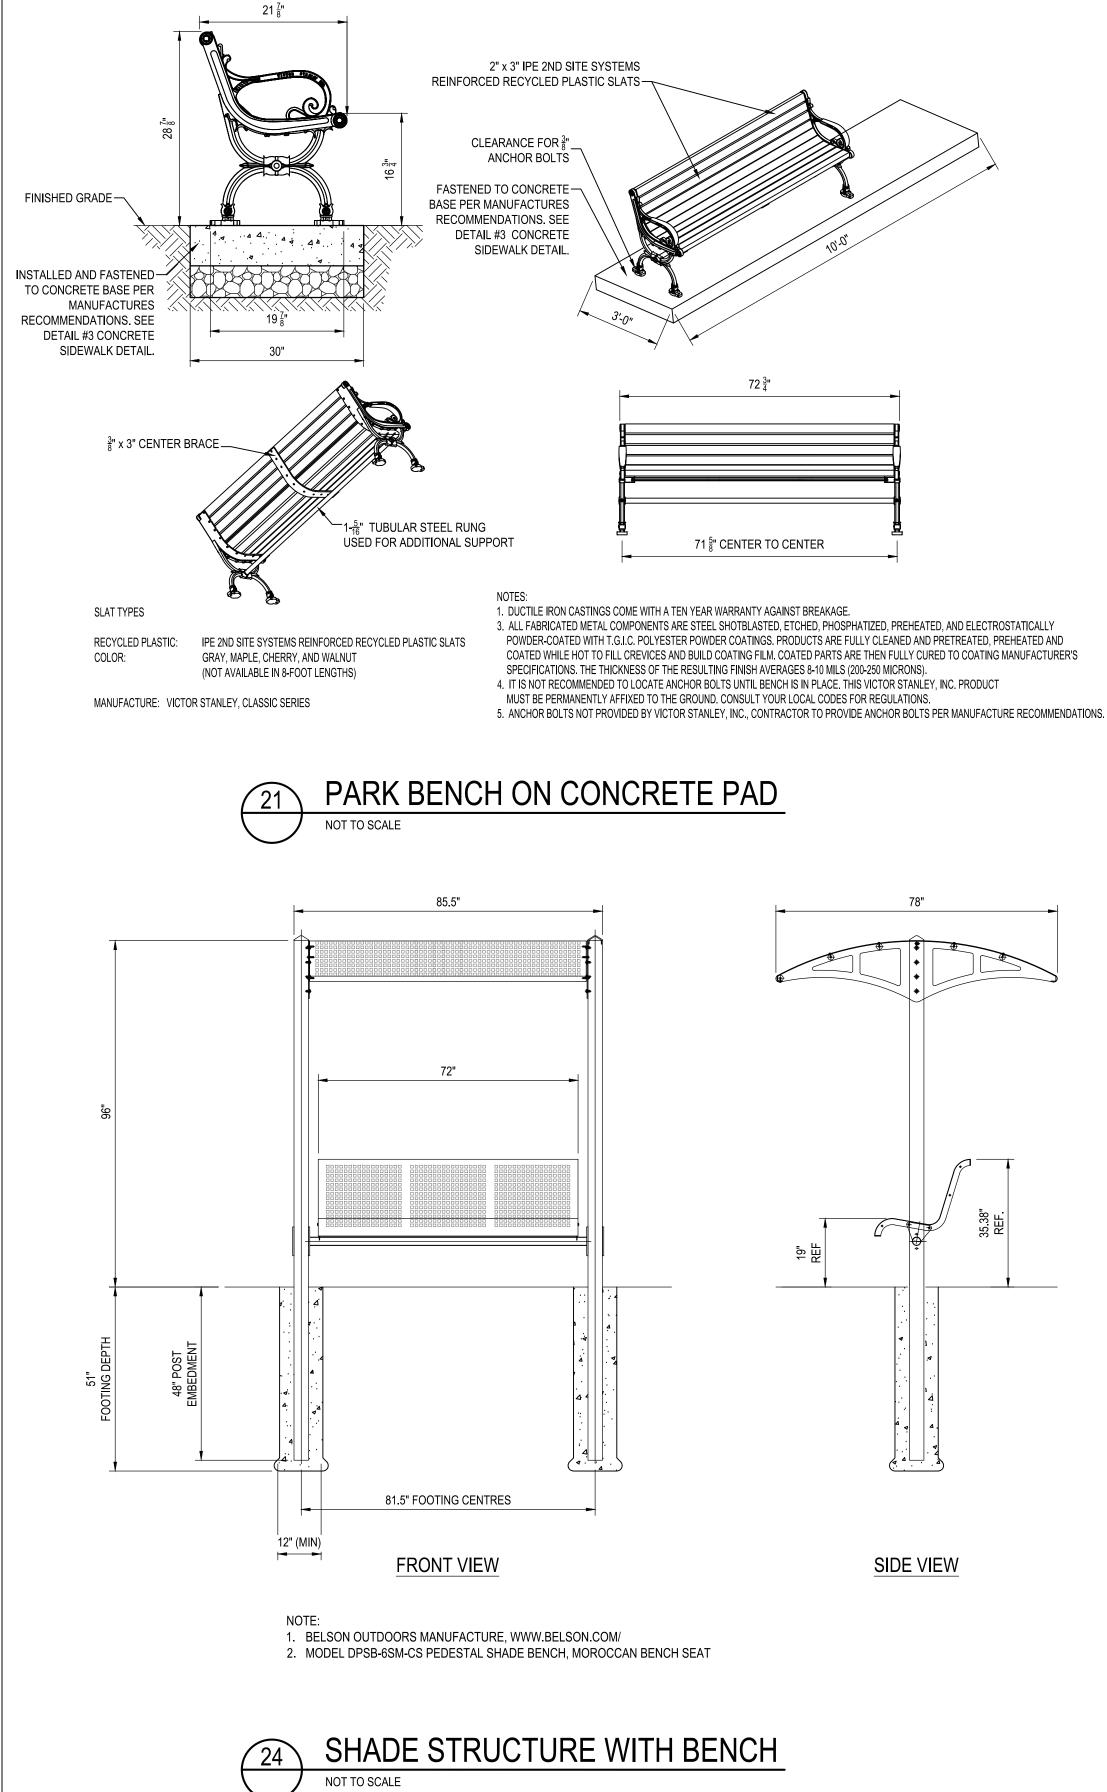



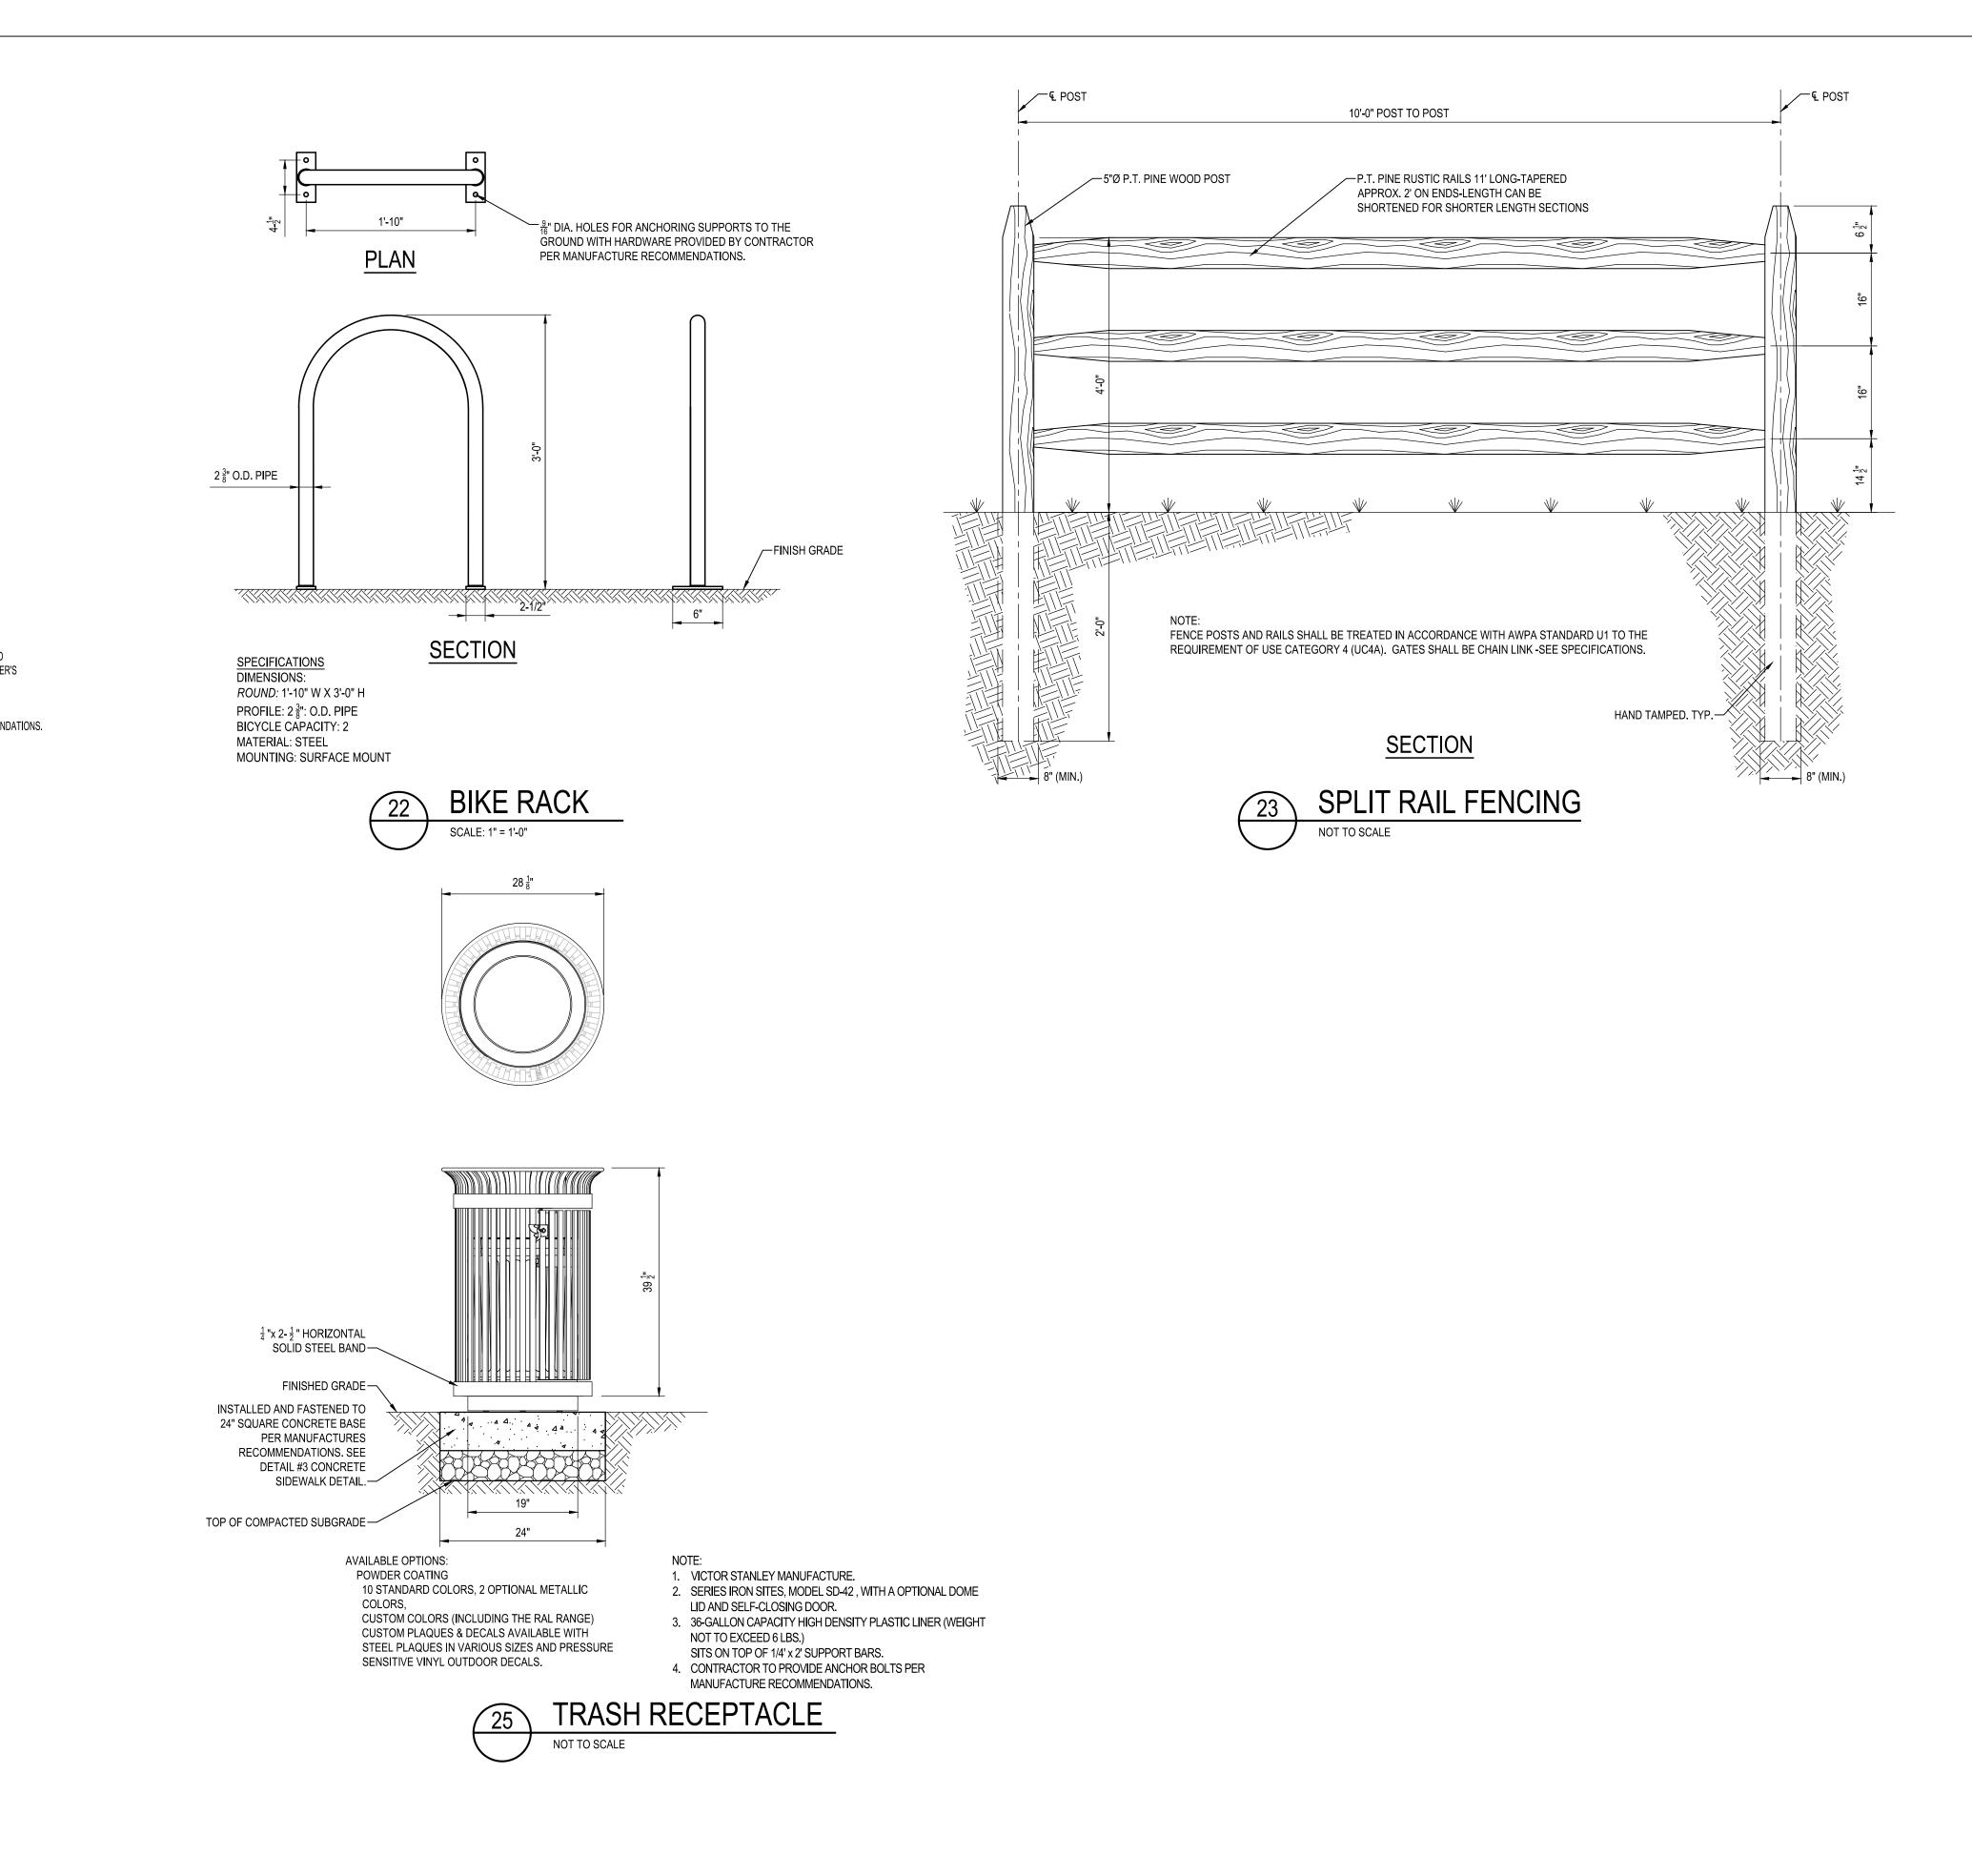


	NO.	DESCRIPTION	BY	DATE	
					APPROVED
					_
					CHIEF ENGINEER
					APPROVED
I hereby certify that these documents were prepared or approved by me, and that I am a duly licensed professional engineer under the laws of the State of					_
Maryland.					ASSISTANT CHIEF ENGINEE

License #27734 Expiration Date: 07/12/2024


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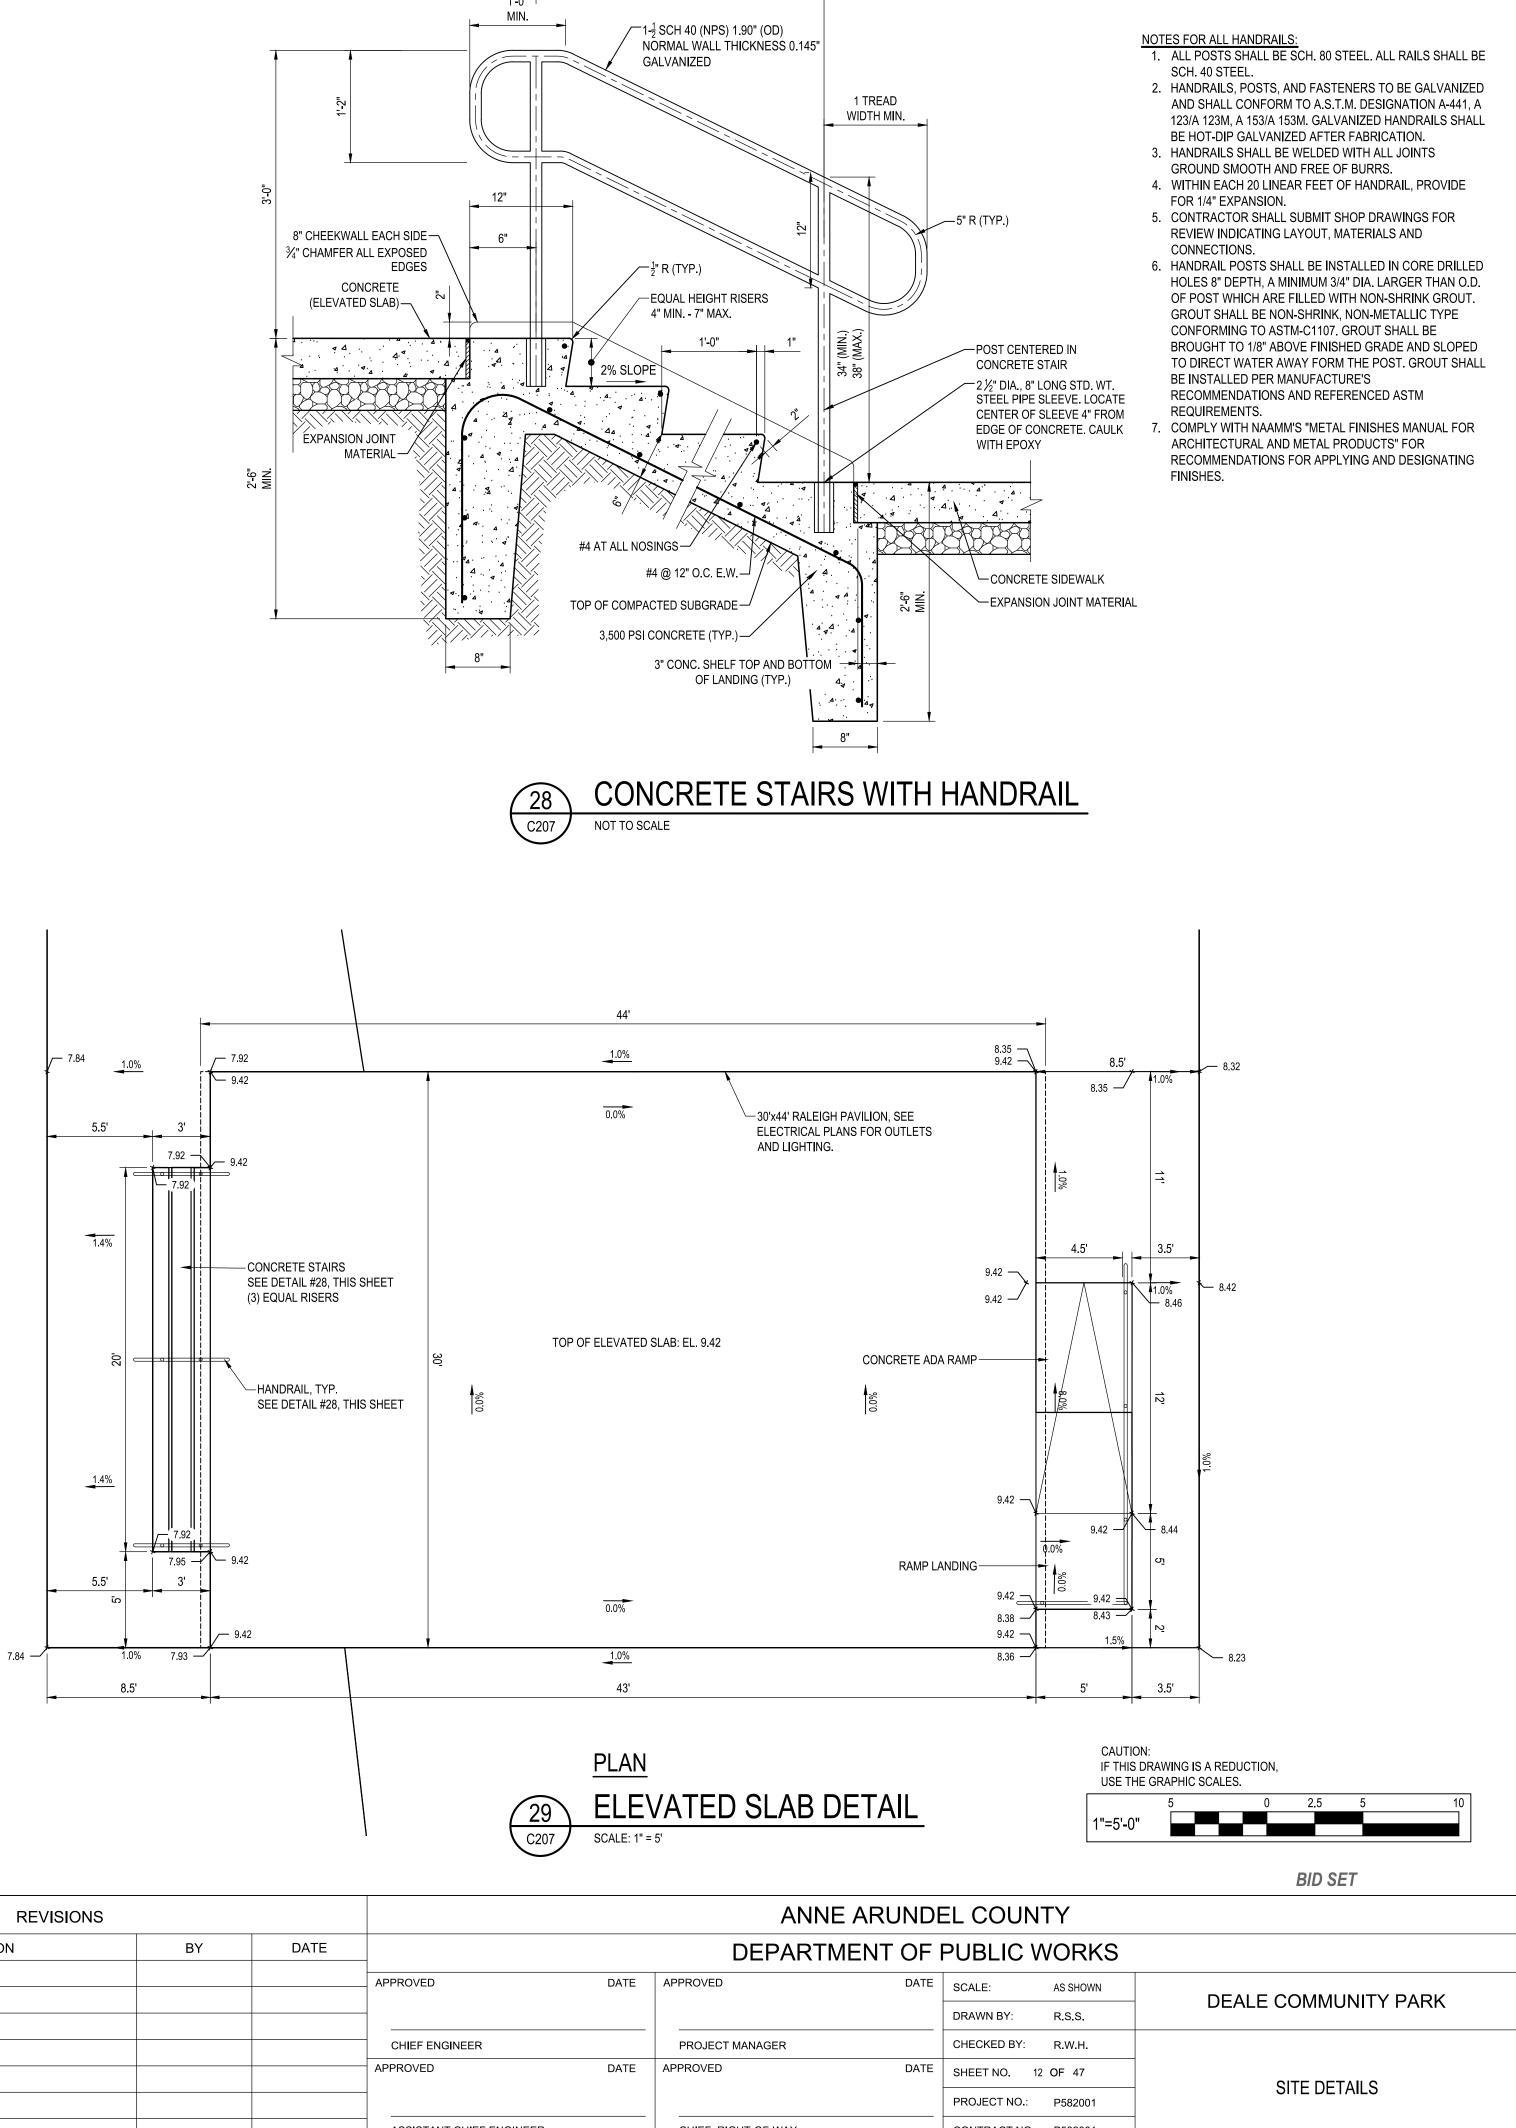
DEPARTMENT OF PUBLIC WORKS						
DATE	APPROVED DATE	SCALE: AS SHOWN	DEALE COMMUNITY PARK			
		DRAWN BY: R.S.S.				
	PROJECT MANAGER	CHECKED BY: R.W.H.				
DATE	APPROVED DATE	SHEET NO. 11 OF 47	SITE DETAILS			
		PROJECT NO.: P582001	SITE DETAILS			
NGINEER	CHIEF, RIGHT-OF-WAY	CONTRACT NO.: P582001				
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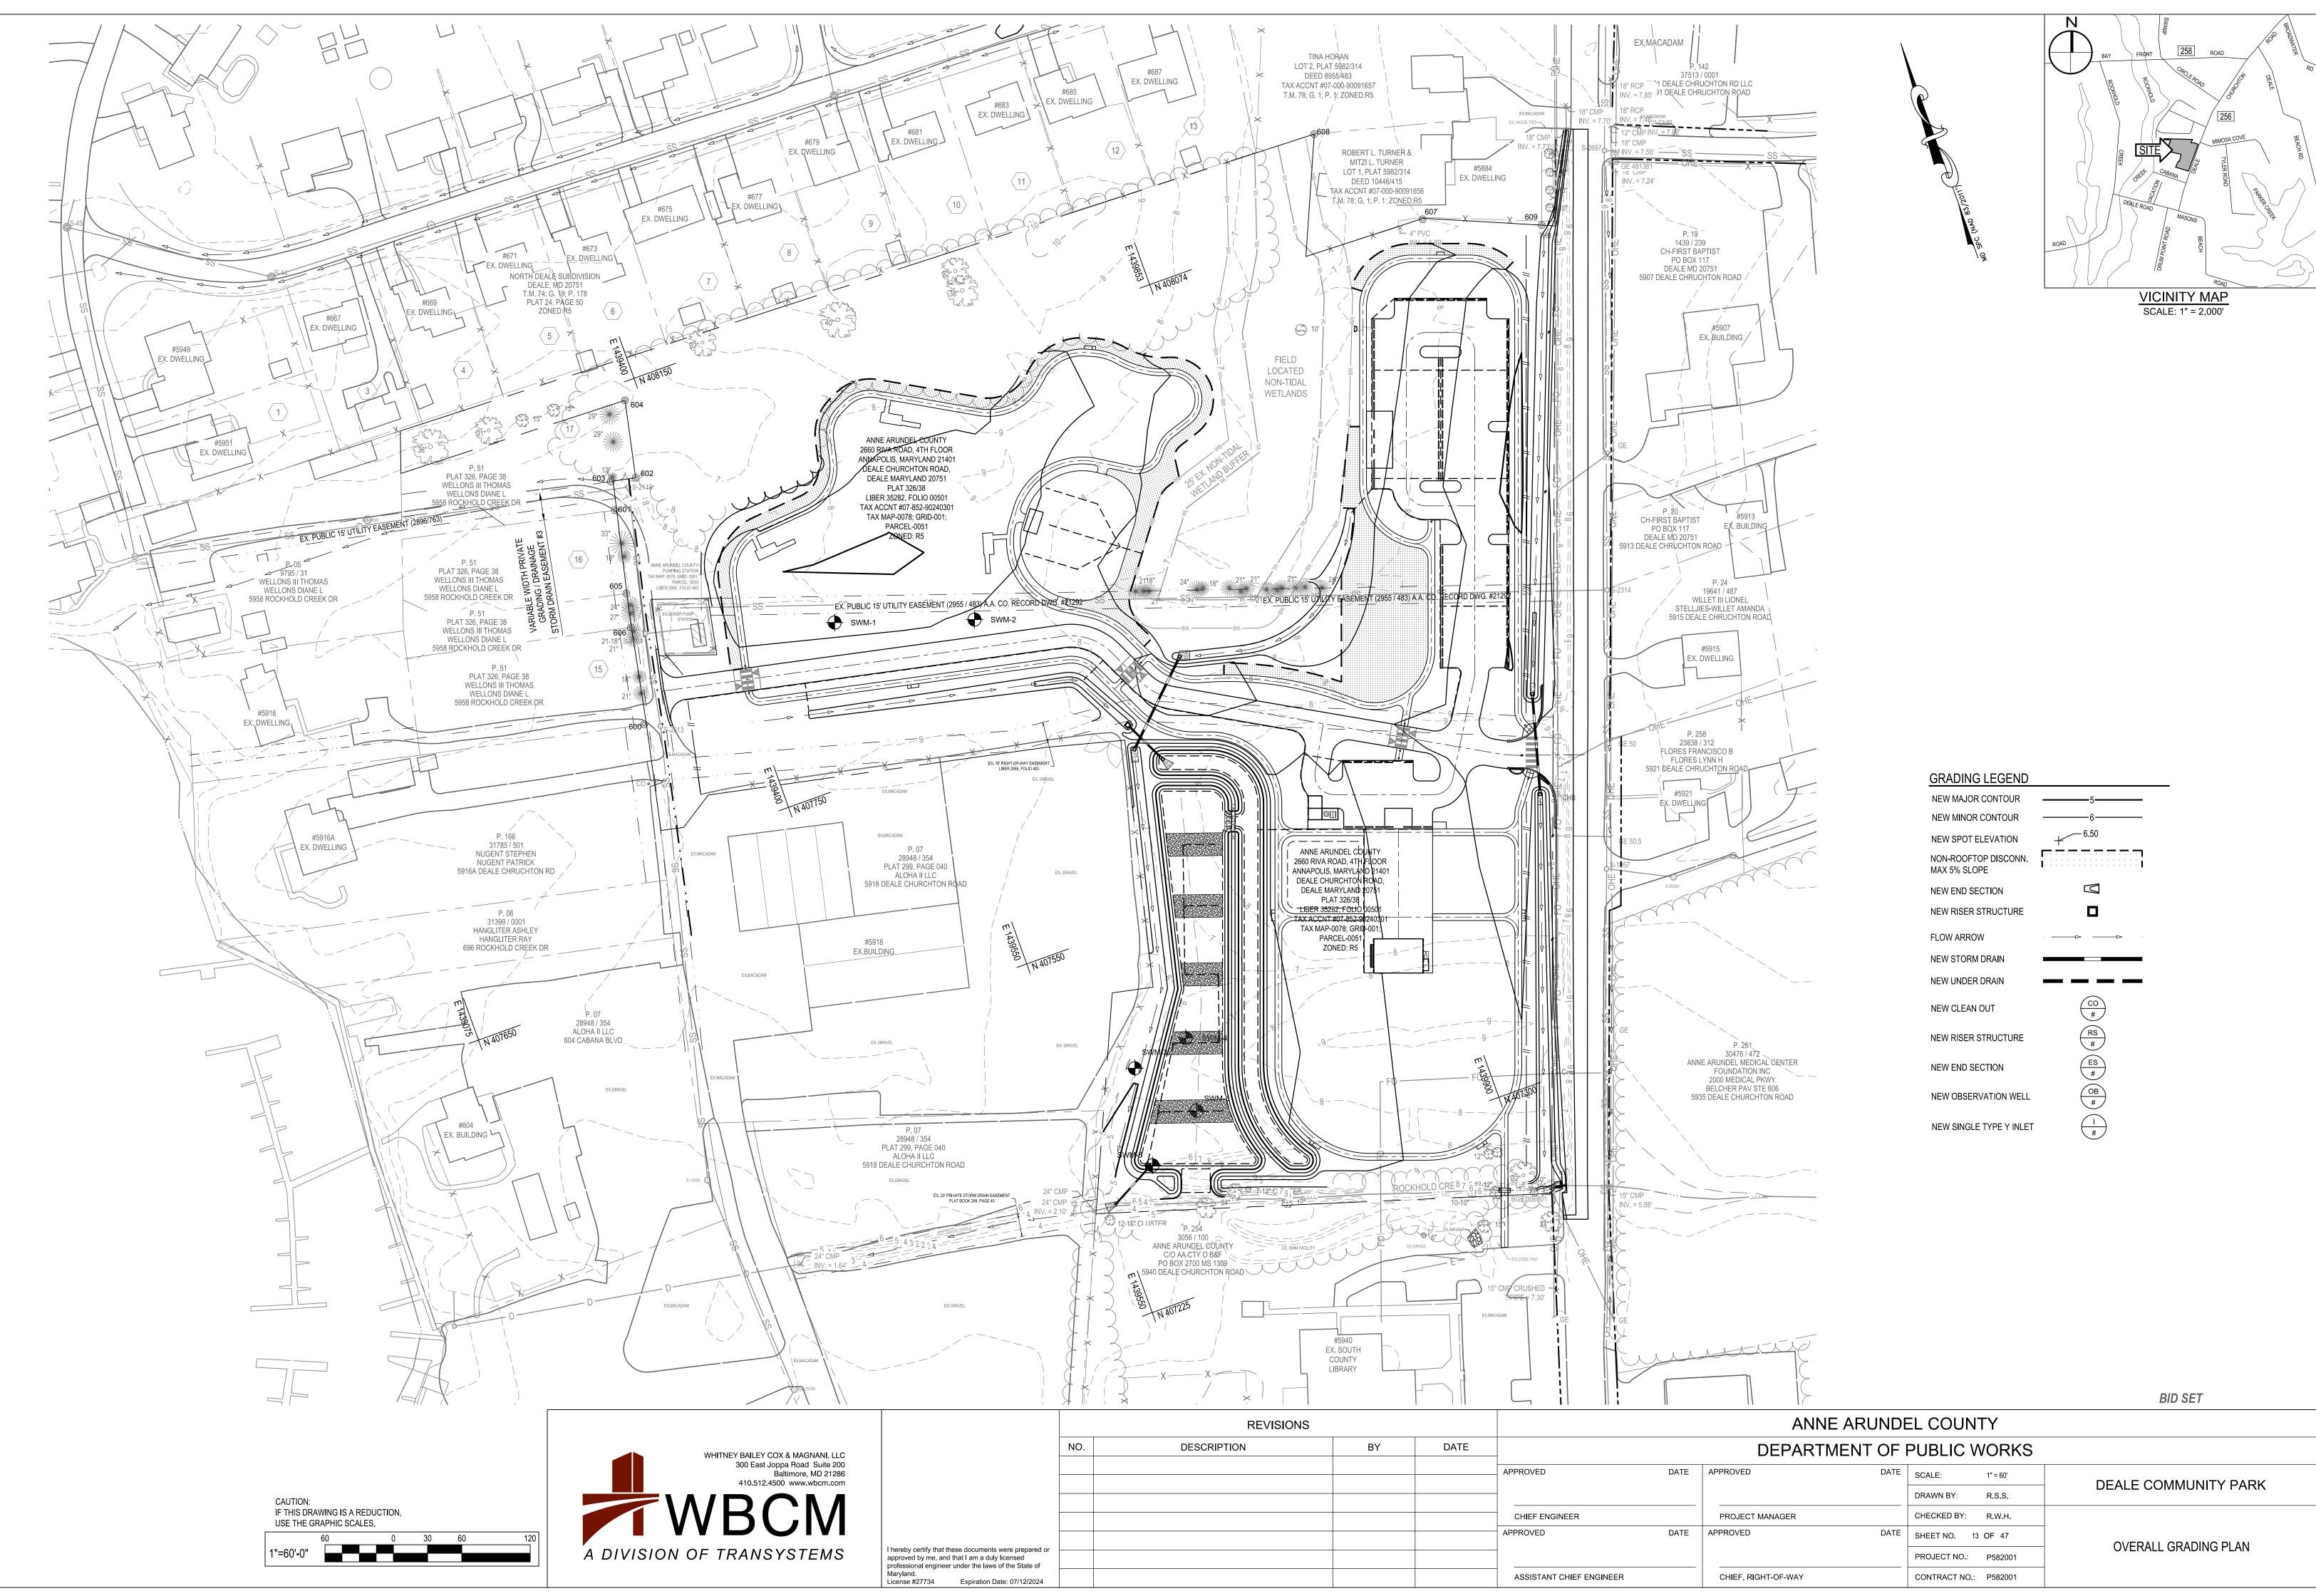



6'-0" O.C. MAX. POST SPACING

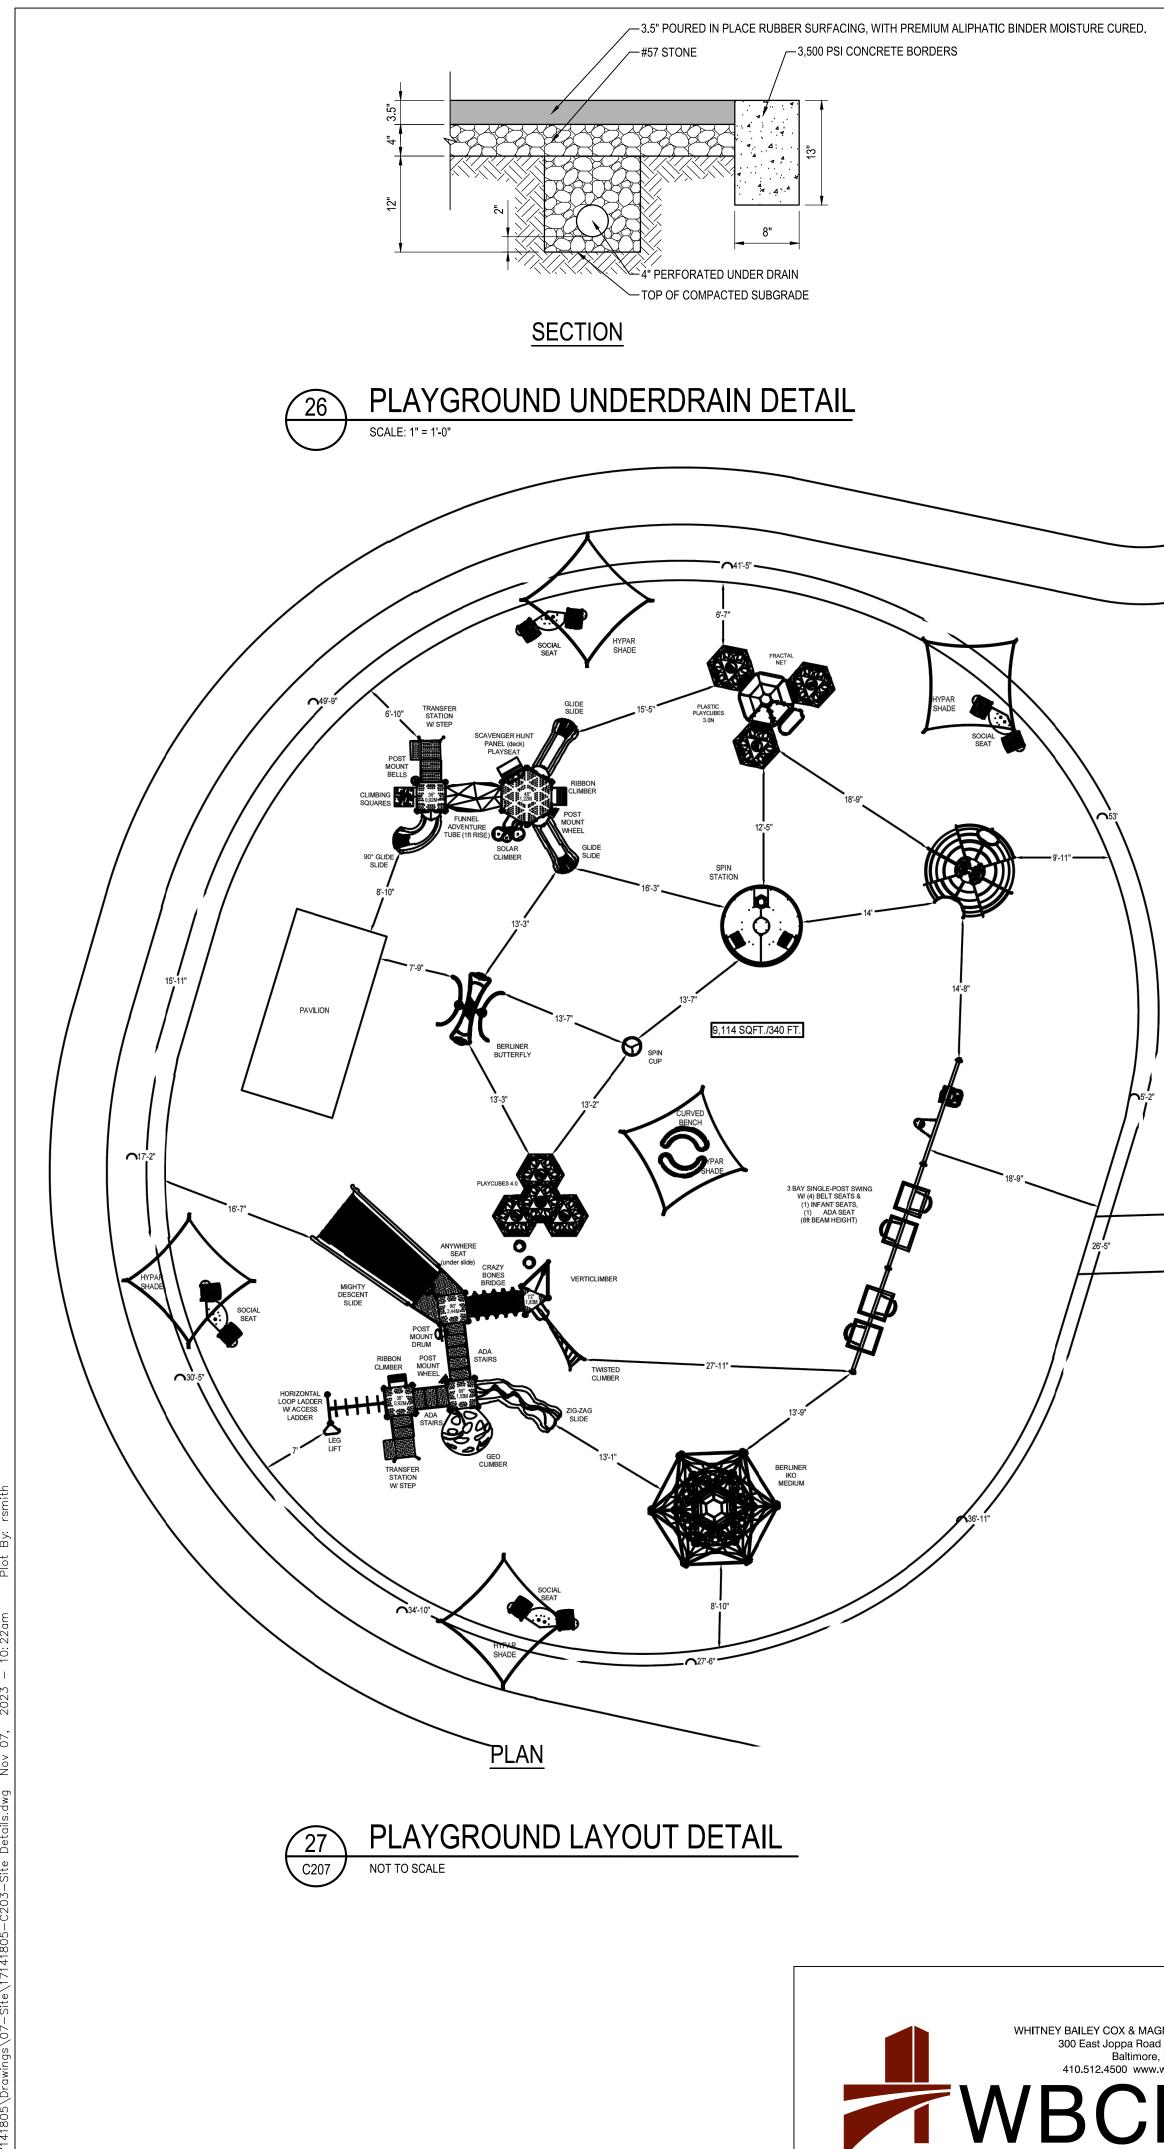AGNANI, LLC	NO.	
pad Suite 200 pre, MD 21286		
w.wbcm.com		
TEMS Thereby certify that these documents were prepared or approved by me, and that I am a duly licensed professional engineer under the laws of the State of		

	REVISIONS	8		
0.	DESCRIPTION	BY	DATE	_
				APPROVED
				CHIEF ENGINEER
				APPROVED
				ASSISTANT CHIEF ENGINEE


Maryland. License #27734 Expiration Date: 07/12/2024

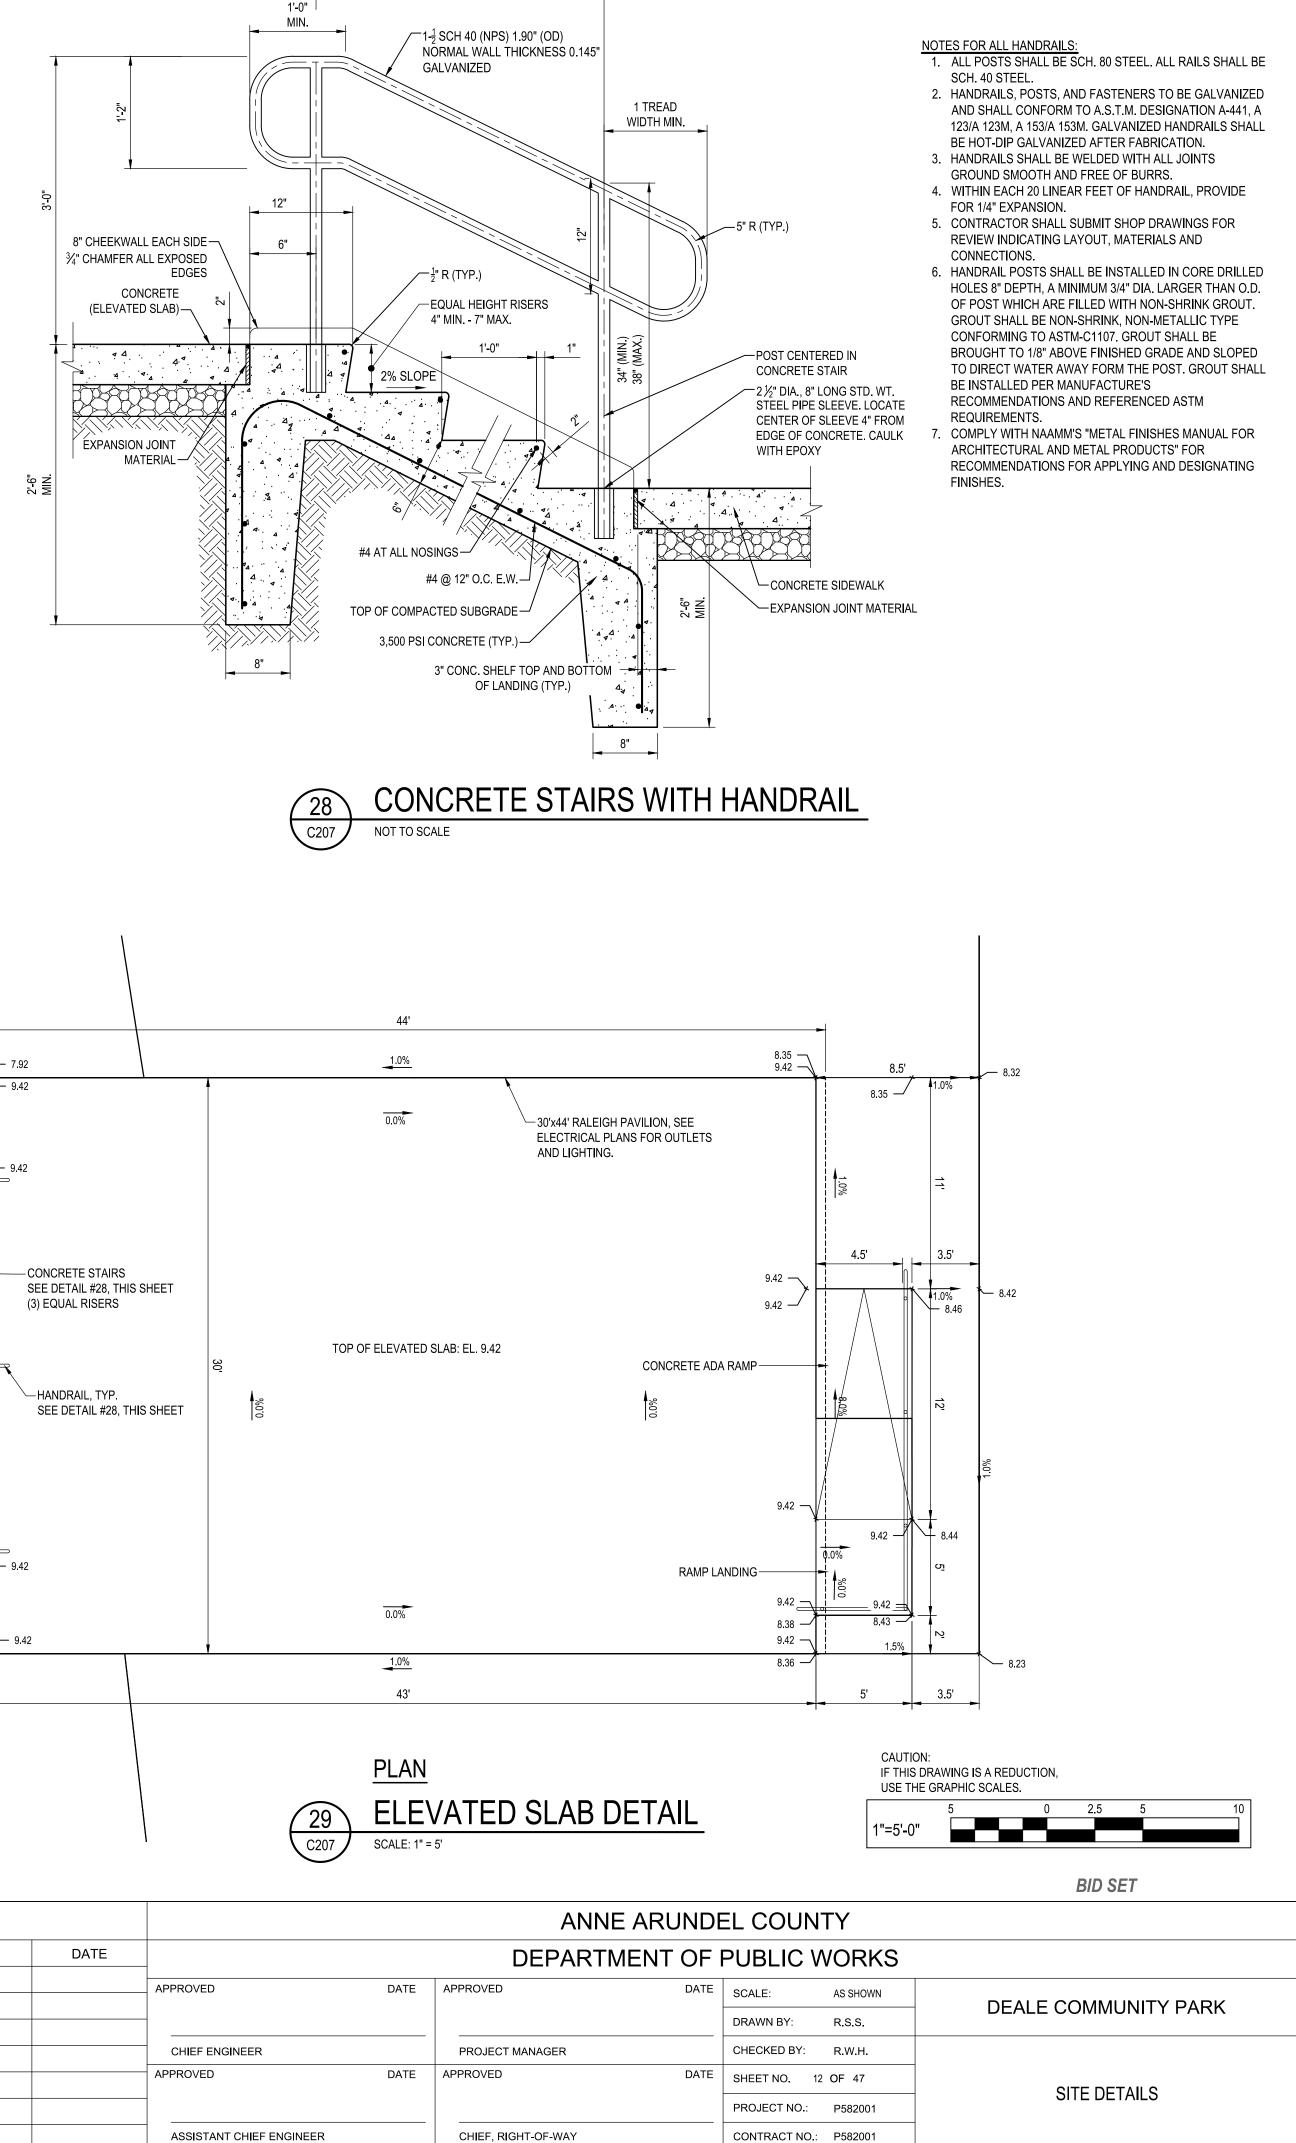

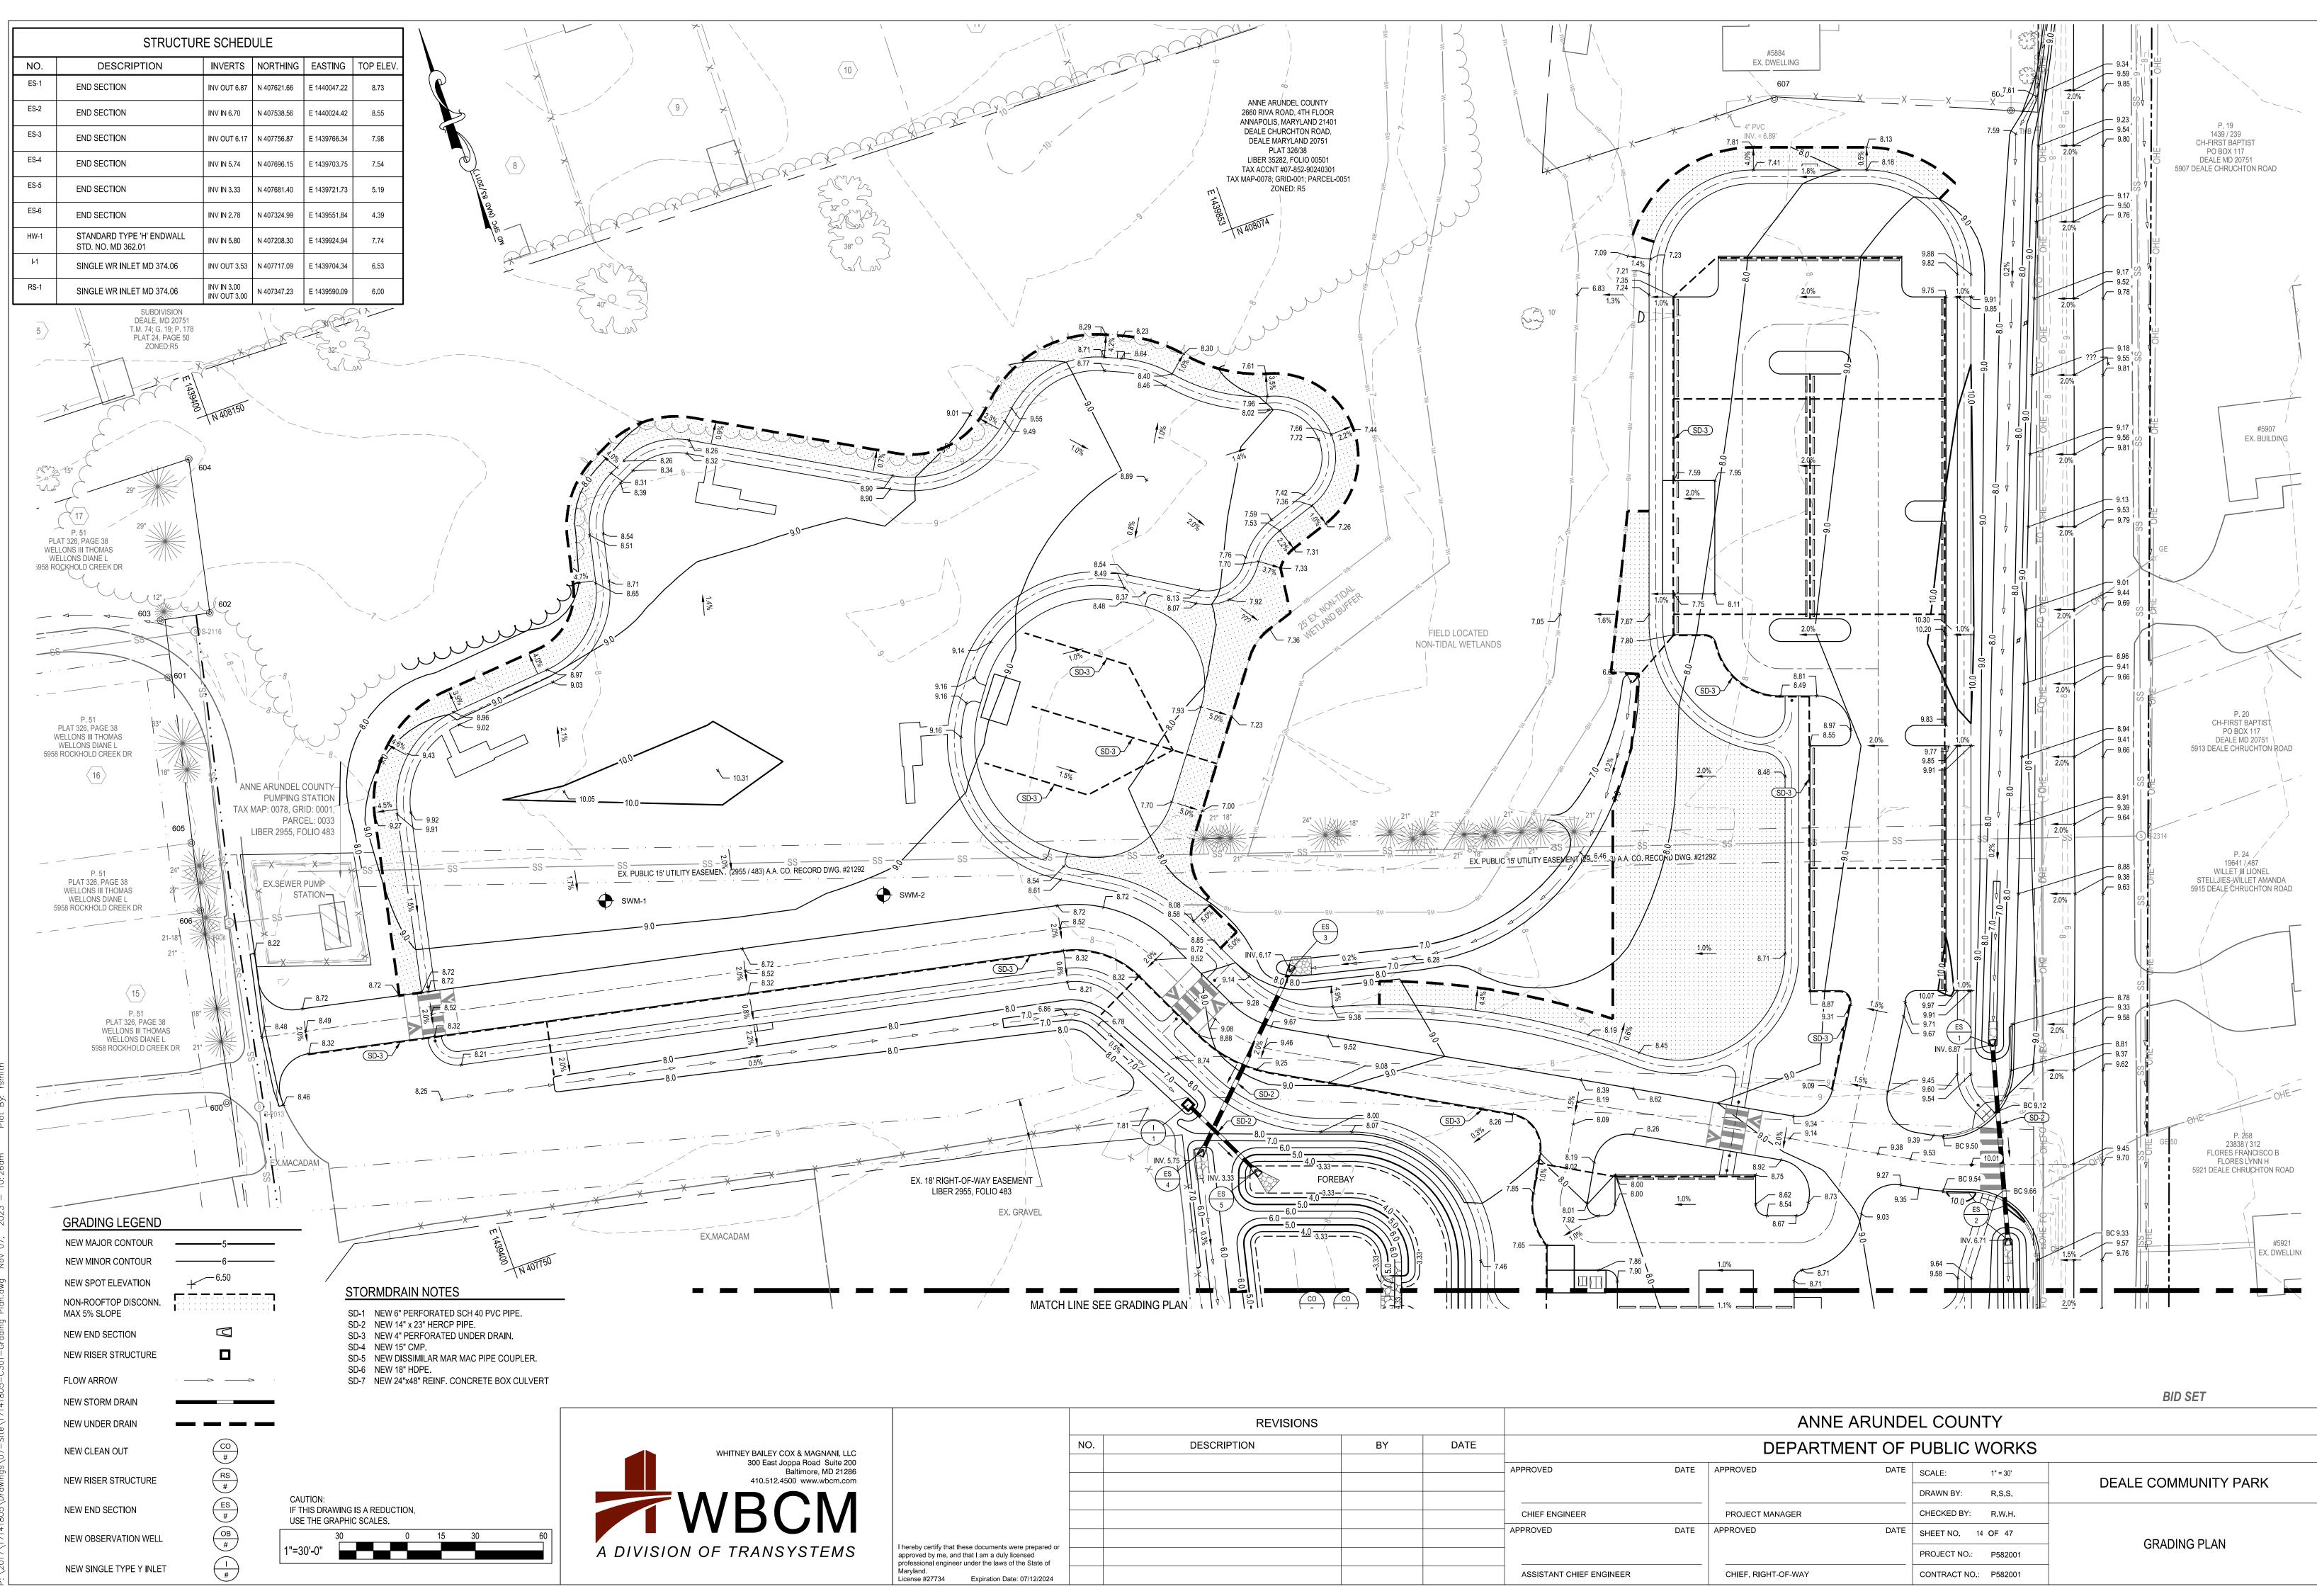

EY COX & MAGNANI, LLC		NO.	DESCRIPTION	BY	DATE	
st Joppa Road Suite 200 Baltimore, MD 21286 12.4500 www.wbcm.com						APPROVED
CM						CHIEF ENGINEER
						APPROVED
ISYSTEMS	I hereby certify that these documents were prepared or approved by me, and that I am a duly licensed professional engineer under the laws of the State of					
	Maryland.					ASSISTANT CHIEF ENG

DATE	APPROVED	DATE	SCALE:	1" = 30'	DEALE COMMUNITY PARK		
			DRAWN BY:	R.S.S.			
	PROJECT MANAGER		CHECKED BY:	R.W.H.			
DATE	APPROVED	DATE	SHEET NO. 14	OF 47	GRADING PLAN		
			PROJECT NO.:	P582001	GRADING PLAN		
NGINEER	CHIEF, RIGHT-OF-WAY		CONTRACT NO.:	P582001			

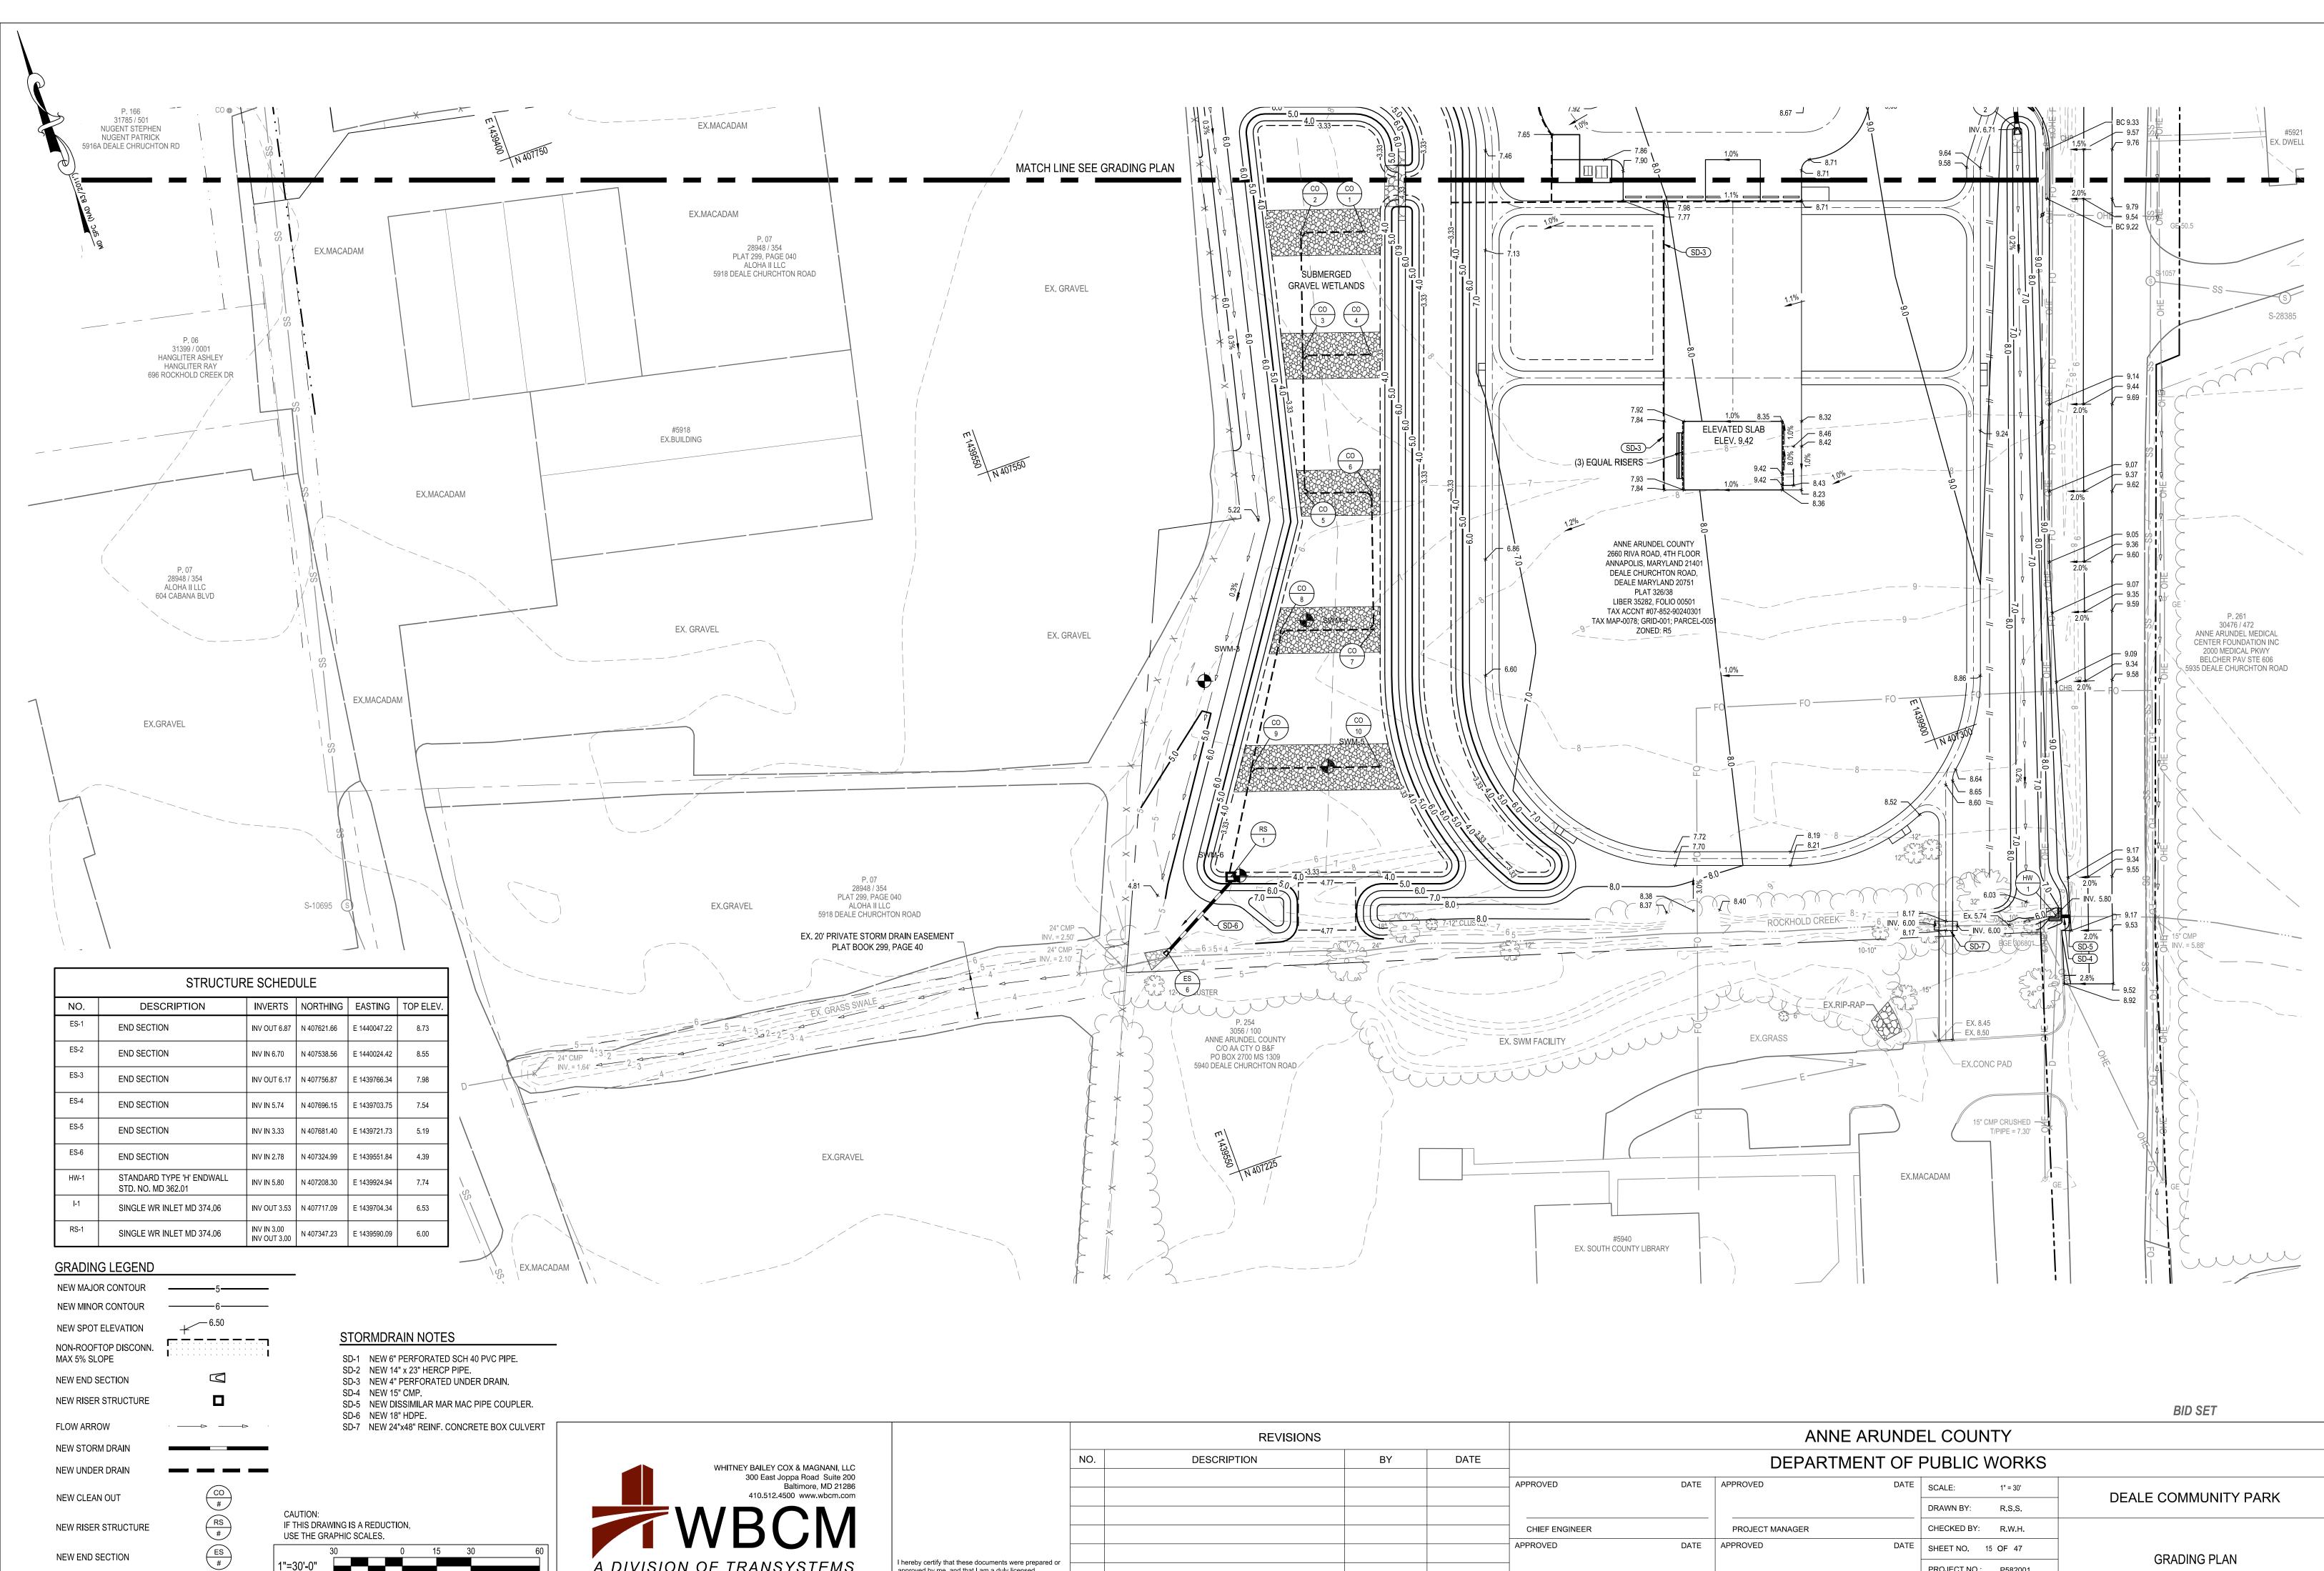

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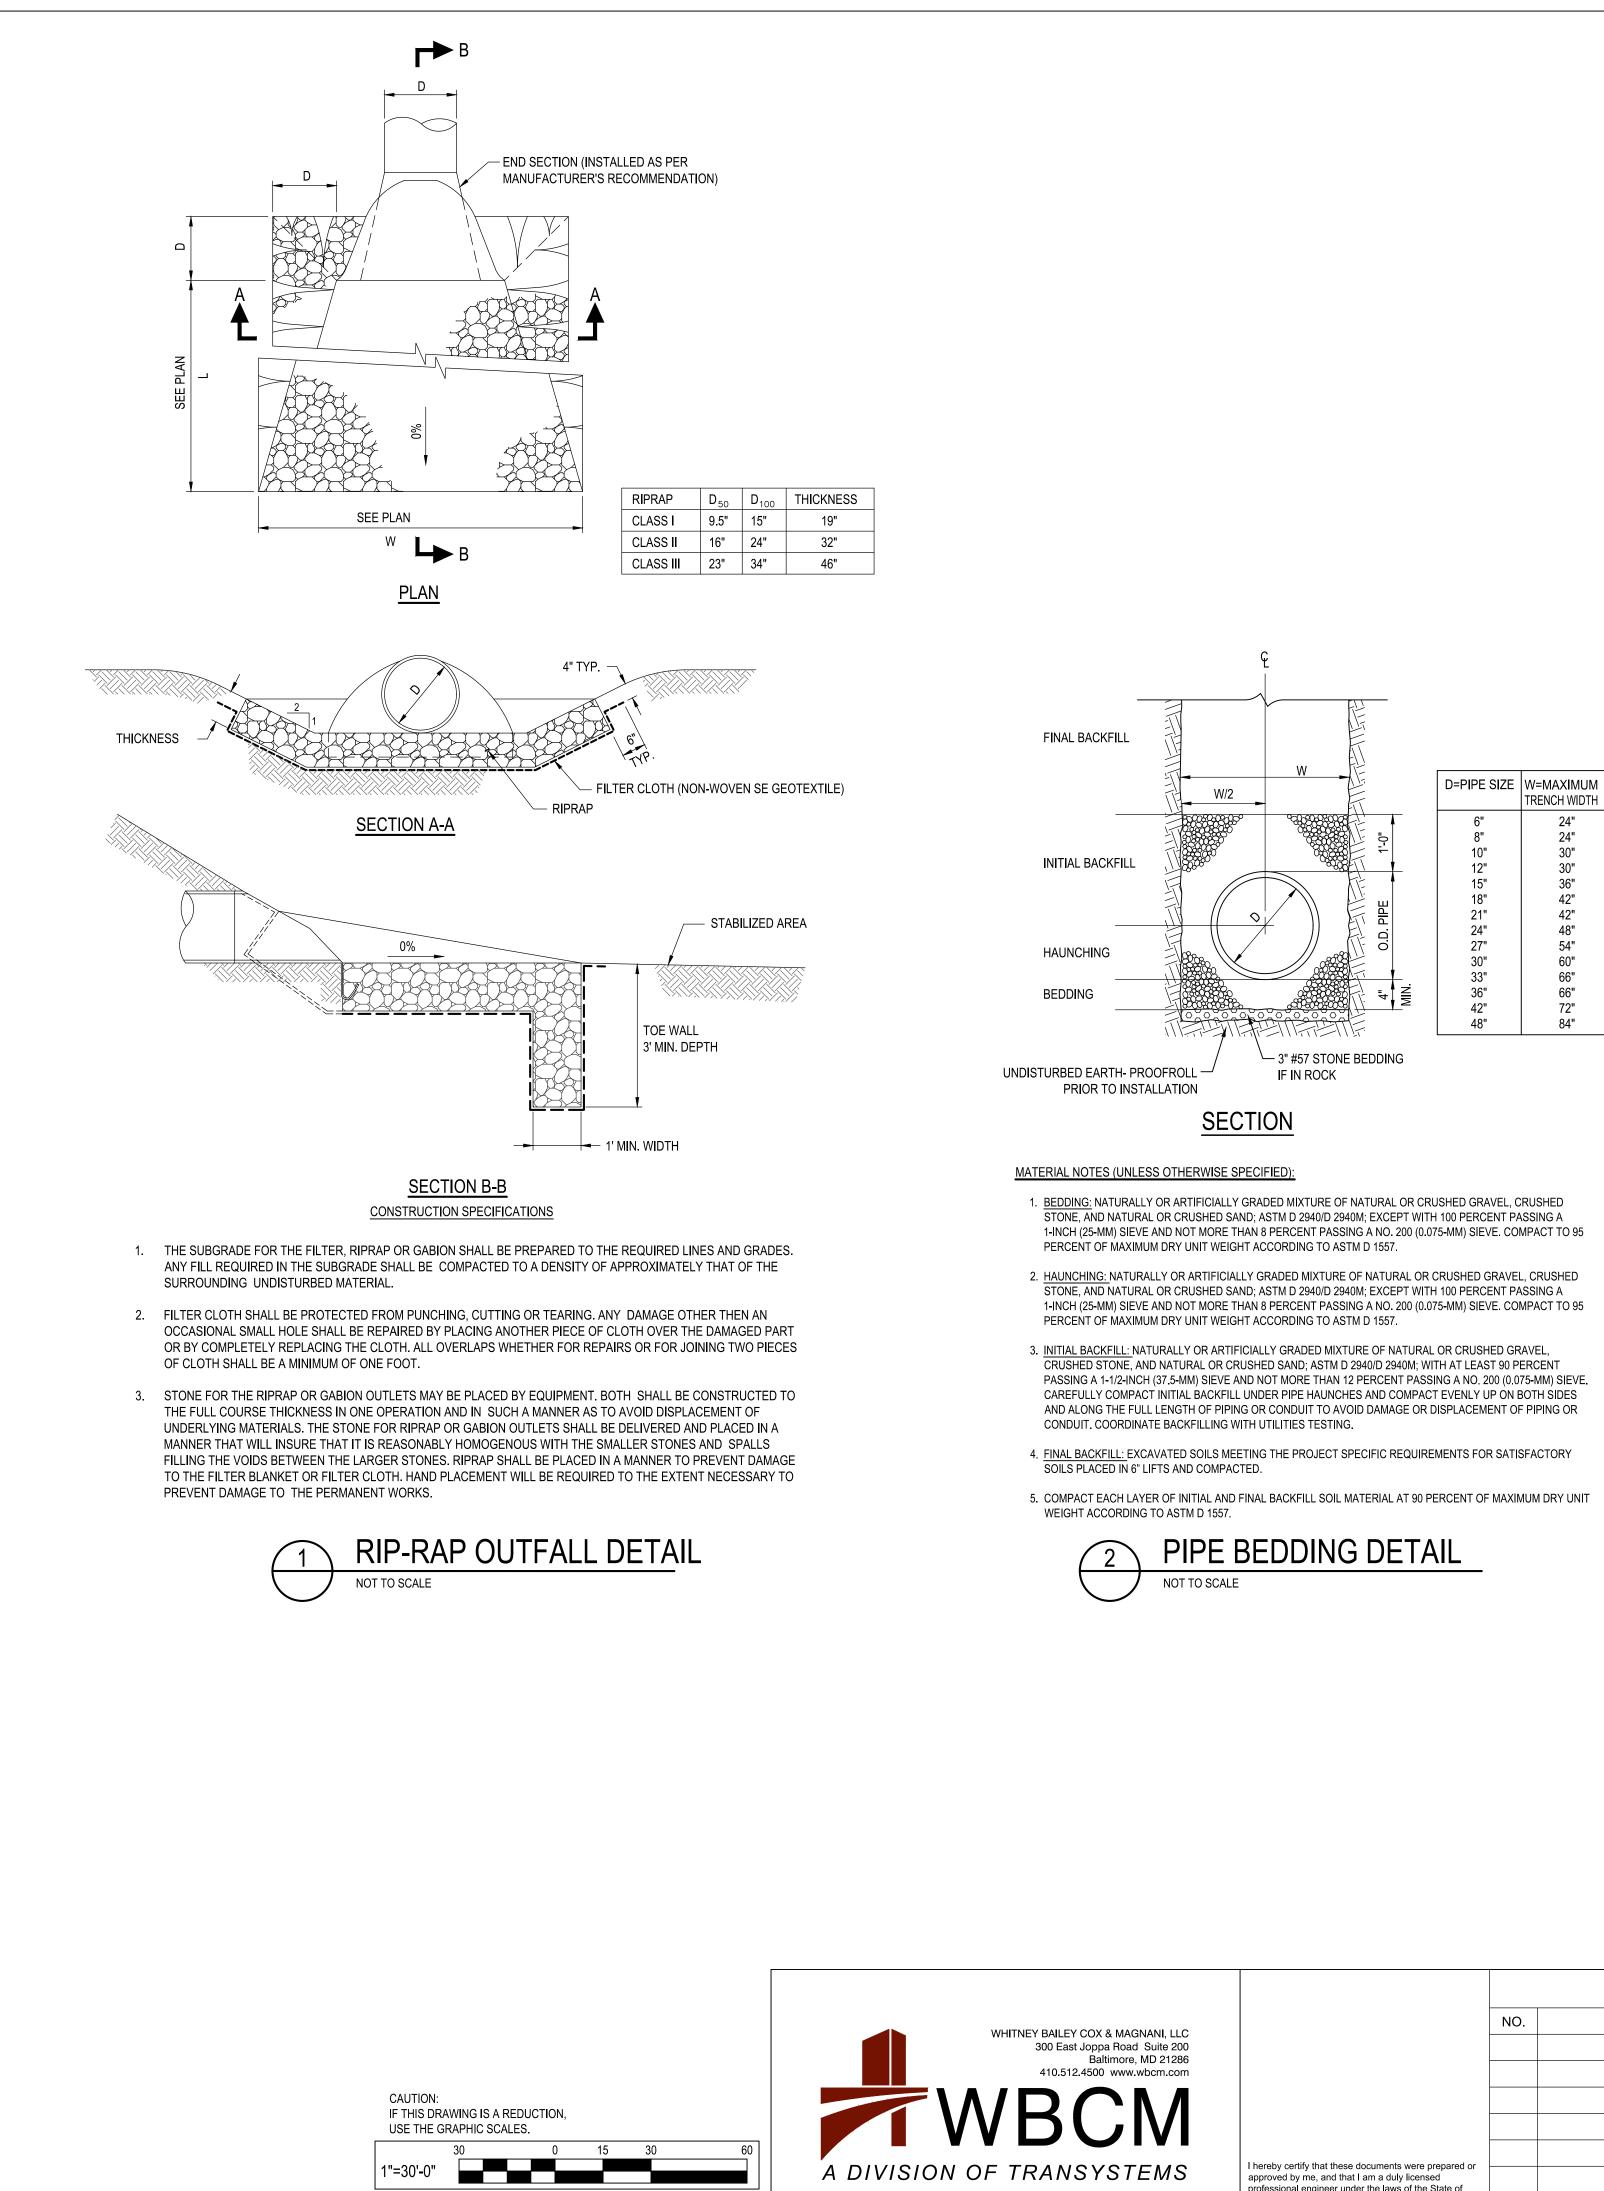
1"=30'-0"


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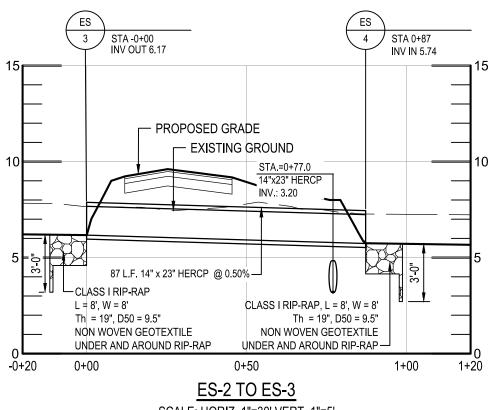
NEW OBSERVATION WELL


EY COX & MAGNANI, LLC		NO.	DESCRIPTION	BY	DATE	_
ast Joppa Road Suite 200 Baltimore, MD 21286 512.4500 www.wbcm.com						APPROVED
						1
						CHIEF ENGINEER
						APPROVED
NSYSTEMS	I hereby certify that these documents were prepared or approved by me, and that I am a duly licensed professional engineer under the laws of the State of					-
	Maryland. License #27734 Expiration Date: 07/12/2024					ASSISTANT CHIEF ENGI


DATE	APPROVED DATE	SCALE: 1" = 30'	DEALE COMMUNITY PAR
		DRAWN BY: R.S.S.	
	PROJECT MANAGER	CHECKED BY: R.W.H.	
DATE	APPROVED DATE	SHEET NO. 15 OF 47	
		PROJECT NO.: P582001	GRADING PLAN
NGINEER	CHIEF, RIGHT-OF-WAY	CONTRACT NO.: P582001	





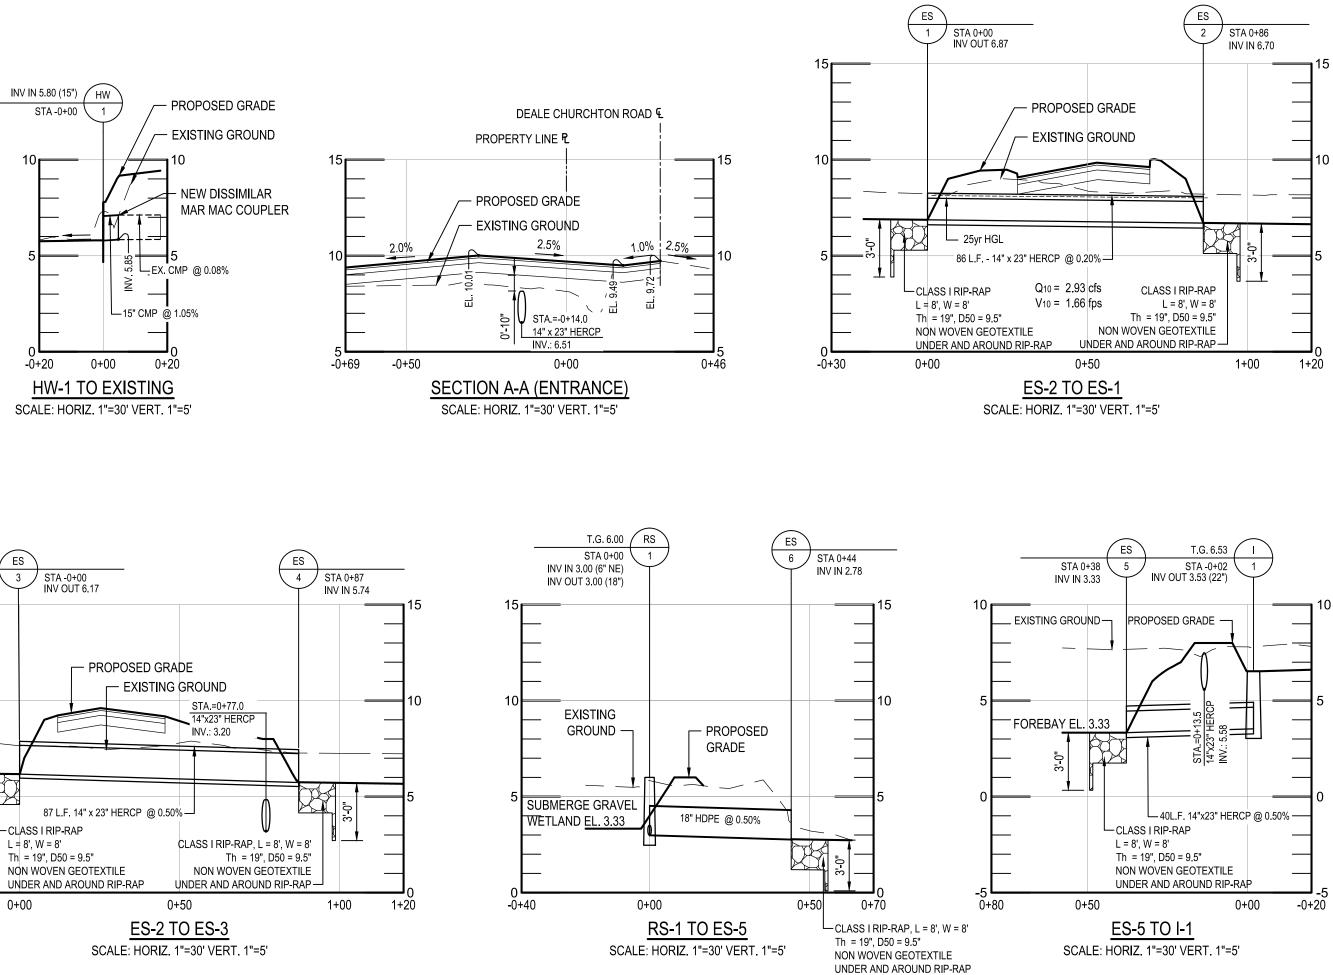

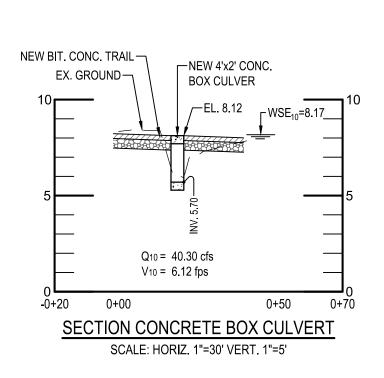

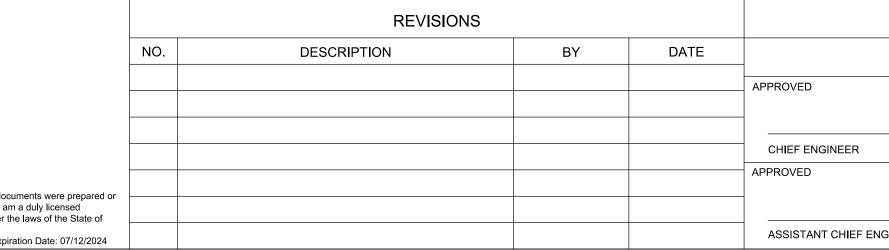



1-INCH (25-MM) SIEVE AND NOT MORE THAN 8 PERCENT PASSING A NO. 200 (0.075-MM) SIEVE. COMPACT TO 95

professional engineer under the laws of the State of Maryland. License #27734 Expiration Date: 07/12/2024

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	DEPARTMENT OF	PUBLIC WORKS	
DATE	APPROVED DATE	SCALE: 1" = 30'	DEALE COMMUNITY PARK
		DRAWN BY: R.S.S.	
	PROJECT MANAGER	CHECKED BY: R.W.H.	
DATE	APPROVED DATE	SHEET NO. 16 OF 47	PROFILES
		PROJECT NO.: P582001	
NGINEER	CHIEF, RIGHT-OF-WAY	CONTRACT NO.: P582001	



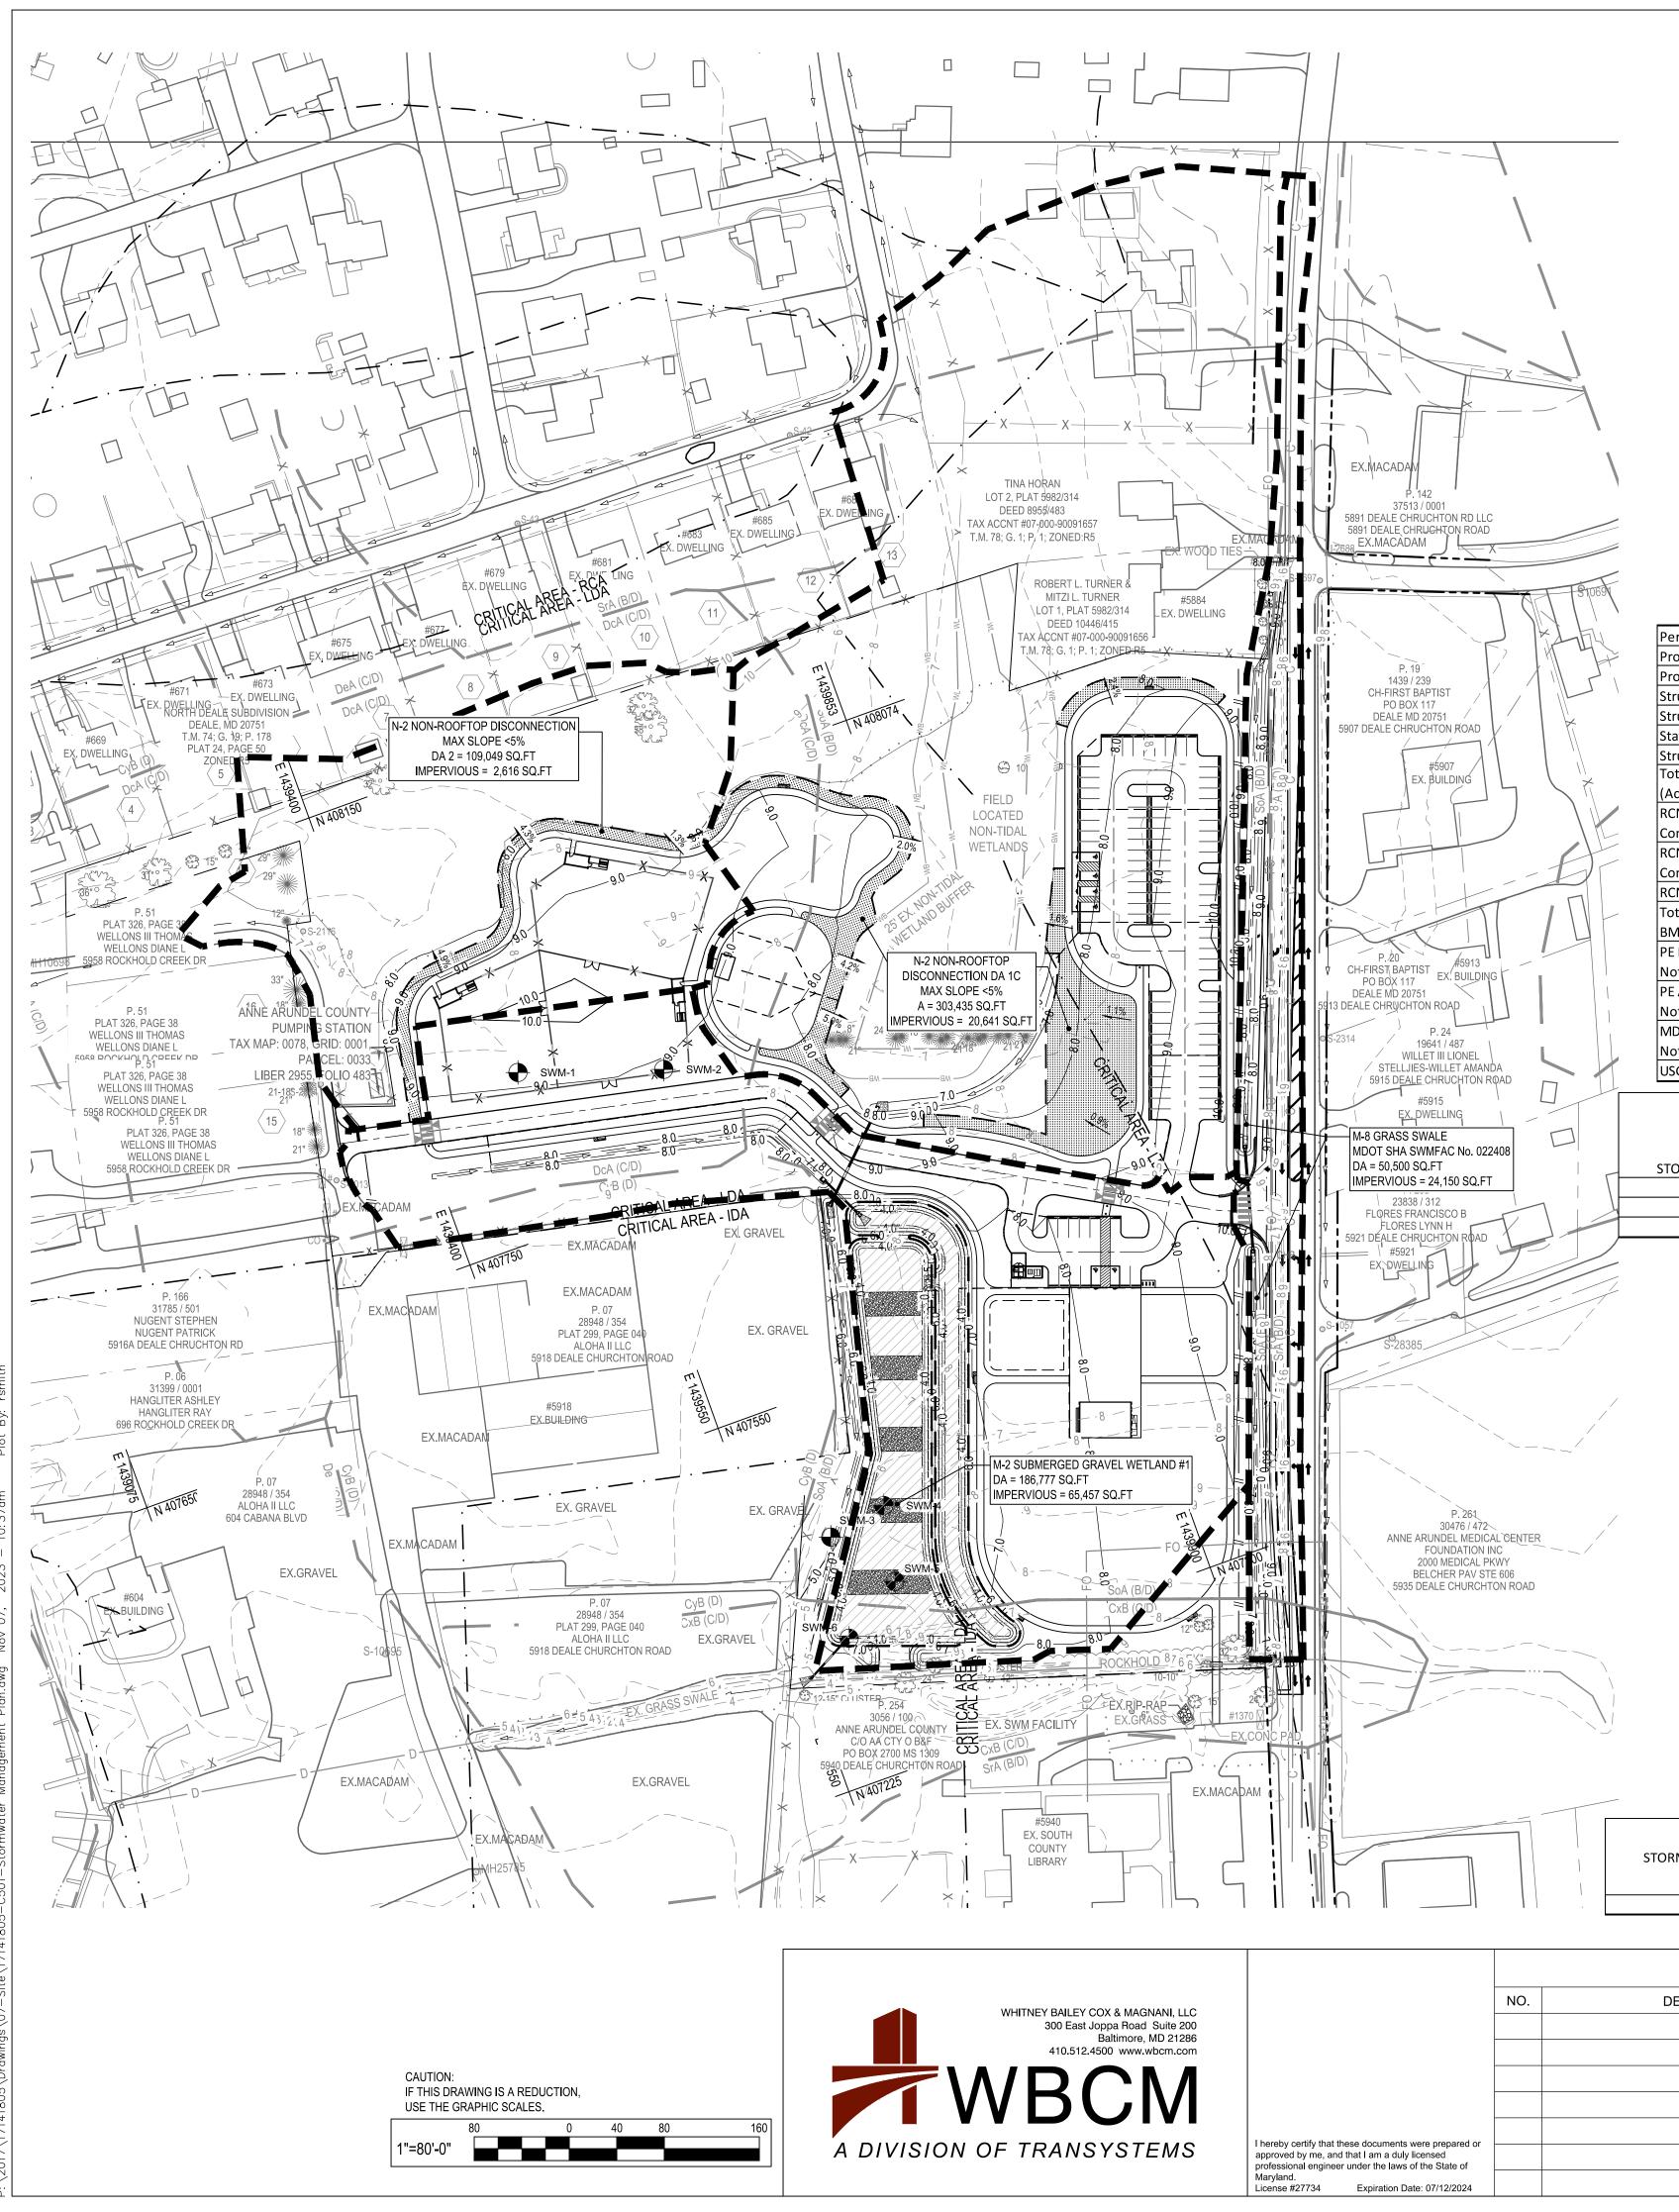

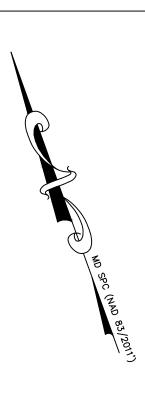Project Table for Drainage Area DA-1 (A-F)

Permit Number	G02019665			
Project Number	P582000			
Project Name	DEALE COMMUNITY PARK			
StructureAddress	DEALE CHURCHTON ROAD			
Structure City	DEALE			
State	MD			
Structure Zip	20751			
Total Drainage Area				
(Acres)	30.93			
RCN - Pre				
Construction	83			
RCN - Post				
Construction	84			
RCN - Woods	77			
Total Number of				
BMPs	3			
PE Required (see				
Note 1)	1.6			
PE Addressed (see				
Note 2)	1.6			
MD 8-Digit HUC (see				
Note 4)	2131005			
USGS 12-Digit HUC				

							DEVICE	IMPERVIOUS	IMPERVIOUS				Maintenance	
								AREA DRAINING		MD NORTH	MD EAST	WQ _v	Responsibility	
		MDE BMP	MDE BMP	CONSTRUCTION	ON or OFF		AREA	TO DEVICE	RESTORED (See	COORD	COORD	(ft3) (See		
STORM_ID	STRU_NAME	CLASS	TYPE	PURPOSE	SITE	LAND USE	(acres)	(Square feet)	Note 3)	(NAD83 - FT)	(NAD83 - FT)	Note 5)		Comments
	Submerged Gravel Wetland	E	M2	NEWD	ON	MSGW	4.29	65,457	N/A	N 407,480	E 1,439,690	15,339	County	
	Grass Swale	E	M8	NEWD	ON	MSWG	1.16	24,150	N/A	N 407,749	E 1,440,097	657	County	
	Disconnection of Non-Rooftop Runoff	E	N2	NEWD	ON	NDNR	6.97	20,641	N/A	N 407,740	E 1,439,960	1,634	County	

Project Table for Drainage Area DA-2

Permit Number	G02019665														
Project Number	P582000							Stormwate	r Manage	ment - Summ	ary				
Project Name	DEALE COMMUNITY P	PARK		WM Summary							,				
StructureAddress	DEALE CHURCHTON R	ROAD	30					1		I	1	1		1	
Structure City	DEALE			ESD Practice	ESD Pra	ation			Area of Filter Af	Drainage Area	Impervious Area	1%	Rv	Design Pe	ESDv treated
State	MD			type	ESD Pra	actice		Number	(ft2)	(ft2)	(ft2)	1%	KV	Design Pe	(ft3)
Structure Zip	20751					VEL WETLA		1	21,433	186,777	65,457	35%	0.37	2.70	15,339
Total Drainage Area	2.501										· · · · · · · · · · · · · · · · · · ·				
Acres)	2.501			M8 GRAS	SS SWALE - :	SHA impervic	ouss	2	2,220	50,500	24,150	37%	0.47	1.00	657
RCN - Pre	80			N2 N-2, Dis		f Non-rooftop	runoff	1	4,360	109,049	2,616	2%	0.95	1.00	207
Construction				INZ	Imperviou	us DA-2		·	4,500	103,043	2,010	2 /0	0.95	1.00	207
RCN - Post	80			N-2, Dis	connection of	f Non-rooftop	runoff	0	20 6 4 4	202.425	20.044	70/	0.05	1.00	4 004
Construction			_	N2	Imperviou	s DA-1C		2	20,641	303,435	20,641	7%	0.95	1.00	1,634
RCN - Woods	77		Su	ub-total Provideo	d Treatment	bv ESD mea	sures			649,761	112,864				17,837
Fotal Number of 3MPs	1			equired Treatme		-				,		I		1.60	17,539
PE Required (see Note 1)	1.6														
PE Addressed (see Note 2)	0.1														
MD 8-Digit HUC (see Note 4)	2131005														
JSGS 12-Digit HUC															
D	STRU_NAME	MDE BMP	MDE BMP		ON or OFF	LAND USE	DEVICE DRAINAGE	IMPERVIOUS AREA DRAINING	IMPERVI ACRE			WQ _v (ft3) (See		intenance	Comment

STORM_I 0_1 CLASS TYPE PURPOSE Disconnection of Non-Rooftop Runoff E N2 NEWD REVISIONS DATE DESCRIPTION ΒY

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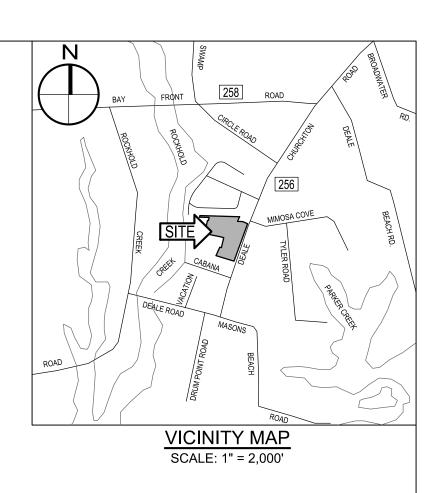
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CHIEF ENGINEER

STORMWATER MANAGEMENT LEGEND

SoA (B/D)	
DcA (C/D)	MAPPED SOIL UNIT / HYDROLOGIC SOIL GROUP RATIN
	DRAINAGE AREA BOUNDARY
	PROPOSED STORM DRAIN
	M-2 SUBMERGED GRAVEL WETLAND AREA
	TRAIL SURFACE (IMPERVIOUS)
	TREATED IMPERVIOUS AREA
	NON-ROOFTOP DISCONNECTION AREA
	PERMEABLE PAVERS
SWM-#	STORM WATER BORING LOCATION




	OLND.		
NAME	DESCRIPTION	HSG RATING	k RATING (WHOLE SOIL)
CxB	CUMBERSTONE MATTAPEX	C/D	0.37
СуВ	CUMBERSTONE MATTAPEX URBAN	D	0.37
DcA	DEALE-SHADYOAK	C/D	0.43
DeA	DEALE-SHADYOAK URBAN	C/D	0.43
SoA	SHADYOAK ELKTON	B/D	0.37
SpA	SHADYOAK ELKTON (FREQUENTLY PONDE	D) B/D	0.37
SrA	SHADYOAK-ELKTON URBAN	B/D	0.37

	SUMMARY TABLE (FACILITY B	SOTTOM VS GROUND	WATER ELEVATION)	
BORING #	STORMWATER MANAGEMENT FACILITY	ELEVATION OF FACILITY BOTTOM	GROUND WATER ELEVATION	Total Depth
SWM #1	N/A	-	-	10'
SWM #2	N/A	-	-	10'
SWM #3	Submerged Gravel Wetland	0.66'	-1'	9.4'
SWM #4	Submerged Gravel Wetland	0.66'	1.2'	10'
SWM #5	Submerged Gravel Wetland	0.66'	-1'	10'
SWM #6	Submerged Gravel Wetland	0.66'	1.5'	9.4'

TON E	ON or OFF SITE	LAND USE	DEVICE DRAINAGE AREA (acres)	IMPERVIOUS AREA DRAINING TO DEVICE (Square feet)	IMPERVIOUS ACRES RESTORED (See Note 3)	MD NORTH COORD (NAD83 - FT)	MD EAST COORD (NAD83 - FT)	WQ _v (ft3) (See Note 5)	Maintenance Responsibility	Comments
	ON	NDNR	2.5	2,616	N/A	N 408,000	E 1,439,500	207	County	

BID SET

	DEPARTMENT OF	PUBLIC WORKS	
DATE	APPROVED DATE	SCALE: 1" = 80'	DEALE COMMUNITY PARK
		DRAWN BY: R.S.S.	
	PROJECT MANAGER	CHECKED BY: R.W.H.	
DATE	APPROVED DATE	SHEET NO. 17 OF 47	STORM WATER MANAGEMENT PLAN
		PROJECT NO.: P582001	
NGINEER	CHIEF, RIGHT-OF-WAY	CONTRACT NO.: P582001	

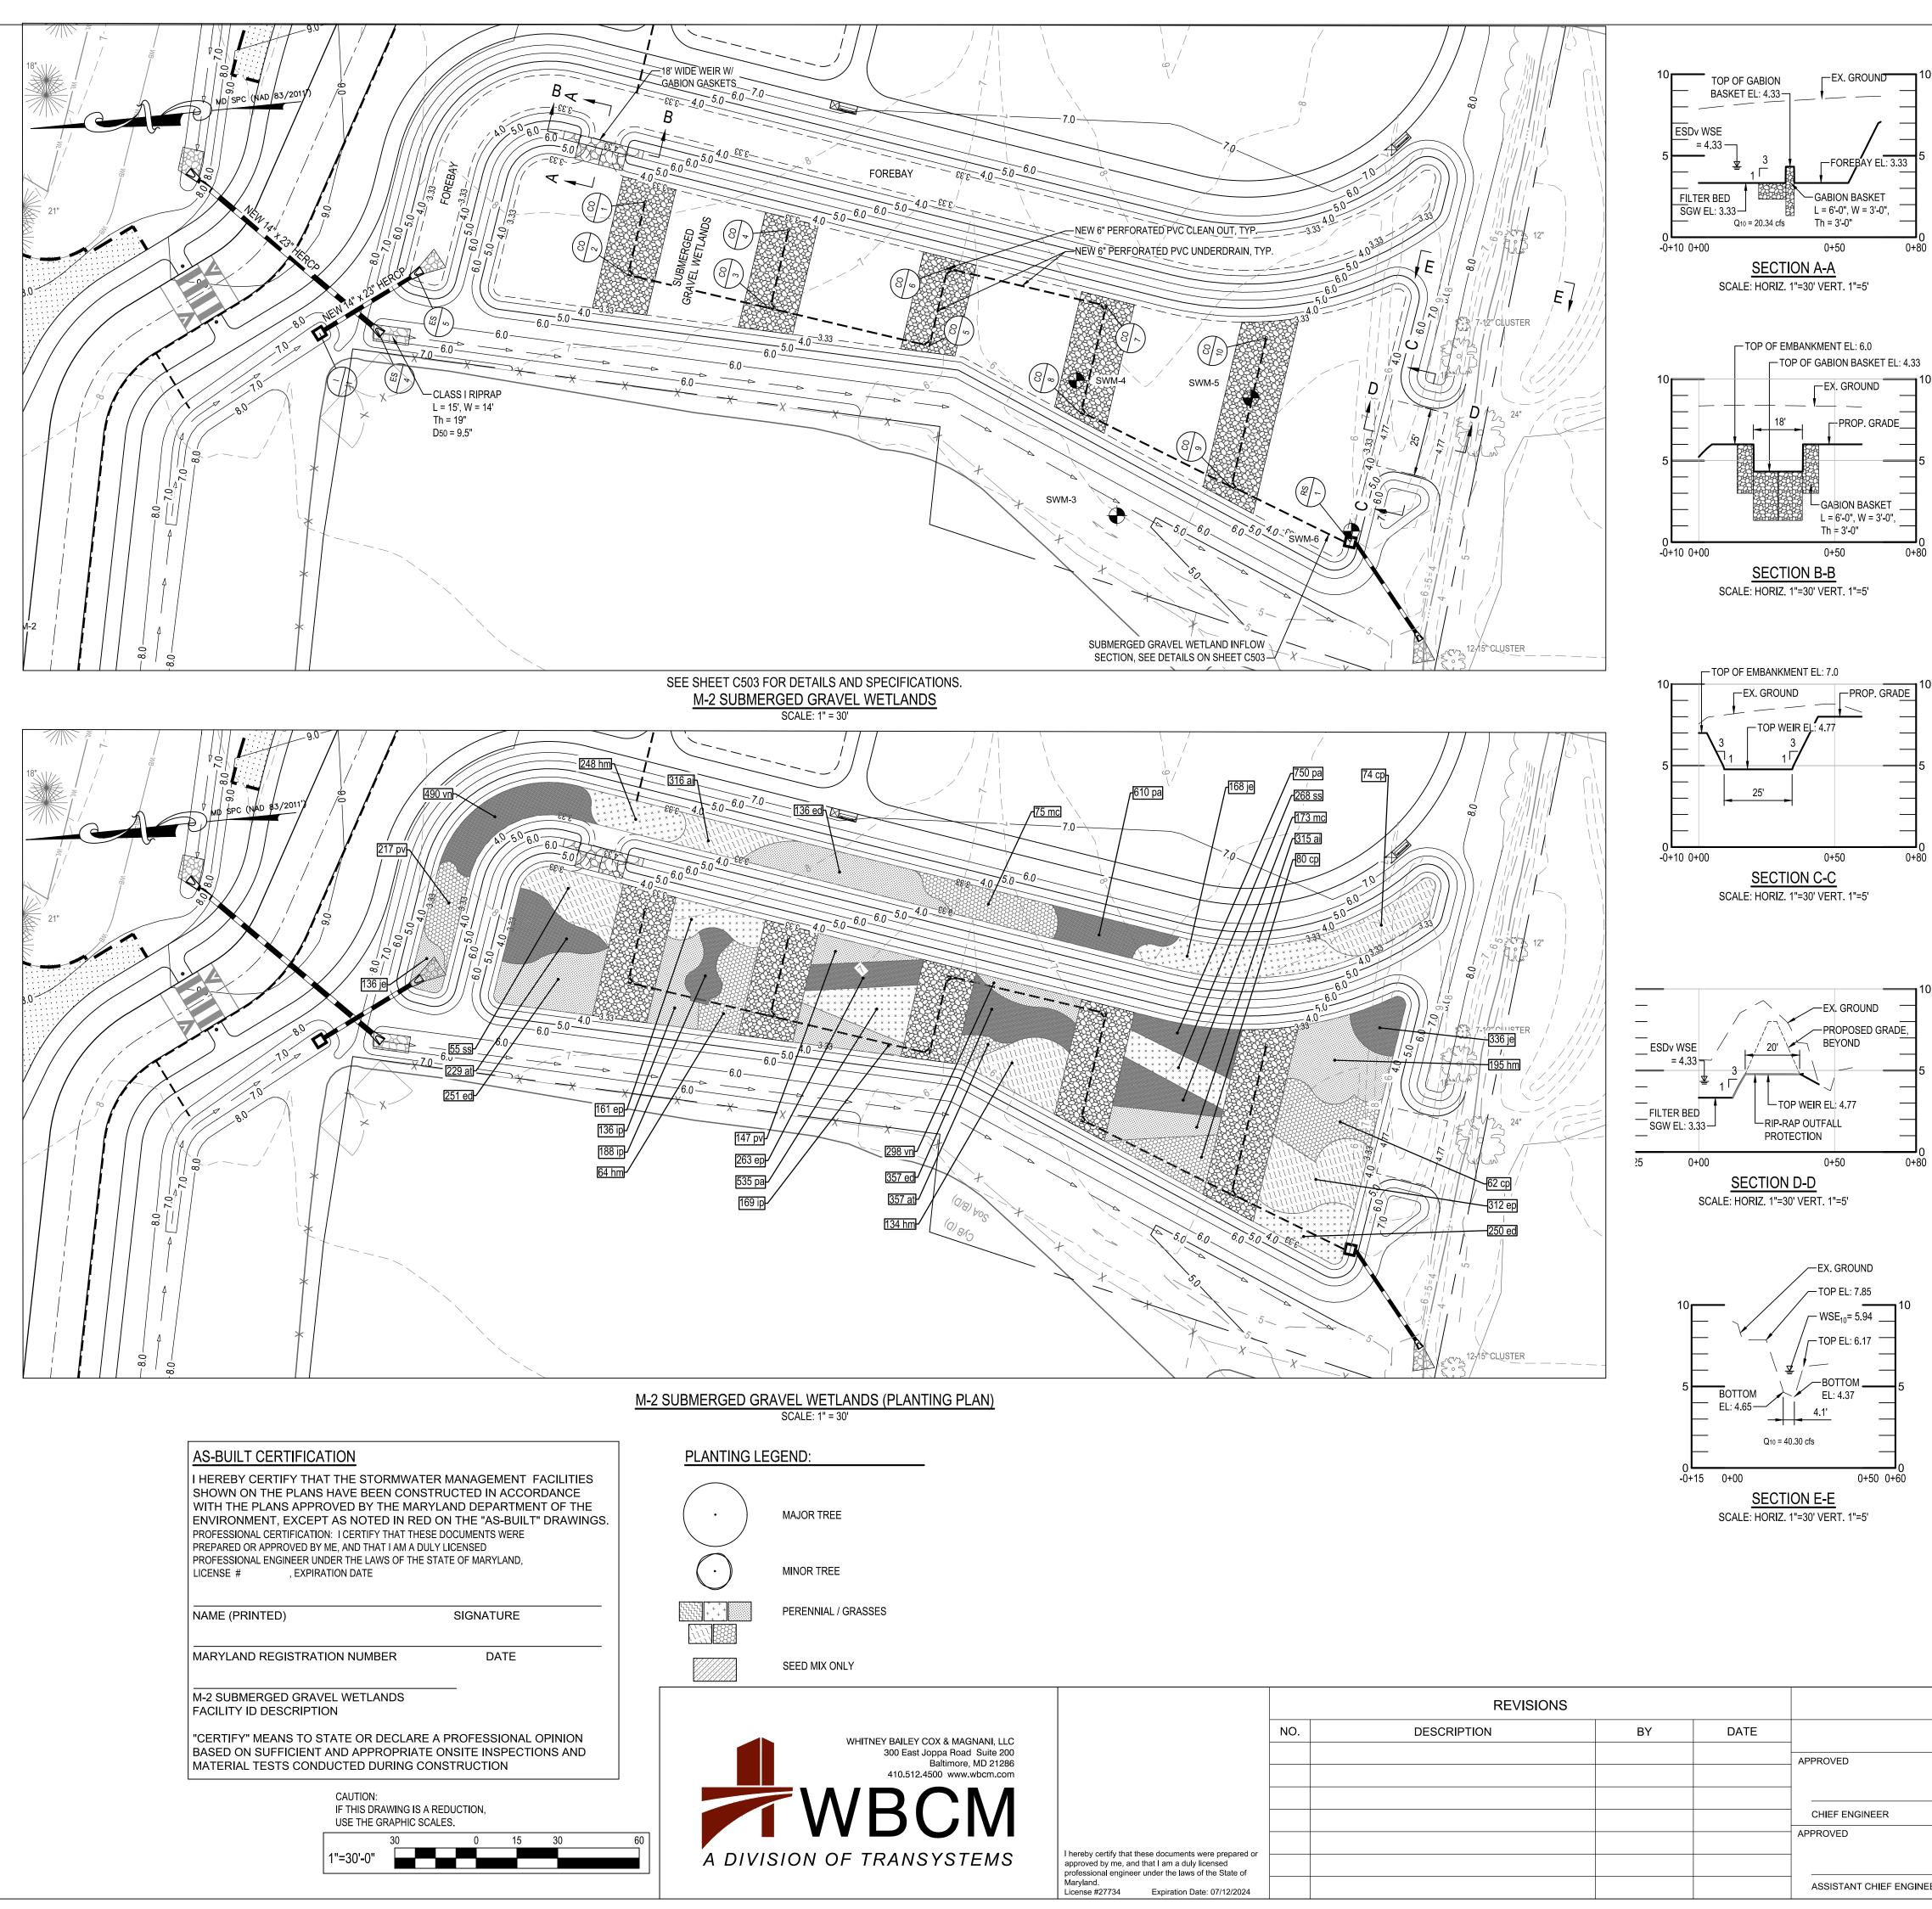

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	NO.	DESCRIPTION	BY	DATE	_
					APPROVED
					CHIEF ENGINEER
were prepared or licensed of the State of ate: 07/12/2024					ASSISTANT CHIEF ENG


PROJECT NAME: DEALE COMMUNITY PARK					
AS - BUILT	DATA FOR ESD PRACTICE	ES			
* TO BE COMPL	LETED BY THE CERTIFYING ENGINE	ER			
TYPE OF FACILITY: M-2, SUBMERGED GRAVEL WETLAND BMP ID: SUBMERGED GRAVEL WETLAND (M-2) FACILITY #1					
FEATURE	DESIGN	*AS-BUILT			
FOREBAY					
BOTTOM ELEVATION	3.33				
WEIR WIDTH / ELEVATION	20' / 4.33'				
DISTRIBUTION PIPE SIZE / INV. IN / INV. OUT	N/A				
CELLS					
BOTTOM ELEVATION OF STONE / THICKNESS	0.41' / 24"				
CHOKING STONE	3"				
TOP ELEVATION OF BSM / THICKNESS	3.33 / 8"				
WEIR WIDTH / ELEVATION	25'/ 4.80'				
DISTRIBUTION PIPE SIZE/ MATERIAL / ELEV.	6" / PVC / 0.91'				
OUTLET					
STRUCTURE / ELEVATION	RS-1 / 4.33'				
LOW FLOW PIPE SIZE/ MATERIAL / ORIFICE SIZE	6"/ PVC / 3.5"				
UNDERDRAIN INV. IN RISER	3.0'				
UNDERDRAIN INV. OUT RISER	N/A				
TOP OF EMBANKMENT	6.00				
PLANTINGS	SEE DETAILS ON THIS SHEET				
OBSERVATION WELL WITH DEPTH TO FILTER BOTTOM INDICATED ON CAP	OBS #1, (3.92')				
DATE AS-BUILT ACCEPTED BY MDE:					
TE AS-DUILT ACCEPTED BT MDE.					

Groundcovers	, Perennials and	d Grasses			
Symbol	Quantity	Botanical Name	Common Name	Size	Note
ai	631	Aesclepias incarnata	Swamp Milkweed	1 Qt.	18" O.C.
at	586	Aesclepias tuberosa	Butterfly Weed	1 Qt.	18" O.C.
ср	216	Comptonia peregrina	Sweet Fern	1 gal.	3' O.C.
ed	1022	Eupatorium dubium 'Little Joe'	Dwarf Joe Pye Weed	1 Qt.	18" O.C.
ер	736	Echinacea purpurea	Purple Coneflower	1 Qt.	18" O.C.
hm	641	Hibiscus moscheutos	Rose mallow	1 Qt.	24" O.C.
ip	505	Iris prismatica	Slender Blueflag	1 Qt.	18" O.C.
je	258	Juncus effusus	Soft Rush	1 Qt.	24" O.C.
mc	326	Muhlenbergia capillaris	Muhly Grass	1 Qt.	24" 0.C
ра	1892	Packera aurea	Golden Ragwort	1 Qt.	12" O.C.
pv	364	Panicum virgatum	Switchgrass	1 Qt.	24" O.C.
ss	1000	Schizachyrium scoparium	Little Bluestem	1 Qt.	18" O.C.
vn	788	Vernonia noveboracensis	New York Ironweed	1 Qt.	18" O.C.
Seed Mixes	100			, Gu	10 0.0.
Symbol	Quantity	Botanical Name	Common Name		Note
S1	915 s.f.	ERNMX 173	Eastern Native Habitat & CREP Mix		11 lb/ACRE
	40%	Andropgon gerardii	Big Bluestem "Niagara"		
	25%	Elymus virginius	Virginia Wildrye		
	15%	Panicum virgatum	Switchgrass		
	8%	Chamaecrista fasticulata, P.A. Ecotype	Partridge Pea		
	5%	Sorgastrum nutans	Indiangrass		
	3.9%	Echinacea purpurea	Purple Coneflower		
	3.5%	Rudbeckia hirta	Black Eyed Susan		
	0.1%	Monarda fistulosa	Wild Bergamont		
	0.178				
S2	950 s.f.	ERNMX 128	Seasonally Flooded Wildlife Food Mix		20 lb/ACRE
02	21.5%	Panicum clandestinum	Deertongue "Tigoa"		20 15// (01/(2
	20.0%	Elymus virginicus PA Ecotype	Virginia Wildrye		
	16.6%	Andropogon gerardii	Big Bluestem "Niagara"		
	15.0%	Echinochloa crusagalli var. Frumentacea	Japanese Millet		
	8.0%	Panicum virgatum	Switchgrass		
	4.0%	Chamaecrista fasticulata, PA Ecotype	Partridge Pea		
	1.5%	Verbena hastata	Blue Vervain		
	1.0%	Heliopsis helianthoides, PA Ecotype	Oxeye Sunflower		
	1.0%	Juncus effusus	Soft Rush		
	0.8%	Agrostis perennans, Albany Pine Bush Ecotype	Autumn Bentgrass		
	0.1%	Aesclepias incarnata	Swamp Milkweed		
	0.1%	Aster novae-angliae PA Ecotype	New England Aster		
		Eupatorium perfoliatum, PA Ecotype	-		
	1.1%		Boneset Wild Bergamont		
	0.1%	Monarda fistulosa Pycnanthemum tenuifolium			

Note: All seed mixes are from Ernst Conservation Seeds. www.ernstseed.com

BID SET

	DEPARTMENT OF PUBLIC WORKS						
DATE	APPROVED DATE	SCALE: 1" = 30'	DEALE COMMUNITY PARK				
		DRAWN BY: R.S.S.					
	PROJECT MANAGER	CHECKED BY: R.W.H.					
DATE	APPROVED DATE	SHEET NO. 18 OF 47	STORM WATER MANAGEMENT PART PLAN				
		PROJECT NO.: P582001					
GINEER	CHIEF, RIGHT-OF-WAY	CONTRACT NO.: P582001					
	•	•	•				

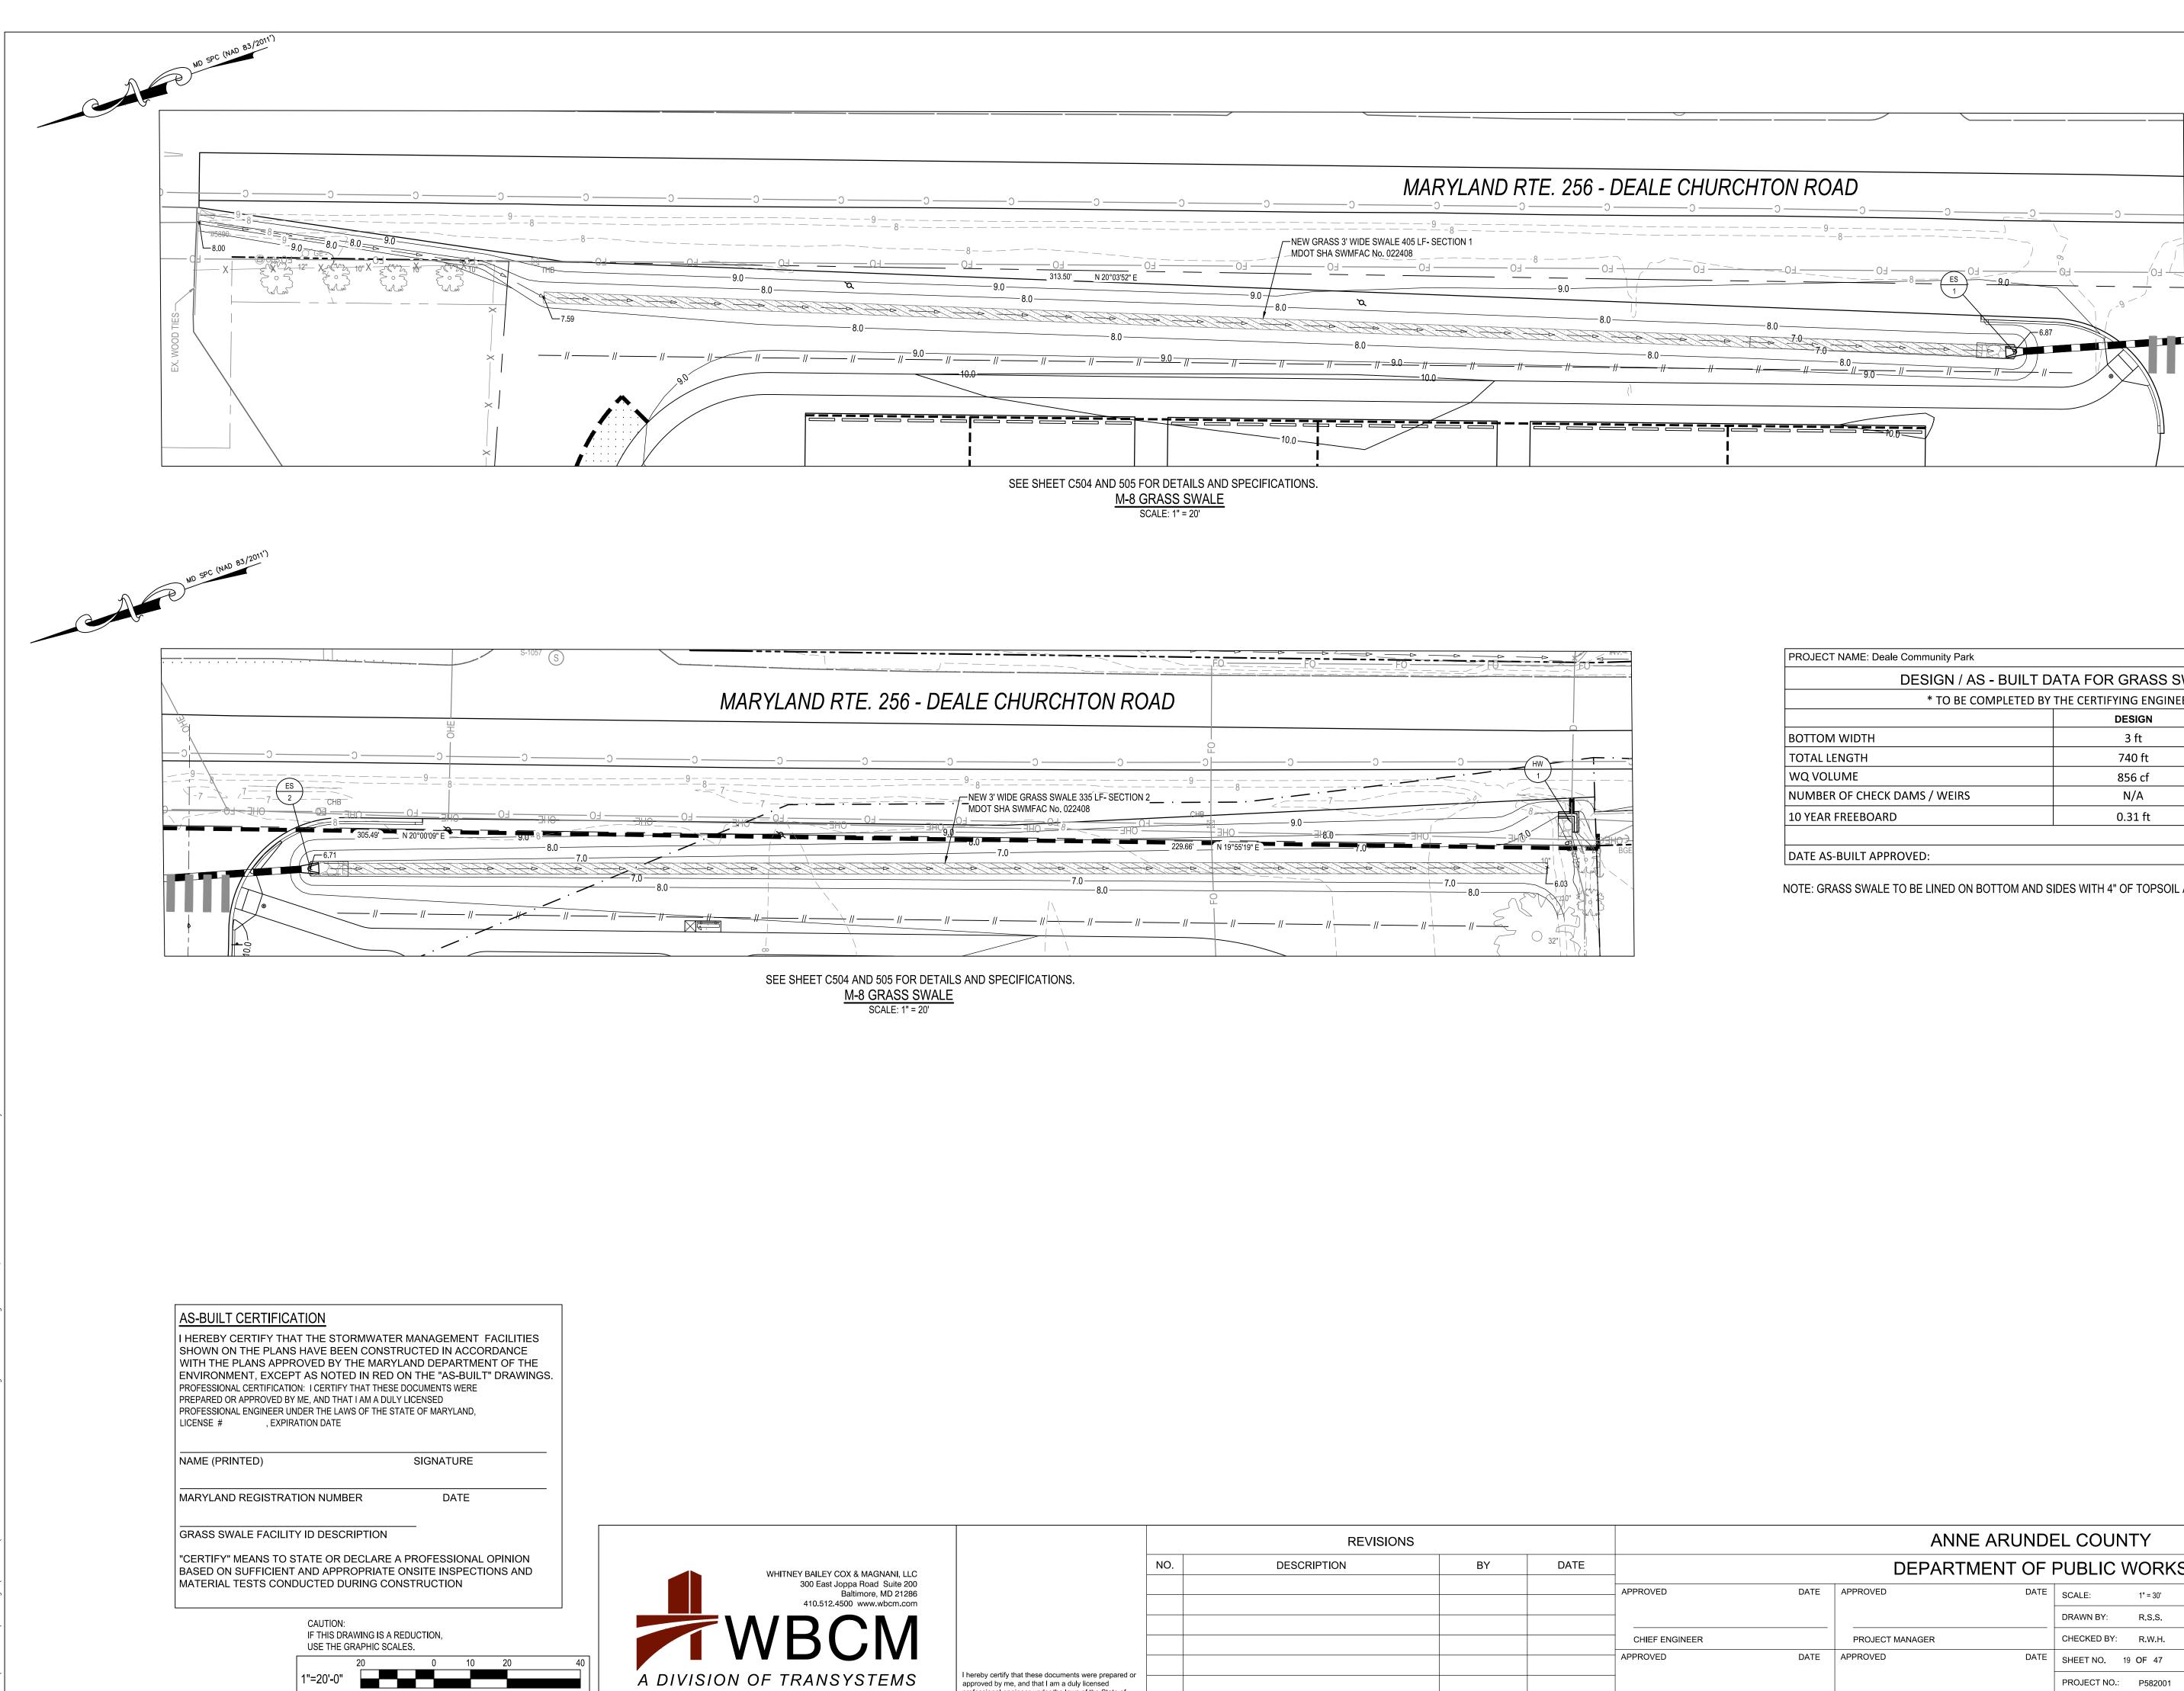


			REVISIONS				
LEY COX & MAGNANI, LLC		NO.	DESCRIPTION	BY	DATE		
ast Joppa Road Suite 200 Baltimore, MD 21286 512.4500 www.wbcm.com						APPROVED	
						CHIEF ENGINEER	
						APPROVED	
VSYSTEMS	I hereby certify that these documents were prepared or approved by me, and that I am a duly licensed professional engineer under the laws of the State of					_	
	Maryland. License #27734 Expiration Date: 07/12/2024					ASSISTANT CHIEF ENG	

DESIGN / AS - BUILT	T DATA FOR GRASS SWA	
	BY THE CERTIFYING ENGINEER	<u></u>
	DESIGN	*AS-BUILT
BOTTOM WIDTH	3 ft	
TOTAL LENGTH	740 ft	
WQ VOLUME	856 cf	
NUMBER OF CHECK DAMS / WEIRS	N/A	
10 YEAR FREEBOARD	0.31 ft	

NOTE: GRASS SWALE TO BE LINED ON BOTTOM AND SIDES WITH 4" OF TOPSOIL AND SOD INSTALLED AT COMPLETION.

BID SET

DEPARTMENT OF PUBLIC WORKS						
DATE	APPROVED DATE	SCALE: 1" = 30'	DEALE COMMUNITY PARK			
		DRAWN BY: R.S.S.				
	PROJECT MANAGER	CHECKED BY: R.W.H.				
DATE	APPROVED DATE	SHEET NO. 19 OF 47	STORM WATER MANAGEMENT PART PLAN			
		PROJECT NO.: P582001				
IGINEER	CHIEF, RIGHT-OF-WAY	CONTRACT NO.: P582001				

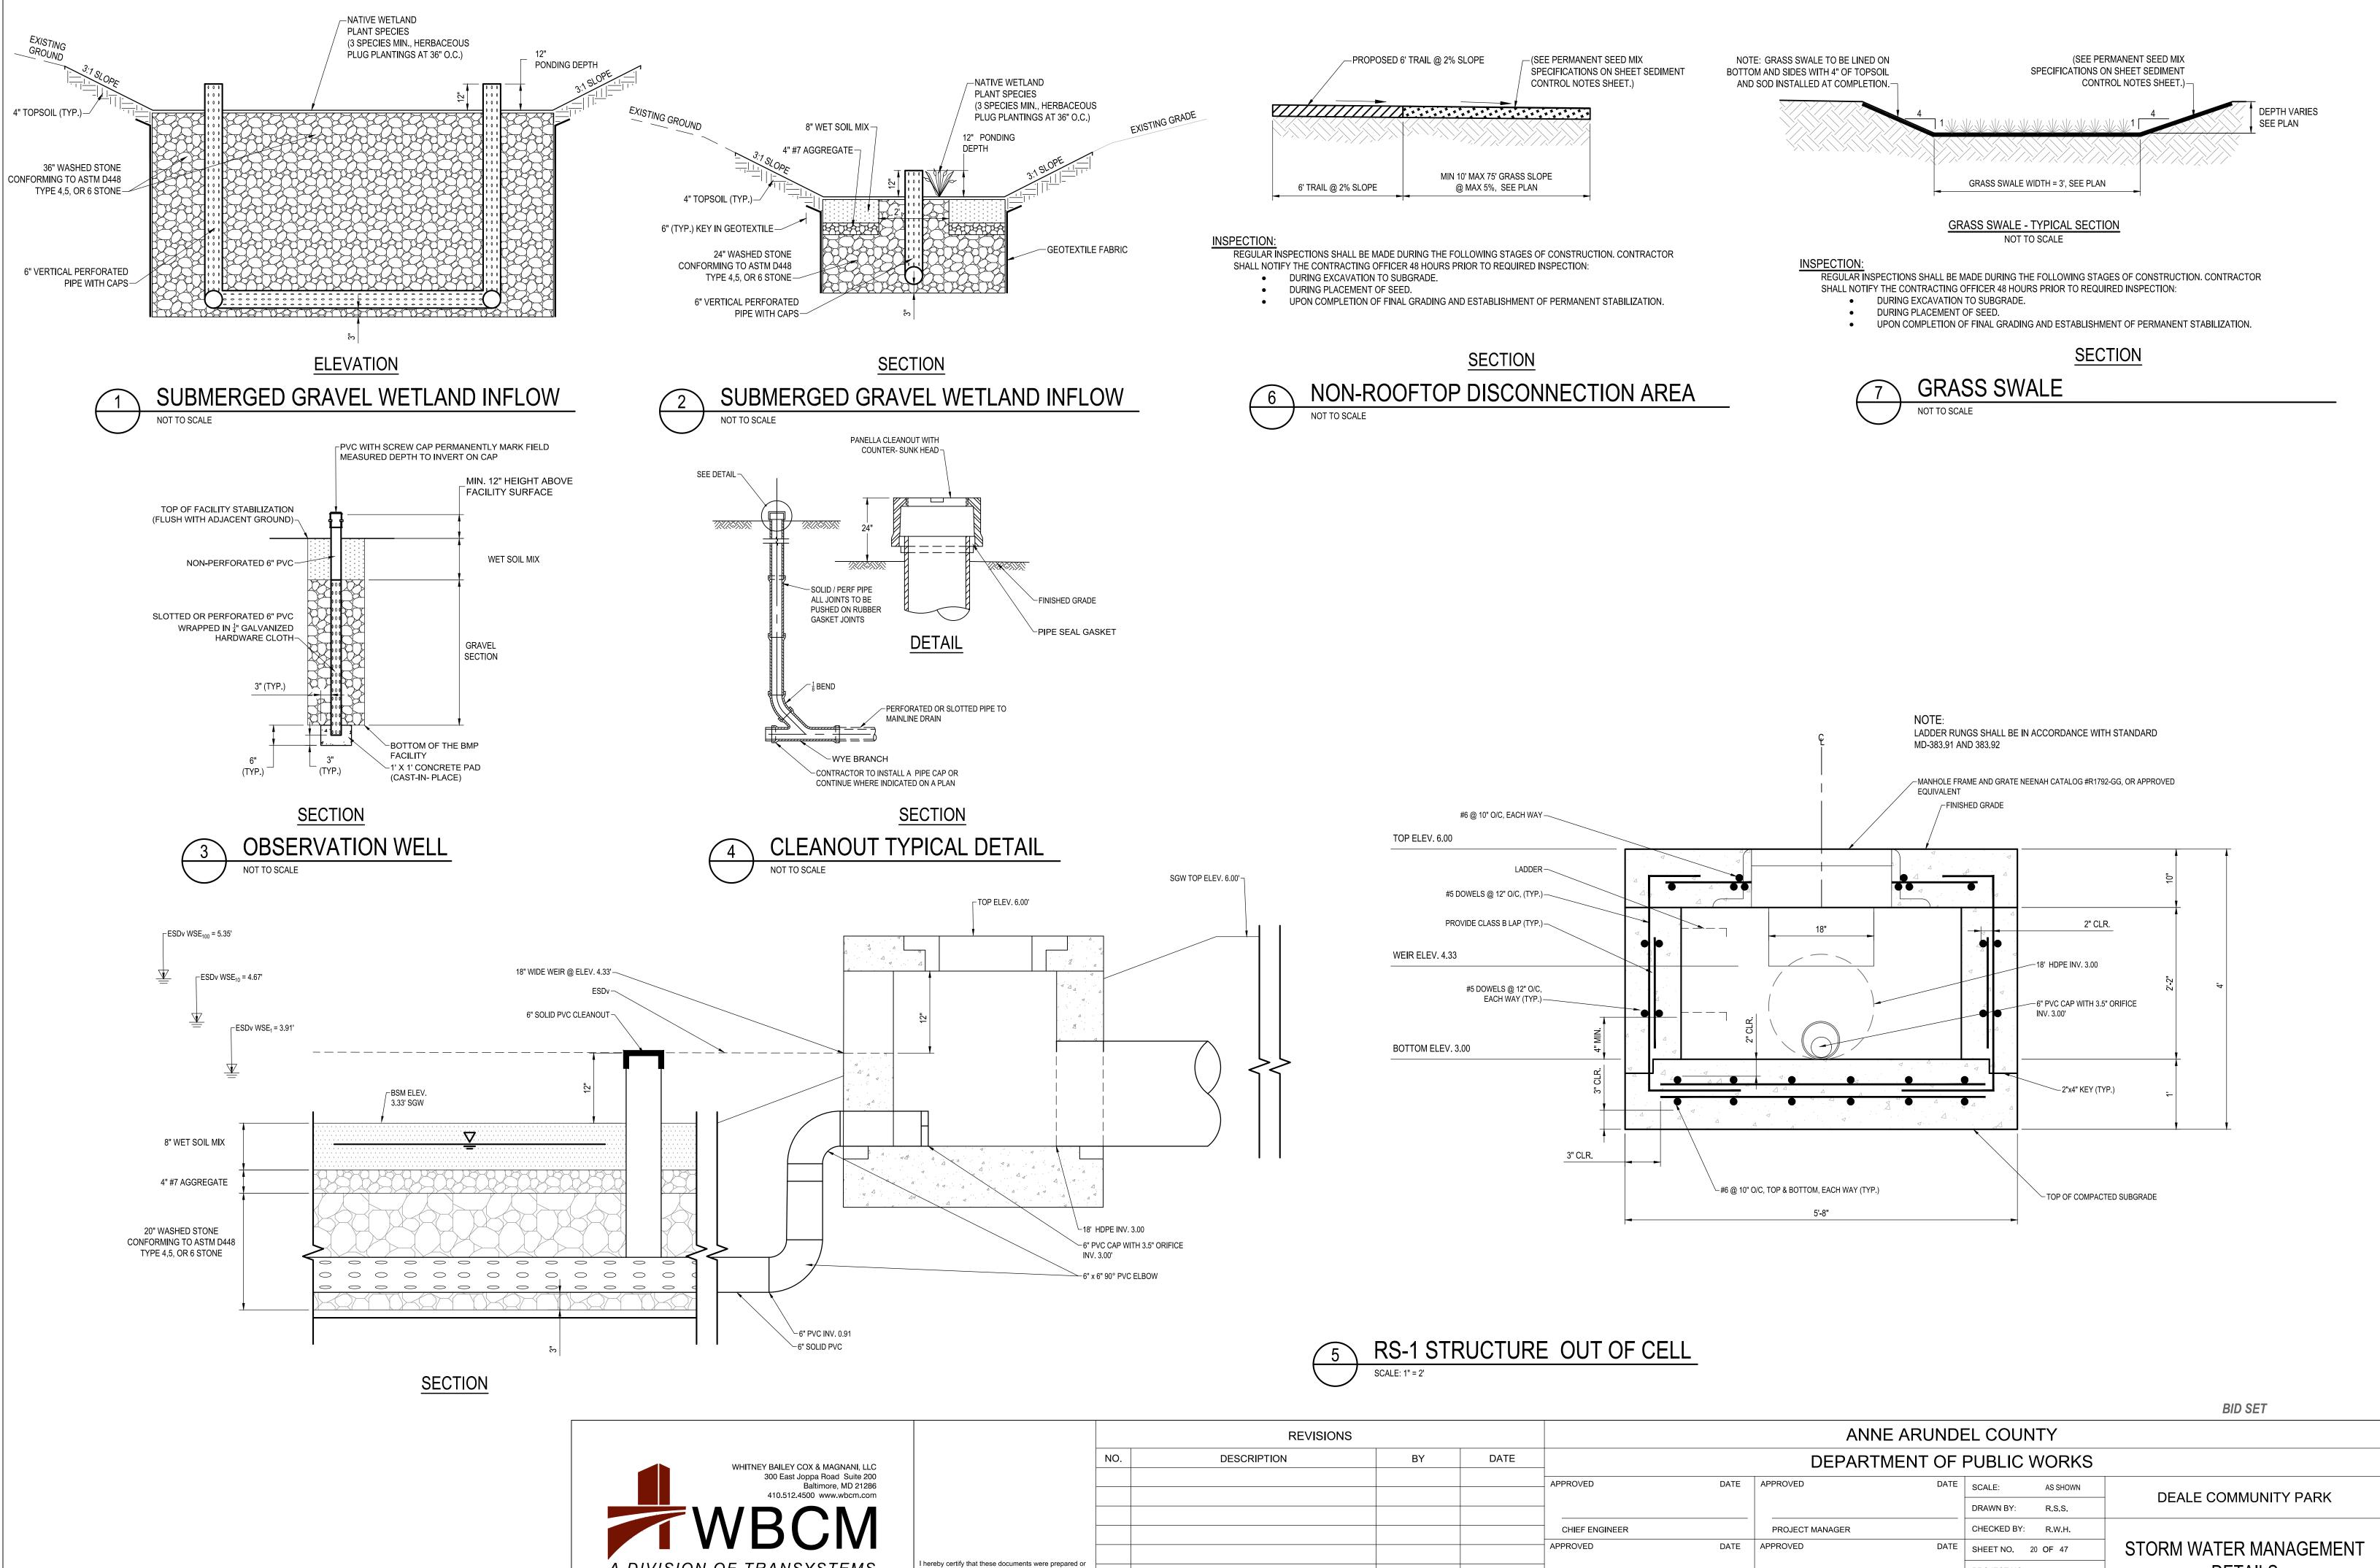

A DIVISION OF TRANSYSTEMS

approved by me, and that I am a duly licensed professional engineer under the laws of the State of . Maryland. Expiration Date: 07/12/2024 _icense #27734

ASSISTANT CHIEF ENGINEER

CHIEF, RIGHT-OF-WAY

PROJECT NO.: P582001 CONTRACT NO.: P582001

DETAILS

SEQUENCE OF CONSTRUCTION FOR SUBMERGED GRAVEL WETLANDS (M-2) SWM FACILITY

- 2. EXCAVATE FOREBAY, INSTALL GABION WEIR AND OVERFLOW.
- 3. STABILIZE FOREBAY.
- 4. INSTALL FOREBAY PLANTINGS AS INDICATED ON PLANS. 5. DEWATER SEDIMENT BASIN AND EXCAVATE FACILITY.
- 6. PLACE LINER MATERIAL AS INDICATED ON THE PLANS.
- 7. PLACE STONE IN THE FACILITY AS INDICATED ON THE PLANS. CLEANOUTS MUST BE EXTEND A MINIMUM TWO FEET ABOVE FINISHED GRADE AND BE FURNISHED WITH CAPS THAT CAN BE REMOVED WHEN AND AS NEEDED FOR INSPECTIONS, MAINTENANCE, AND TO CHECK ON WATER LEVELS. STONE IS TO BE WASHED AND SHALL NOT INCLUDE FINE MATERIAL. 8. PLACE WETLAND SOIL AS INDICATED ON THE PLANS.
- 9. INSTALL PLANTINGS AS INDICATED ON THE PLANS.

SUBMERGED GRAVEL WETLANDS (M-2) INSPECTION, & MAINTENANCE NOTES

INSPECTION:

REGULAR INSPECTIONS SHALL BE MADE DURING THE FOLLOWING STAGES OF CONSTRUCTION:

- DURING EXCAVATION TO SUBGRADE.
- DURING PLACEMENT OF BACKFILL OF PERFORATED INLET PIPE AND OBSERVATION WELLS.
- DURING PLACEMENT OF GEOTEXTILES AND ALL FILTER MEDIA. DURING CONSTRUCTION OF ANY APPURTENANT CONVEYANCE SYSTEMS SUCH AS DIVERSION STRUCTURES, INLETS, OUTLETS, AND FLOW DISTRIBUTION STRUCTURES.
- UPON COMPLETION OF FINAL GRADING AND ESTABLISHMENT OF PERMANENT STABILIZATION, AND BEFORE ALLOWING RUNOFF TO ENTER THE WETLAND.

MAINTENANCE CRITERIA:

THE FOLLOWING ITEMS SHOULD BE ADDRESSED TO ENSURE PROPER MAINTENANCE AND LONG-TERM PERFORMANCE OF SUBMERGED

- GRAVEL WETLANDS:
- PRIVATELY OWNED PRACTICES SHALL HAVE A MAINTENANCE PLAN AND BE PROTECTED BY EASEMENT, DEED RESTORATION, ORDINANCE OR OTHER LEGAL MEASURES PREVENTING ITS NEGLECT, ADVERSE ALTERATION, AND REMOVAL.
- DURING THE FIRST YEAR OF OPERATION, INSPECTIONS SHOULD BE CONDUCTED AFTER EVERY MAJOR STORM AND POORLY ESTABLISHED AREAS REVEGETATED.
- SEDIMENT ACCUMULATION IN THE PRETREATMENT AREAS SHOULD BE REMOVED AS NECESSARY.
- SIGNS OF UNEVEN LOW DISTRIBUTION WITHIN THE WETLAND MAY MEAN THAT THE GRAVEL OF UNDERDRAIN IS CLOGGED. THE GRAVEL
- AND/OR UNDERDRAIN MAY NEED TO BE REMOVED, CLEANED, AND REPLACED. • A DENSE STAND OF WETLAND VEGETATION SHOULD BE MAINTAINED THROUGH THE LIFE OF THE FACILITY WITH PLANTINGS REPLACED AS NEEDED.
- INLETS AND OUTLETS TO EACH SUBMERGED GRAVEL WETLAND CELL SHOULD BE FREE FROM DEBRIS TO PREVENT CLOGGING.
- EROSION AT INFLOW POINTS SHOULD BE REPAIRED. FLOW SPLITTERS SHOULD BE FUNCTIONAL TO PREVENT BYPASSING OF THE

FACILITY.

CONSTRUCTION CRITERIA:

THE FOLLOWING ITEMS SHOULD BE ADDRESSED DURING THE CONSTRUCTION OF PROJECTS WITH SUBMERGED GRAVEL WETLANDS. SITE DISTURBANCE

ALL ONSITE DISTURBED AREAS SHOULD BE STABILIZED PRIOR TO ALLOWING RUNOFF TO ENTER THE NEWLY CONSTRUCTED WETLAND. EROSION AND SEDIMENT CONTROL:

THE PROPOSED LOCATION OF A SUBMERGED GRAVEL WETLAND SHALL BE PROTECTED DURING CONSTRUCTION. SURFACE RUNOFF SHALL BE DIVERTED AWAY FROM THE PRACTICE DURING GRADING OPERATIONS. FLOW SPLITTERS AND OTHER CONVEYANCE INFRASTRUCTURE SHALL BE BLOCKED.

GRAVEL MEDIA

THE AGGREGATE SHALL BE COMPOSED OF AN 18 TO 48 INCH LAYER OF CLEAN WASHED, UNIFORMLY GRADED MATERIAL WITH POROSITY OF 40%. (ASTM D488 #57 / AASHTO M-43 STONE OR EQUAL).

STORMWATER MAINTENANCE SCHEDULE **GRASS SWALE**

MONTHLY INSPECTION

	MONTHLY INSPEC	CTION	
Inspection Item	Inspection Requirements	Remedial Action	
Debris and Trash	Check for trash and/or debris.	Dispose of trash and debris in an acceptable manner.	
Grass Cover Grass in swale must be maintained at a height of 4 to 6 inches. Check for channelizing and bare spots.		Mow during the growing season to maintain the require height. Clippings must be removed. Re-plant with topsoil, seed, and matting.	
	SEASONAL INSPECTION AND AFT	ER A MAJOR STORM	
Inspection Item	Inspection Requirements	Remedial Action	
Sediment Accumulation	Check for accumulated sediment.	When sediment accumulates to 2 inches in depth, remove sediment and dispose of in an acceptable location.	
Erosion	Check inflow, channel, outfall, and side slopes for evidence of erosion, rills, gullies, and runoff channelization.	Re-plant with topsoil, seed, and matting. Re-grading may be required when concentrated runoff causes rills or gullying to the facility. Grade, vegetate, and/or armor to provide stable conveyance in accordance with approved plans.	
	ANNUAL INSPEC	ΓΙΟΝ	
Inspection Item	Inspection Requirements	Remedial Action	
Maintenance Access	Check for accessibility to facility.	Prevent excessive vegetative growth, erosion, and obstructions on access way.	
Overall Function of Facility	Check that flow conveyance is operating as designed	Repair to good condition according to specifications on the approved plans.	

SPECIFICATIONS: 1. SEE CHART BELOW.

INATE	RIALS SPECIFICATIONS F		ERGED GRAVEL WEILANDS
MATERIAL	SPECIFICATION	SIZE	NOTES
PLANTINGS	SEE PLAN SHEET	N/A	PLANTINGS ARE SITE SPECIFIC
BSM	SHA BIORETENTION SOIL MIX (BSM) SECTION 920.01.05 ORGANIC CONTENT	N/A	MARYLAND STATE HIGHWAY ADMINISTRATION STANDARDS SPECIFICATIONS FOR CONSTRUCTION AND MATERIALS DATED MAY 2017 INCLUDING AND ADDENDA THERETO. COPY TO BE KEPT ON-SITE
	MIN. 5% BY DRY WEIGHT (ASTM D 2974)		
MULCH	SHREDDED HARDWOOD		AGED 6 MONTHS, MINIMUM; NO PINE OR WOOD CHIPS
LINER MATERIAL		N/A	NONWOVEN SE GEOTEXTILE TABLE H.1 2011 MARYLAND STANDARDS AND SPECIFICATIONS FOR SOIL EROSION AND SEDIMENT CONTROL
GRAVEL	AASHTO M-43	NO.57, 6, OR 67 (3/8" TO 3/4")	
UNDERDRAIN PIPING	F 758, TYPE PS 28 AASHTO M-278 AASHTO M-252	4" TO 6"	SLOTTED OR PERFORATED PIPE; SLOTTED PIPE SHALL HAVE A MINIMUM OPEN AREA OF 1.5 SQ.IN. / LINEAR FOOT WITH A MAXIMUM SLOT LENGTH OF 2" AND MAXIMUM SLOT WIDTH OF 1/8 INCH. PERFORATED PIPE SHALL BE WRAPPED WITH 1/4 INCH GALVANIZED HARDWARE CLOTH.
STABILIZATION MATTING	PERMANENT STABILIZATION MATTING NORTH AMERICAN GREEN ERONET CN125 OR APPROVED EQUAL		AS NOTED ON PLAN / SECTION / DETAILS

MAINTENANCE SCHEDULE: ANNE ARUNDEL COUNTY.

STORMWATER	R MAINTENANCE	SCHEDULE SUBMERGE	O GRAVEL WETLANDS
INSPECTION ITEM	FREQUENCY OF INSPECTION	INSPECTION REQUIREMENTS	REMEDIAL ACTION
GRAVEL WETLAND CELLS	SEASONALLY AND AFTER A MAJOR STORM		
VEGETATION	SEASONALLY AND AFTER A MAJOR STORM	FACILITY MUST DEWATER WITHIN 48 HOURS OF RAINFALL. NOTICEABLE ODORS, STAINED WATER ON THE FILTER SURFACE OR AT THE OUTLET, OR THE PRESENCE OF ALGAE OR AQUATIC VEGETATION ARE INDICATORS OF ANAEROBIC CONDITIONS, AND INADEQUATE DEWATERING OF THE FACILITY.	THE TOP THREE INCHES OF SOIL SHOULD BE REMOVED AND REPLACED WITH SOIL MATERIAL AS PER PLAN SPECIFICATIONS. FOLLOW UP INSPECTIONS MUST CONFIRM ADEQUATE DEWATERING. IF THE FACILITY DOES NOT FUNCTION AS INTENDED AFTER THE ABOVE ACTION, THE ENTIRE FILTER AND UNDERDRAIN SYSTEM MAY NEED MAINTENANCE. MDE APPROVAL MAY BE NECESSARY.
MULCH LAYER	SEASONALLY AND AFTER A MAJOR STORM	CHECK MULCH FOR ADEQUATE COVER, SEDIMENT ACCUMULATION, OR DISCOLORATION.	REPLACE AND REMOVE OLD MULCH AND EXCESS SEDIMENTS. PROVIDE ADEQUATE MULCH COVER ACCORDING TO APPROVED DESIGN.
VEGETATIVE SURFACES	MONTHLY		
PLANT COMPOSITION AND HEALTH	MONTHLY	COMPARE PLANT COMPOSITION WITH APPROVED PLANS. CHECK FOR INVASIVE SPECIES OR WEEDS. CHECK FOR DEAD OR DYING VEGETATION.	REMOVE AND REPLACE PLANTS IN ACCORDANCE WITH PLAN SPECIFICATIONS.
VEGETATIVE COVER AND EROSION	MONTHLY	CHECK FOR EVIDENCE OF EROSION, RUNOFF CHANNELIZING, OR BARE SPOTS.	RE-SEED OR RE-PLANT IN ACCORDANCE WITH APPROVED LANDSCAPING PLANS. RE-GRADING MAY BE REQUIRED WHEN CONCENTRATED FLOW CAUSES RILLS OR GULLYING THROUGH THE FACILITY.
DEBRIS AND TRASH CLEANOUT	MONTHLY	CHECK THAT THE FACILITY IS CLEAN OF TRASH AND DEBRIS. INLETS, OUTLETS, AND CONTRIBUTING AREAS AROUND THE FACILITY MUST BE CHECKED.	TRASH AND DEBRIS MUST BE DISPOSED OF IN AN ACCEPTABLE MANNER ACCORDING TO CURRENT REGULATIONS.
STRUCTURAL COMPONENTS	ANNUALLY	CHECK FOR EVIDENCE OF STRUCTURAL DETERIORATION, SPALLING, OR CRACKING. INLET AND OUTLET STRUCTURES MUST BE IN GOOD CONDITION.	REPAIR TO GOOD CONDITION ACCORDING TO SPECIFICATIONS ON THE APPROVED PLANS.
OUTLETS		CHECK FOR EVIDENCE OF EROSION, RILLS, OR GULLYING.	STABILIZE ALL ERODED AREAS AND GRADE TO PROVIDE STABLE CONVEYANCE.
	SEASONALLY AND AFTER A MAJOR STORM	RIPRAP OUTLET MUST BE MAINTAINED IN GOOD FUNCTIONAL CONDITION.	REPAIR ACCORDING TO APPROVED PLAN.
PRETREATMENT			
SEDIMENT ACCUMULATION	SEASONALLY AND AFTER A MAJOR STORM	CHECK FOR SEDIMENT ACCUMULATION.	WHEN SEDIMENT ACCUMULATIONS TO A DEPTH OF ONE HALF THE DESIGN PONDING DEPTH OR COVERS MORE THAN, SEDIMENT MUST BE REMOVED AND THE FACILITY RESTORED ACCORDING TO THE APPROVED DESIGN.
GRASS CHANNEL CONVEYANCE SYSTEMS		CHECK FOR EROSION, FLOW BLOCKAGES, AND STABLE CONVEYANCE.	STABILIZE AND GRADE ACCORDING TO APPROVED PLAN.
OVERALL FUNCTION OF THE FACILITY	ANNUALLY	CHECK THAT FLOW SPLITTERS ARE FUNCTIONING AS DESIGNED AND THAT BYPASS IS OPERATING AS DESIGNED.	CONSTRUCTION MUST BE IN ACCORDANCE WITH APPROVED PLANS.

	WHITNEY BAILEY COX & MAGNANI, LLC 300 East Joppa Road Suite 200 Baltimore, MD 21286 410.512.4500 www.wbcm.com
	WBCM
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2. THE CONTRACTOR SHALL SUBMIT SOIL TEST RESULTS (1 PER 30 CY TOPSOIL) TO THE ENGINEER FOR REVIEW AND APPROVAL PRIOR TO INSTALLATION. PERFORM SOIL TESTS REQUIRED FOR BOTH IMPORTED SOIL AND RE-USED / AMENDED TOP SOIL. SOIL TEST AND RESULTS SHALL INCLUDE AT A MINIMUM; PHOSPHORUS, ORGANIC MATTER, SOLUBLE SALTS, NUTRIENTS, AND TEXTURAL ANALYSIS. 3. PLANT MATERIAL SHALL BE REPRESENTATIVE OF SPECIES AND CONFORM TO THE AMERICAN STANDARD FOR NURSERY STOCK, ANSI Z60.1-2004.

MATERIALS SPECIFICATIONS FOR SUBMERGED GRAVEL WETLANDS

AFTER CONSTRUCTION COMPLETION AND ACCEPTANCE OF THE WORK, INSPECTION AND MAINTENANCE SHALL BE THE RESPONSIBILITY OF

ENANCE	ENANCE SCHEDULE SUBMERGED GRAVEL WEILANDS					
ENCY OF	INSPECTION	REMEDIAL ACTION				
ECTION	DEOLIDEMENTS					

	NO.	DESCRIPTION	BY	DATE	
					APPROVED CHIEF ENGINEER APPROVED
e prepared or nsed e State of 07/12/2024					ASSISTANT CHIEF ENGI

I hereby certify that these documents were p approved by me, and that I am a duly licens professional engineer under the laws of the Maryland License #27734 Expiration Date: 0

BID SET

PARTMEN	T OF F	VUBLIC	WORKS

DEPARTMENT OF PUBLIC WORKS						
DATE	APPROVED DATE	SCALE: AS SHOWN	DEALE COMMUNITY PARK			
		DRAWN BY: R.S.S.				
	PROJECT MANAGER	CHECKED BY: R.W.H.				
DATE	APPROVED DATE	SHEET NO. 21 OF 47	STORM WATER MANAGEMENT			
		PROJECT NO.: P582001	DETAILS			
GINEER	CHIEF, RIGHT-OF-WAY	CONTRACT NO.: P582001				
GINEER	CHIEF, RIGHT-OF-WAY	CONTRACT NO.: P582001				



EX.MÀCADAM

MIMOSA COVE

#5907 EX. BUILDING

/ #5913 EX. BUILDING

#5915 EX. DWELLING

_\^I #5921 [⊨] ĖX. DWELLING

RO

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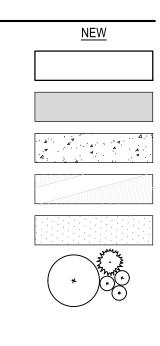
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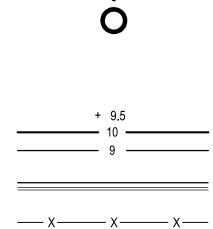
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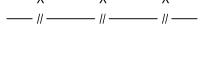
КШ

DESCRIPTION	EXISTING
BUILDING	EX. BLDG
BITUMINOUS CONCRETE PAVING	EX. MACADAM
PORTLAND CEMENT CONCRETE	EX. CONC.
BITUMINOUS CONCRETE MILL & OVERLAY	EX. MACADAM
BITUMINOUS CONCRETE PEDESTRIAN WALK	
	₩ <u>12</u> " \$ 6" (~) 3"

DECIDUOUS / EVERGREEN TREES	3" " 2 12" E 6" () 3"
CLEAN OUT	© c.o.
DRAIN INLET	Ē
ELECTRIC MH	
FIRE HYDRANT	GV.
GAS VALVE	GV
HAND BOX	⊠н.в.
INLET MH	0
UTILITY POLE	<u>,0</u>
SANITARY MH	S
SIGN (ONE-POST)	
STORM DRAIN MH	D
STREET LIGHT	¢.
TRAVERSE STATION	<u>∧</u> 900
BOLLARD	\odot
WATER VALVE	\bowtie
SPOT ELEVATION	+ 9.5
MAJOR CONTOUR	10
MINOR CONTOUR	9 9
WALL	
CONC. CURB	
SURVEY LIMITS	
CHAIN LINK FENCE LINE	— X—— X—— X—
SPLIT RAIL FENCE LINE	
O/H ELECTRIC	OHE
U/G FIBER OPTIC	FO
U/G GAS	G
U/G SANITARY	SS
U/G STORM	D
UG WATER	W
U/G COMMUNICATION	C
PROPERTY LINE	
RIGHT OF WAY	
SOIL BORING	SWM#
LIMIT OF DISTURBANCE	SoA (B/D)







AREA SF AREA ACRES LEGEND AREA DESCRIPTION TOTAL PROPERTY AREA (SF) 524,224 12.03 PORTION OF PROPERTY WITHIN CRITICAL AREA (LDA) 421,833 9.68 PORTION OF PROPERTY OUTSIDE CRITICAL AREA 102,391 $\langle \times \times \times \rangle$ 2.35 EXISTING ROADS TO REMAIN (SF) 4,215 0.10 PROPOSED VEHICULAR PAVING (SF) 23,273 0.53 PROPOSED PEDESTRIAN PAVING (SF) 26,698 0.61 PROPOSED PLAYGROUND AREA 9,000 0.21 LOT COVERAGE AREA (SF) 63,186 1.45 LOT COVERAGE PERCENTAGE 15% CRITICAL AREA WOODLAND COVERAGE 65,758 1.5 0% 0 EXISTING WOODLAND CLEARING * NO PROPOSED CLEARING OF WOODS ON THIS PLAN

SrA (B/D)


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ANNE ARUNDEL COUNTY

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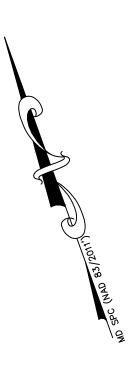
SOIL LINES

DEPARTMENT OF PUBLIC WORKS							
DATE	APPROVED DATE	SCALE: 1" = 60'	DEALE COMMUNITY PARK				
		DRAWN BY: R.S.S.					
	PROJECT MANAGER	CHECKED BY: R.W.H.					
DATE	APPROVED DATE	SHEET NO. 22 OF 47	CRITICAL AREA PLAN				
		PROJECT NO.: P582001					
GINEER	CHIEF, RIGHT-OF-WAY	CONTRACT NO.: P582001					





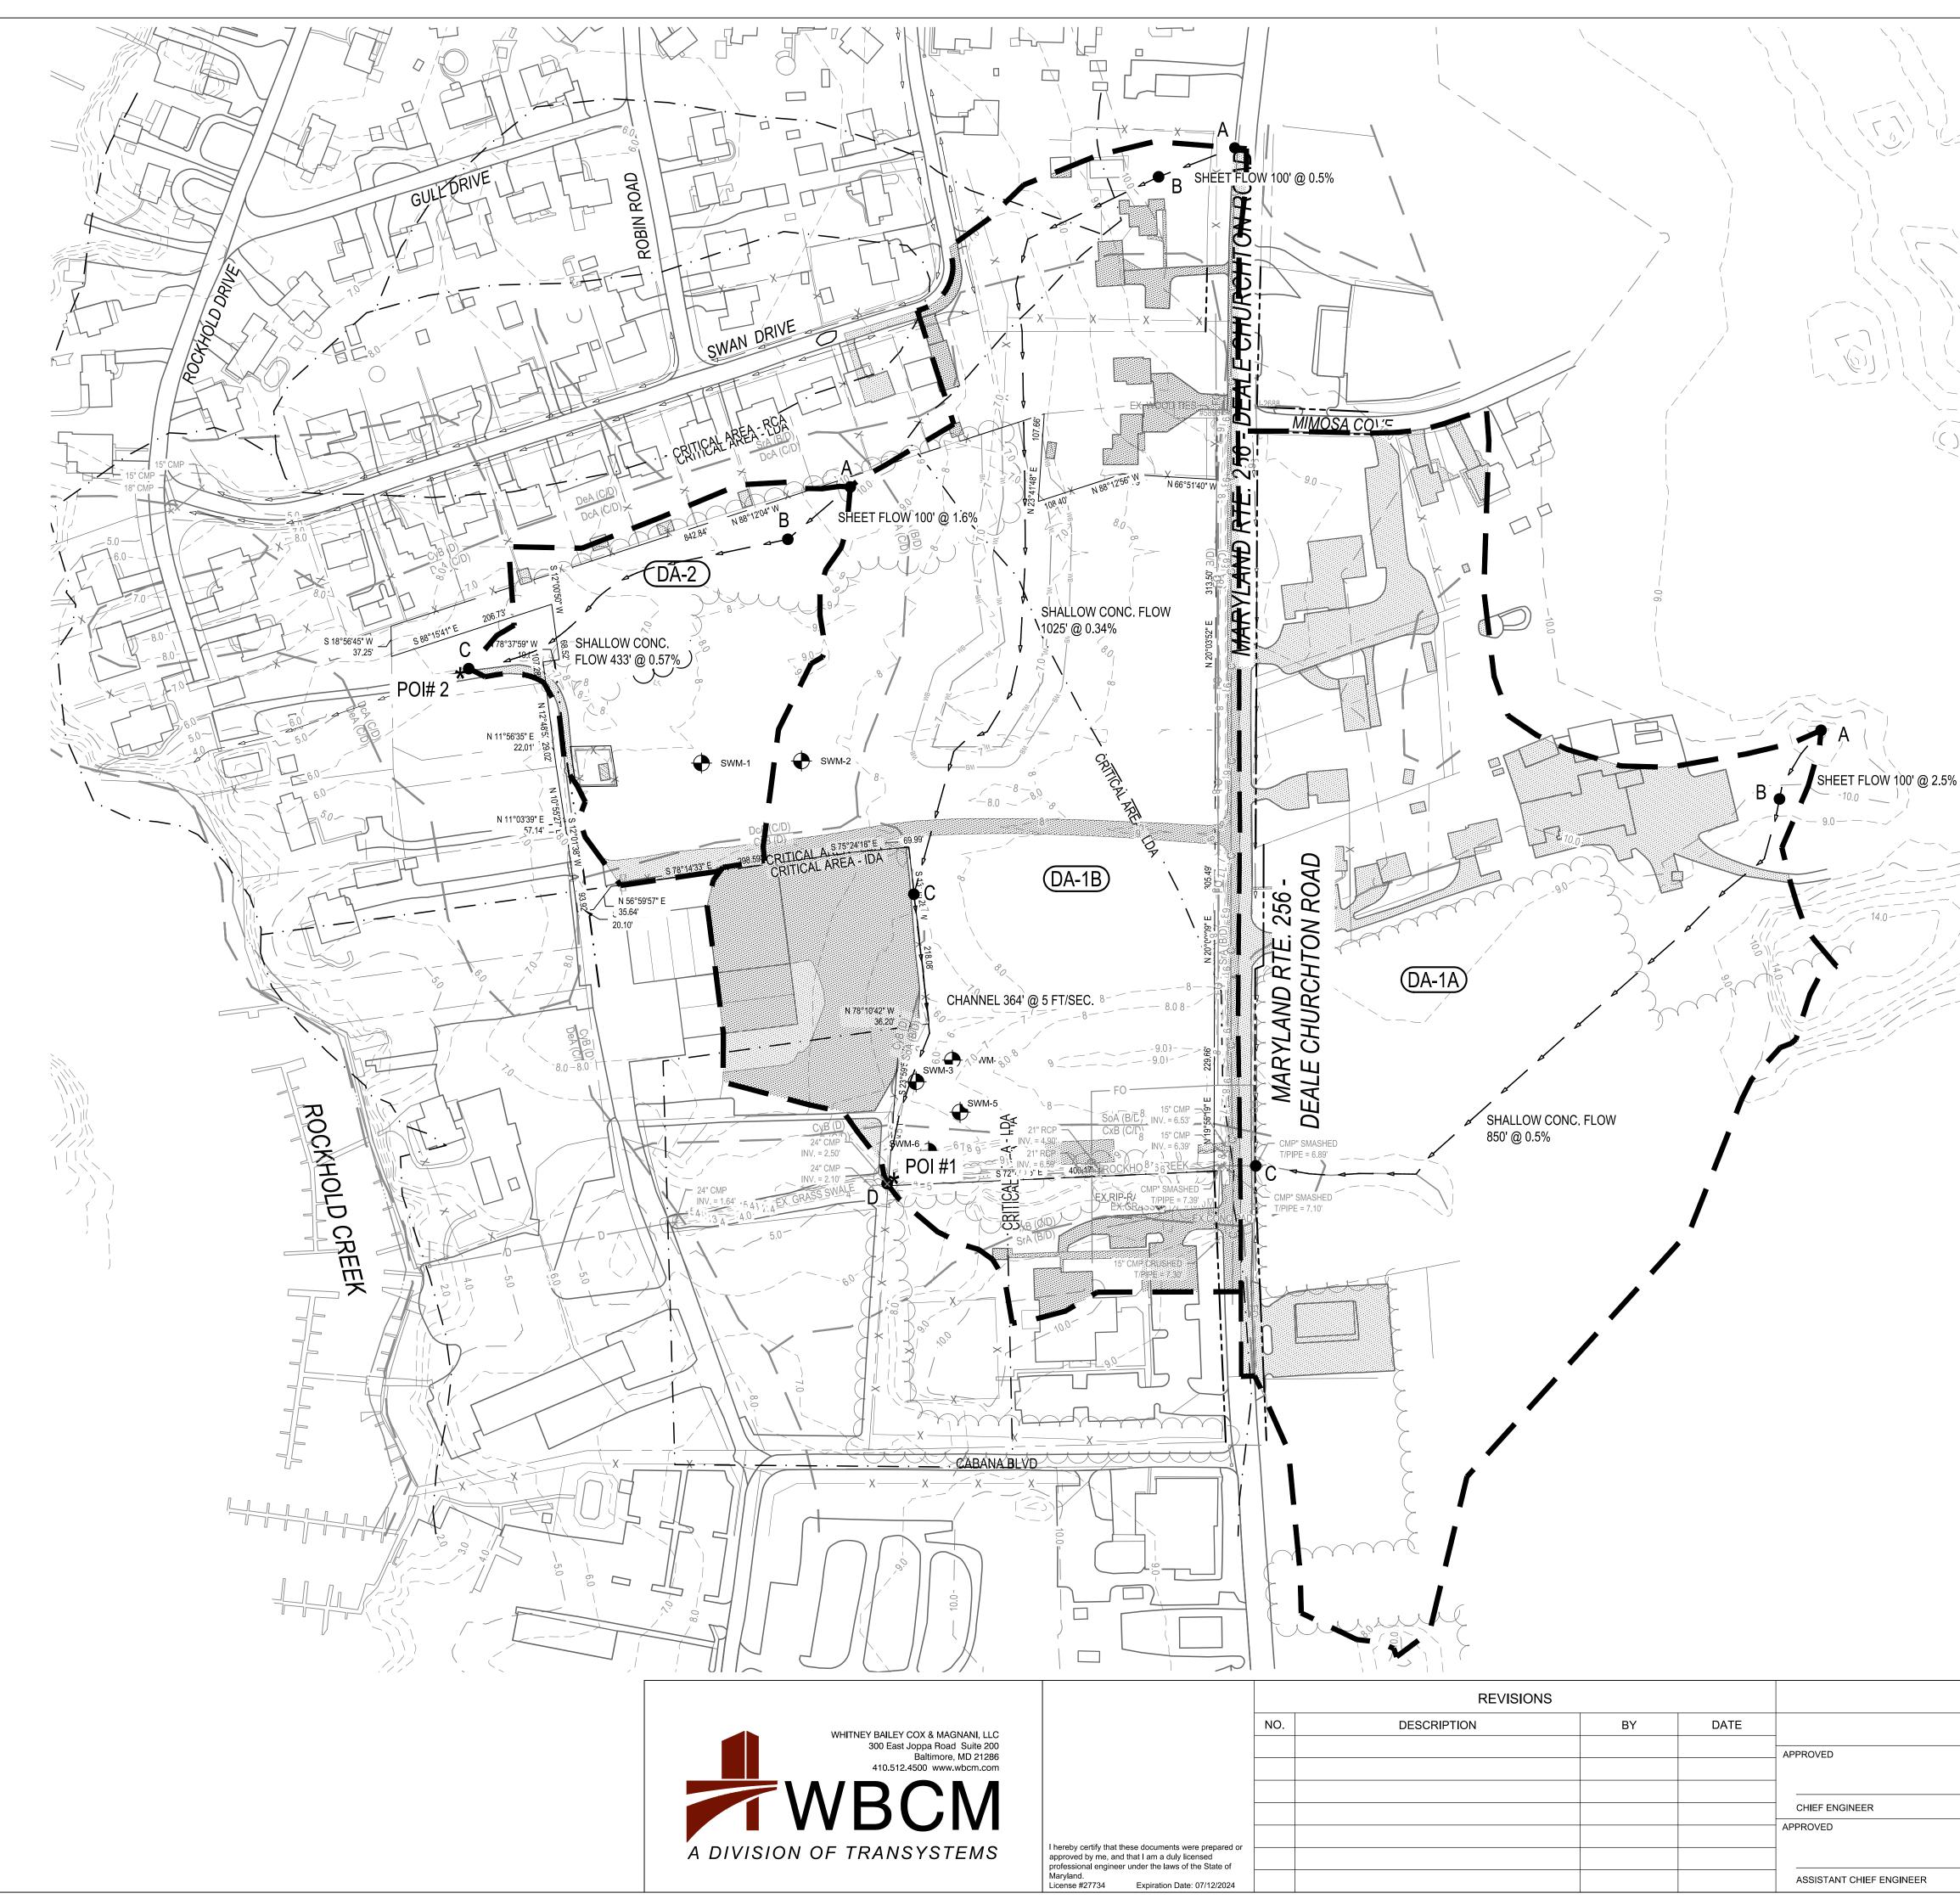












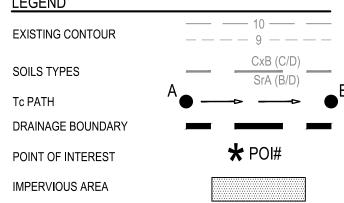

Existing	DA-1A	Open Sparse	Woods	Impervi	CN	Tc (min.)	Q10
		Space		ous			(cfs)
Sq.ft.	660,612	238,541	304,467	117,604	82	25.5	34.5
Acres	15.17	5.48	6.99	2.70			
Existing	DA-1B	Open	Woods	Impervi	CN	Tc (min.)	Q10
		Space		ous			(cfs)
Sq.ft.	655,259	497,928	25,546	131,785	84	48	25.86
Acres	15.04	11.43	0.59	3.03			
Existing	DA-2	Open	Woods	Impervi	CN	Tc (min.)	Q10
		Space		ous			(cfs)
Sq.ft.	139,929	78,663	52,614	8,652	80	21.5	7.48
Acres	3.21	1.81	1.21	0.20			

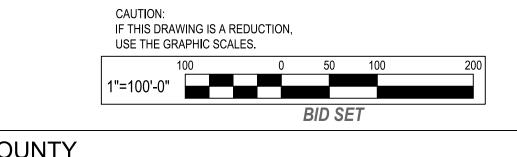

DEPARTMENT OF PUBLIC WORKS						
DATE	APPROVED DATE	DEALE COMMUNITY PARK				
		DRAWN BY: R.S.S.				
	PROJECT MANAGER	CHECKED BY: R.W.H.				
DATE	APPROVED DATE	SHEET NO. 23 OF 47	EXISTING DRAINAGE AREA MAP			
		PROJECT NO.: P582001				
NGINEER	CHIEF, RIGHT-OF-WAY	CONTRACT NO.: P582001				

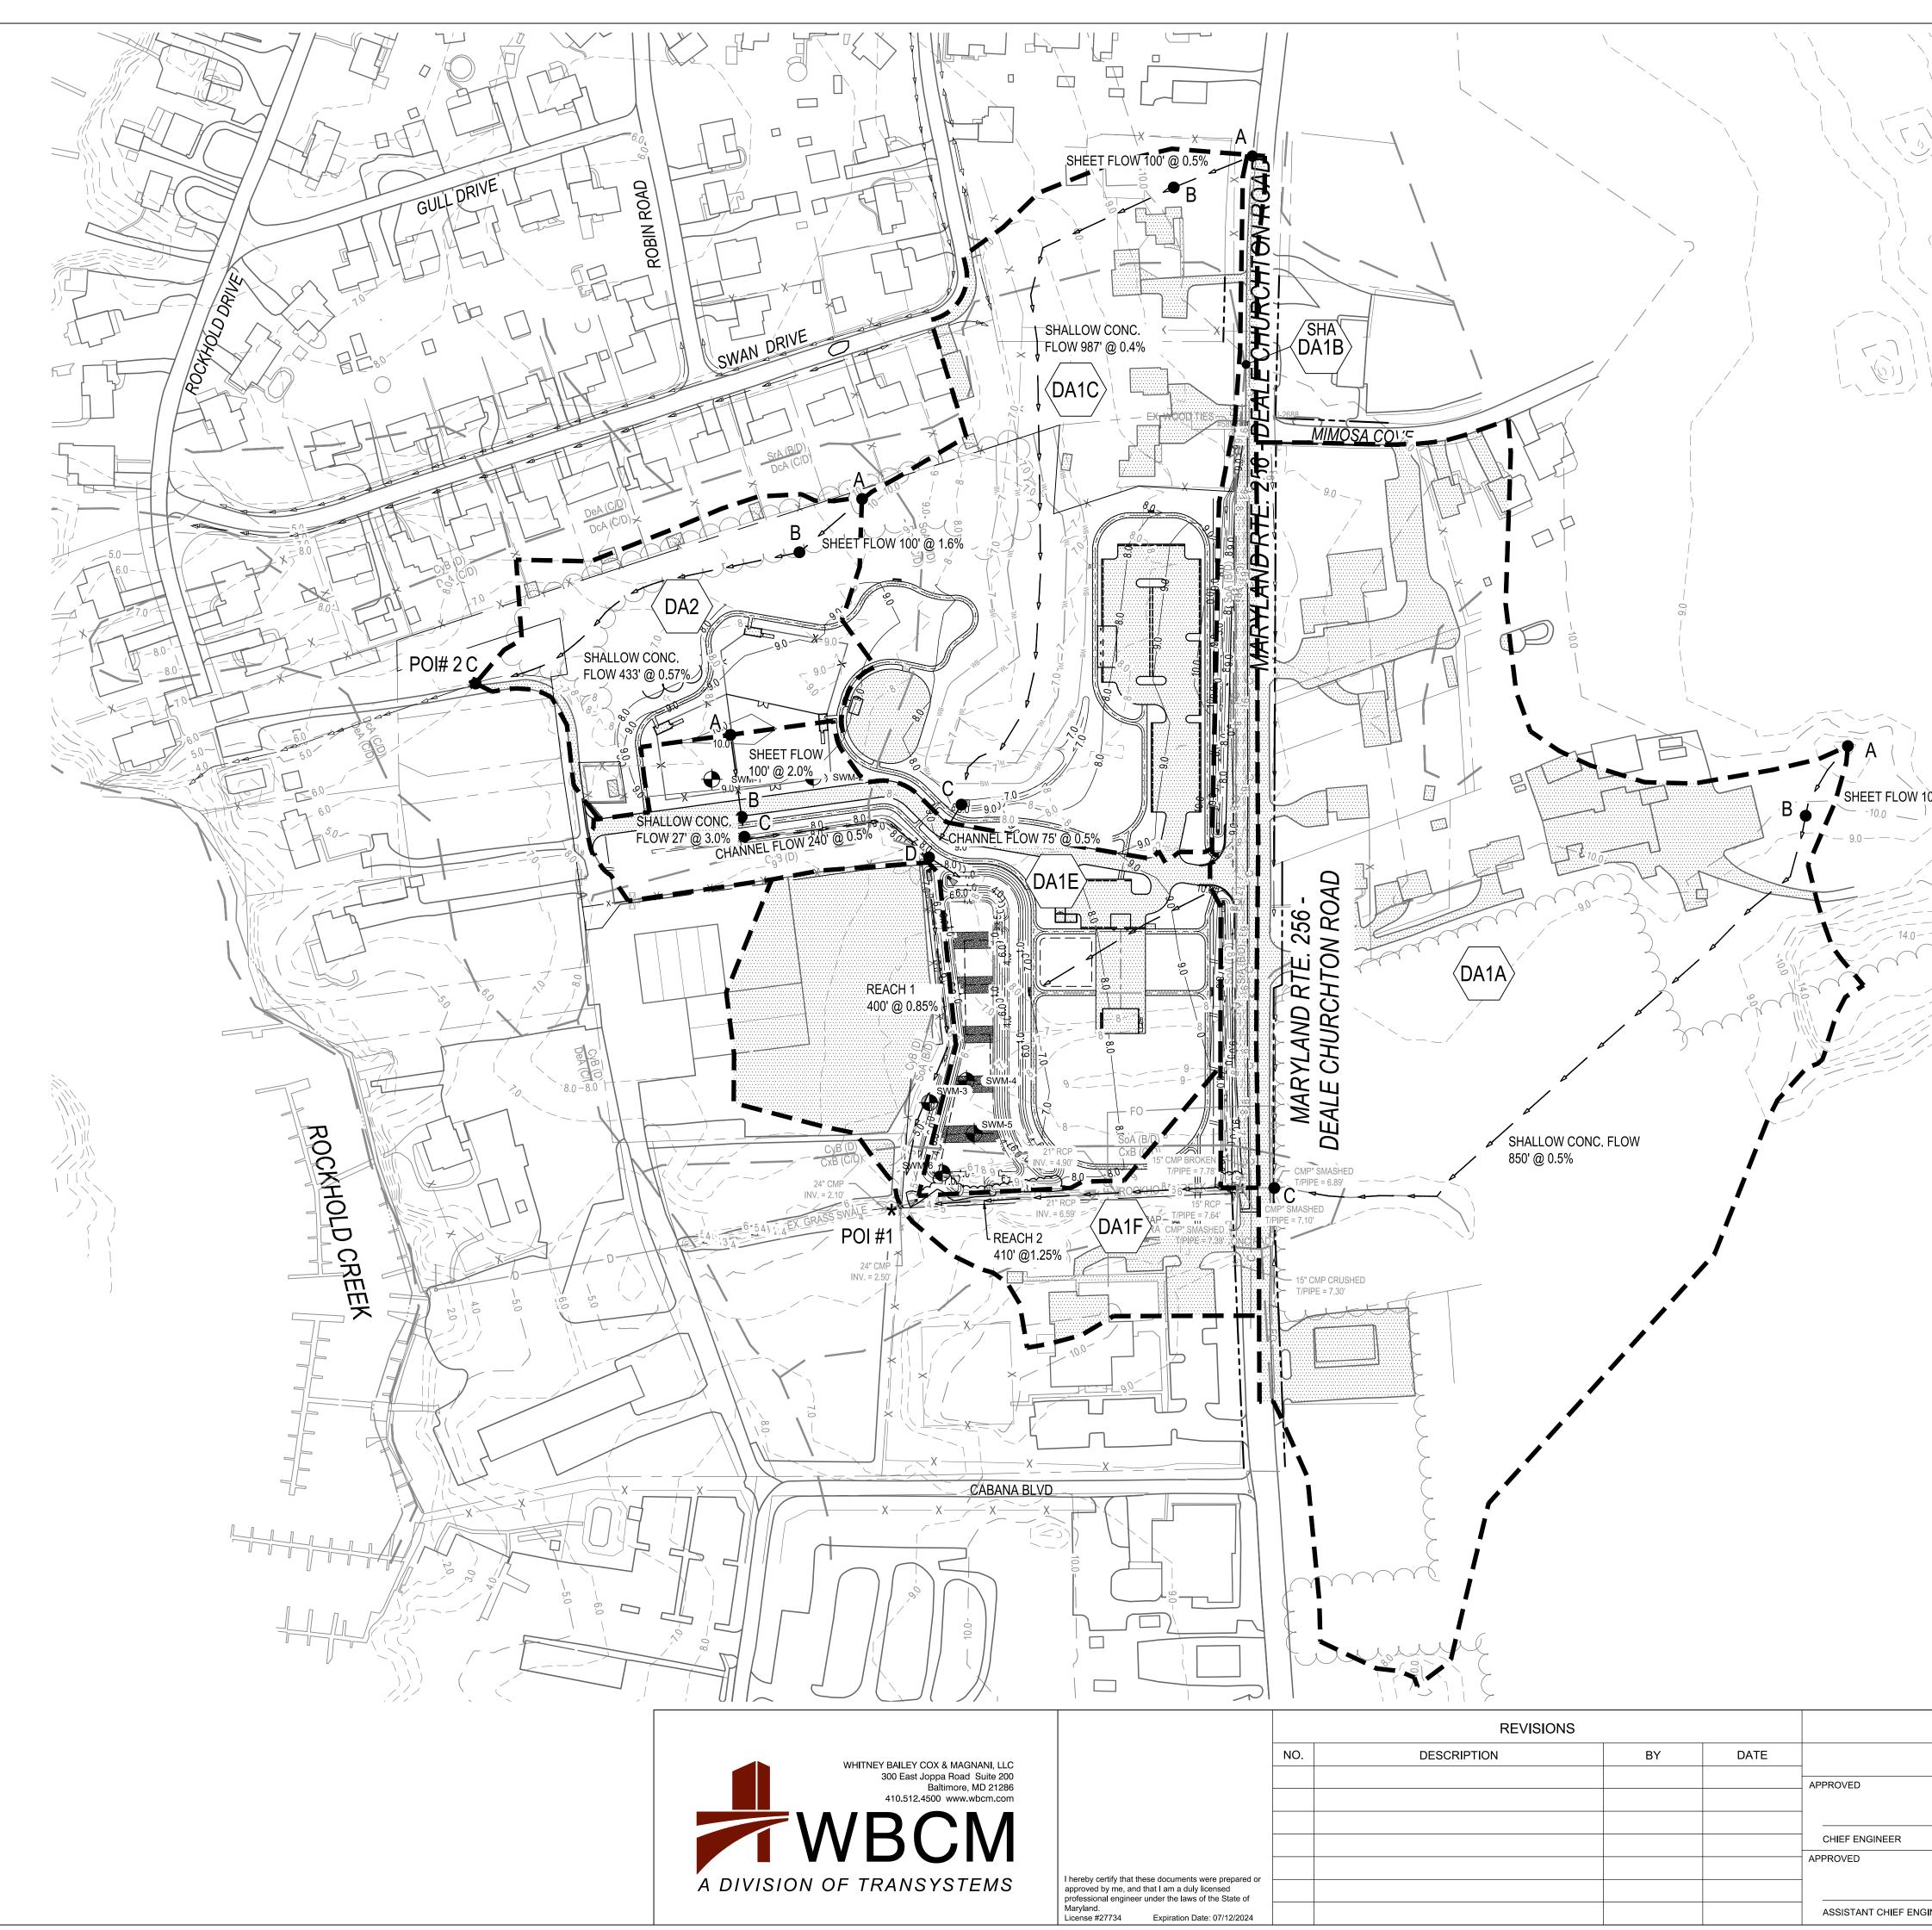









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Dranac		Onon	Maada	Imponio	CN		010
Propos	DA-1A	Open	Woods	Impervio	CN	Tc (min.)	Q10
ed		Space		US			(cfs)
Sq.ft.	660,612	238,541	304,467	117,604	82	25.5	34.5
Acres	15.17	5.48	6.99	2.70			
0	DA 40	0		· · ·	DCN		010
Propos	DA-1B	Open	Woods	Impervio	RCN	Tc (min.)	Q10
ed	SHA	Space		US			(cfs)
Sq.ft.	50,545	26,395	0	24,150	87	5	5.18
Acres	1.16	0.61	0.00	0.55			
Propos	DA-1C	Open	Woods	Impervio	CN	Tc (min.)	Q10
ed		Space		US			(cfs)
Sq.ft.	303,435	223,744	15,595	64,096	84	41.7	12.97
Acres	6.97	5.14	0.36	1.47			
Propos	DA-1E	Open	Woods	Impervio	CN	Tc (min.)	Q10
ed		Space		US			(cfs)
Sq.ft.	186,777	121,320	0	65,457	86	5	18.71
Acres	4.29	2.79	0.00	1.50			

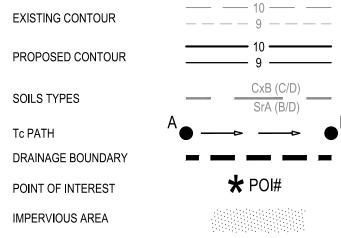

DEPARTMENT OF PUBLIC WORKS						
DATE	APPROVED DATE	SCALE: 1" = 100'	DEALE COMMUNITY PARK			
		DRAWN BY: R.S.S.				
	PROJECT MANAGER	CHECKED BY: R.W.H.				
DATE	APPROVED DATE	SHEET NO. 24 OF 47	PROPOSED DRAINAGE AREA MAP			
		PROJECT NO.: P582001				
IGINEER	CHIEF, RIGHT-OF-WAY	CONTRACT NO.: P582001				

 \square SWAN DRIVE ROCKHOLD -⊙S-2116 5 EX.MACADAM EX.MADADAM ROCKHOLD EX.GRAVEL S-10695 C CREEK EX.MACADAM R A DIVISION OF TRANSYSTEMS

P: \2017\17141805\Drawings\07-Site\17141805-WQ-Water Quality Map.dwg Nov 07, 2023 - 11:41am Plot By: rsmith

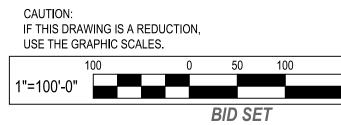




LEGEND:



CAUTION: IF THIS DRAWING IS A REDUCTION, USE THE GRAPHIC SCALES. 60_____0___0

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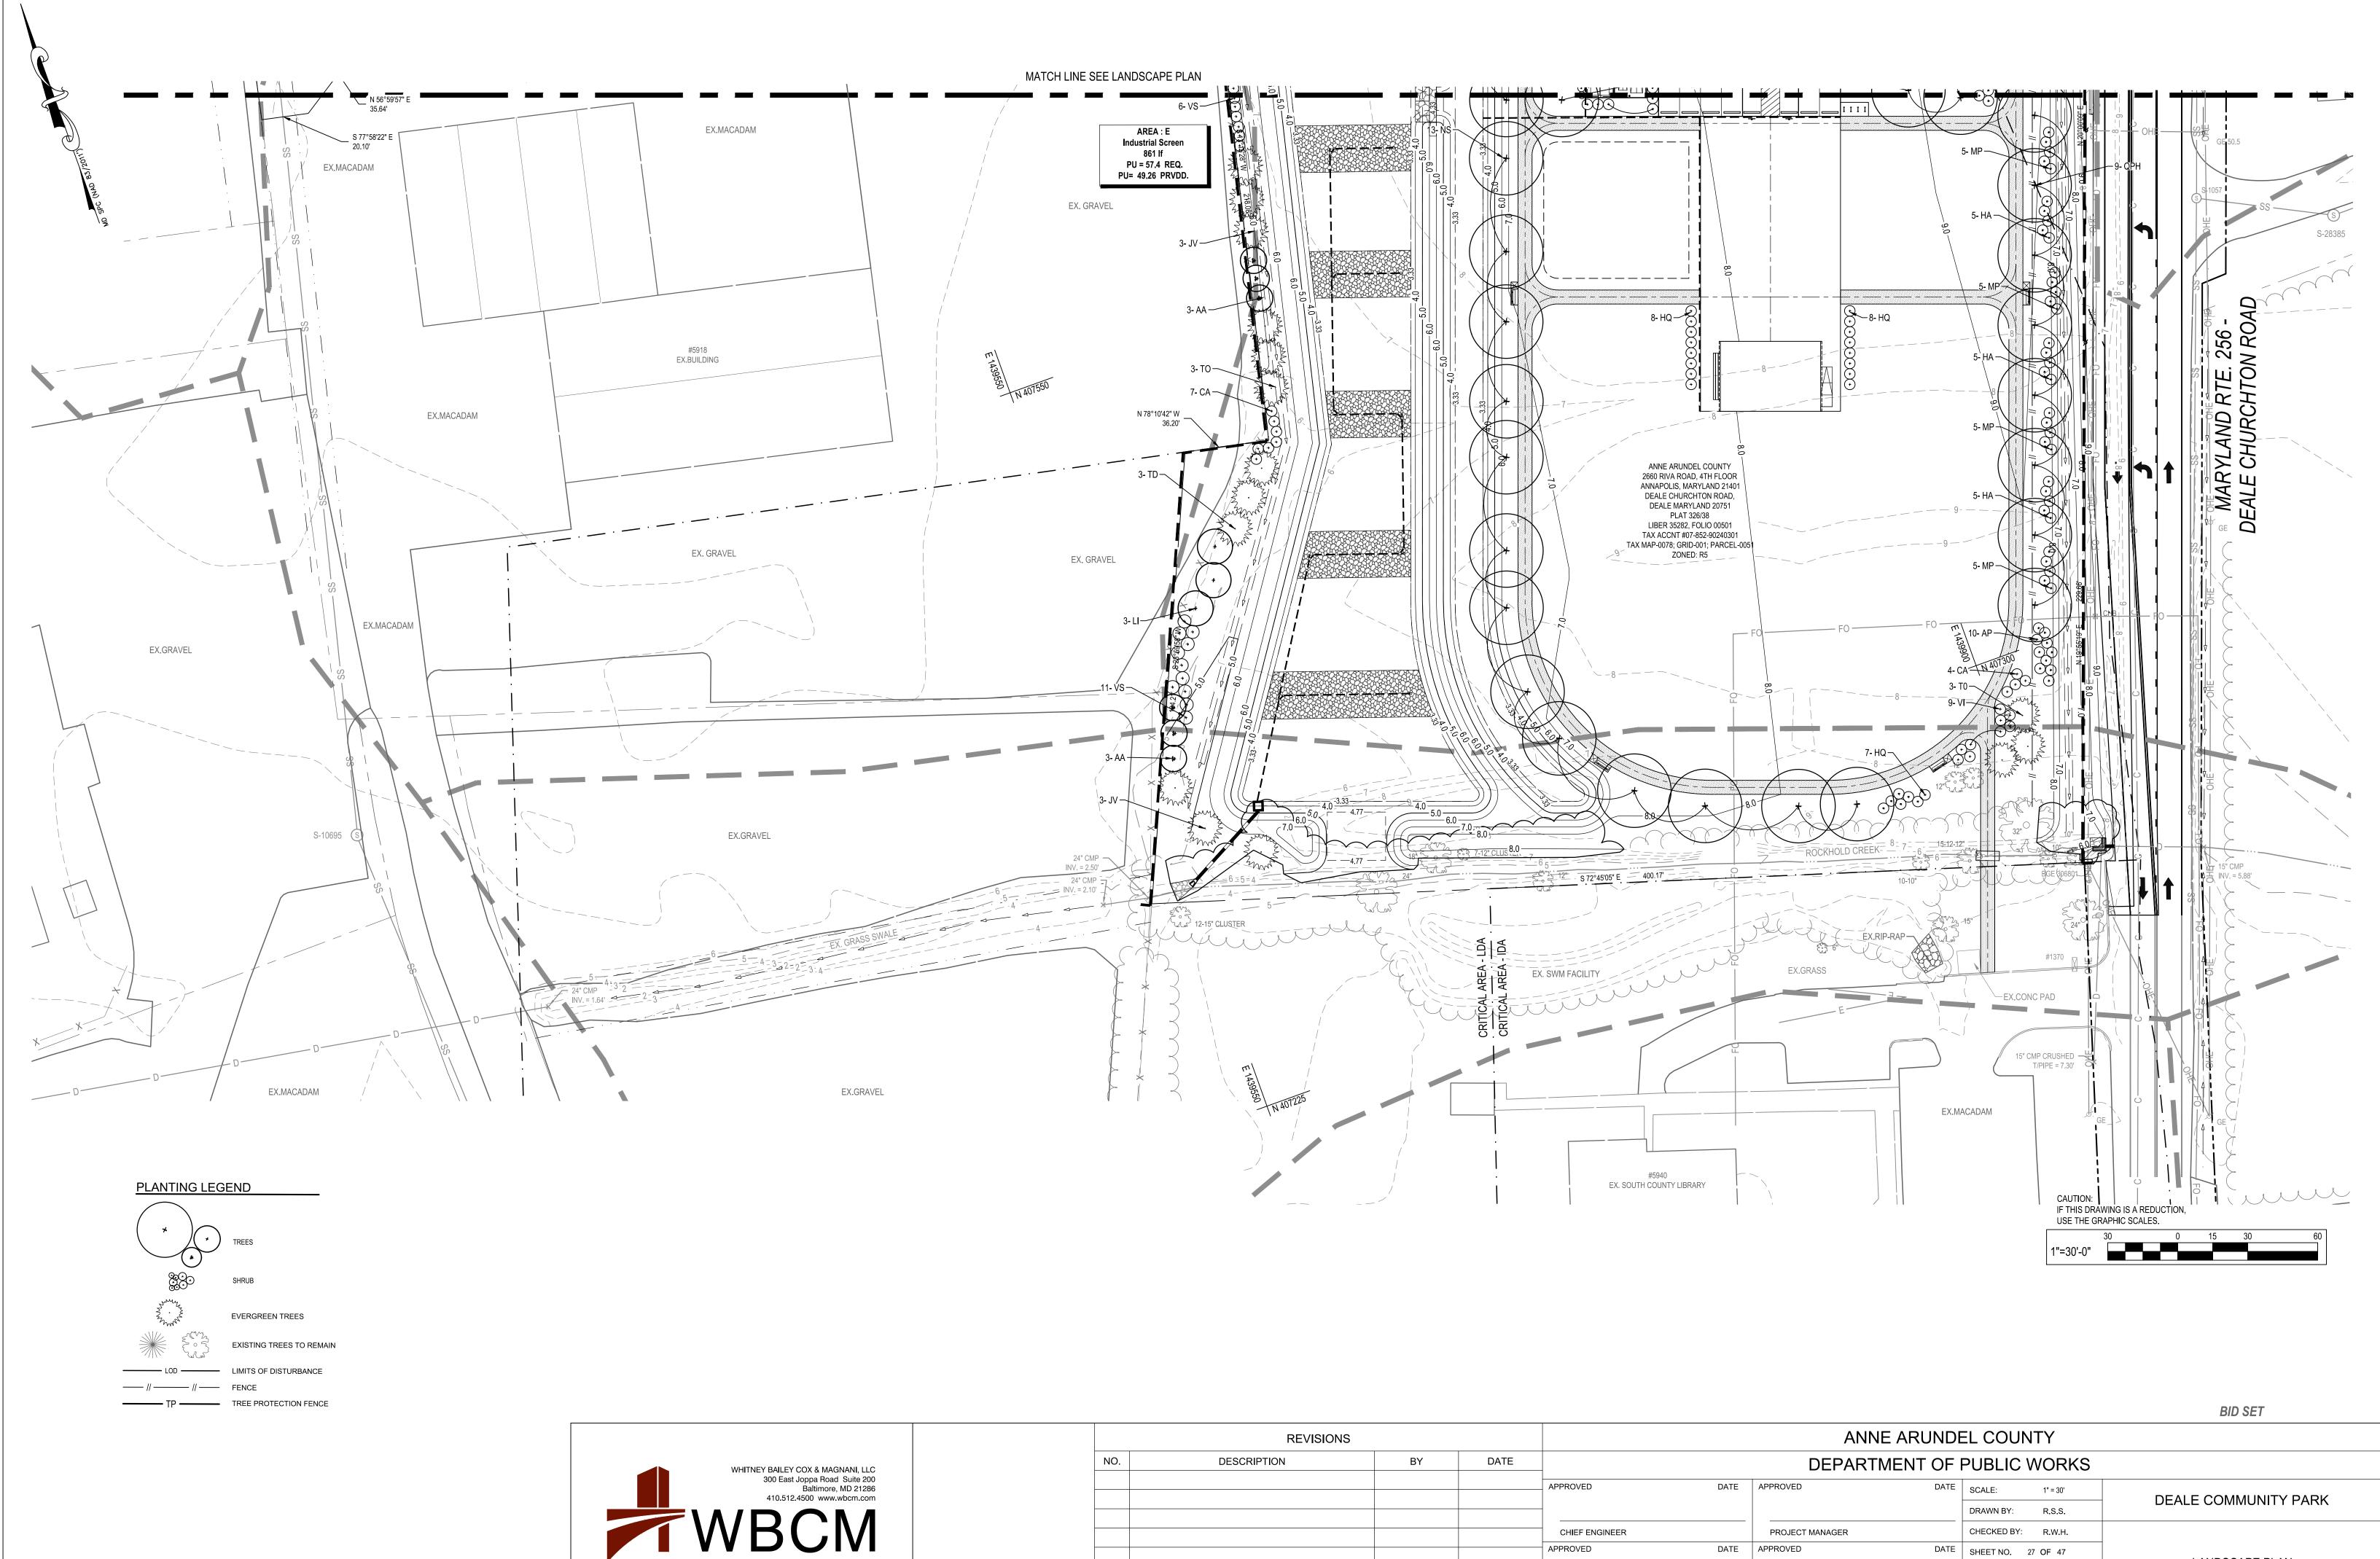
DEPARTMENT OF PUBLIC WORKS						
DATE	APPROVED DATE SCALE: 1"=60'					
		DRAWN BY: R.S.S.	DEALE COMMUNITY PARK			
	PROJECT MANAGER	CHECKED BY: R.W.H.				
DATE	APPROVED DATE	SHEET NO. 25 OF 47	WATER QUALITY MAP			
		PROJECT NO.: P582001				
IGINEER	CHIEF, RIGHT-OF-WAY	CONTRACT NO.: P582001				

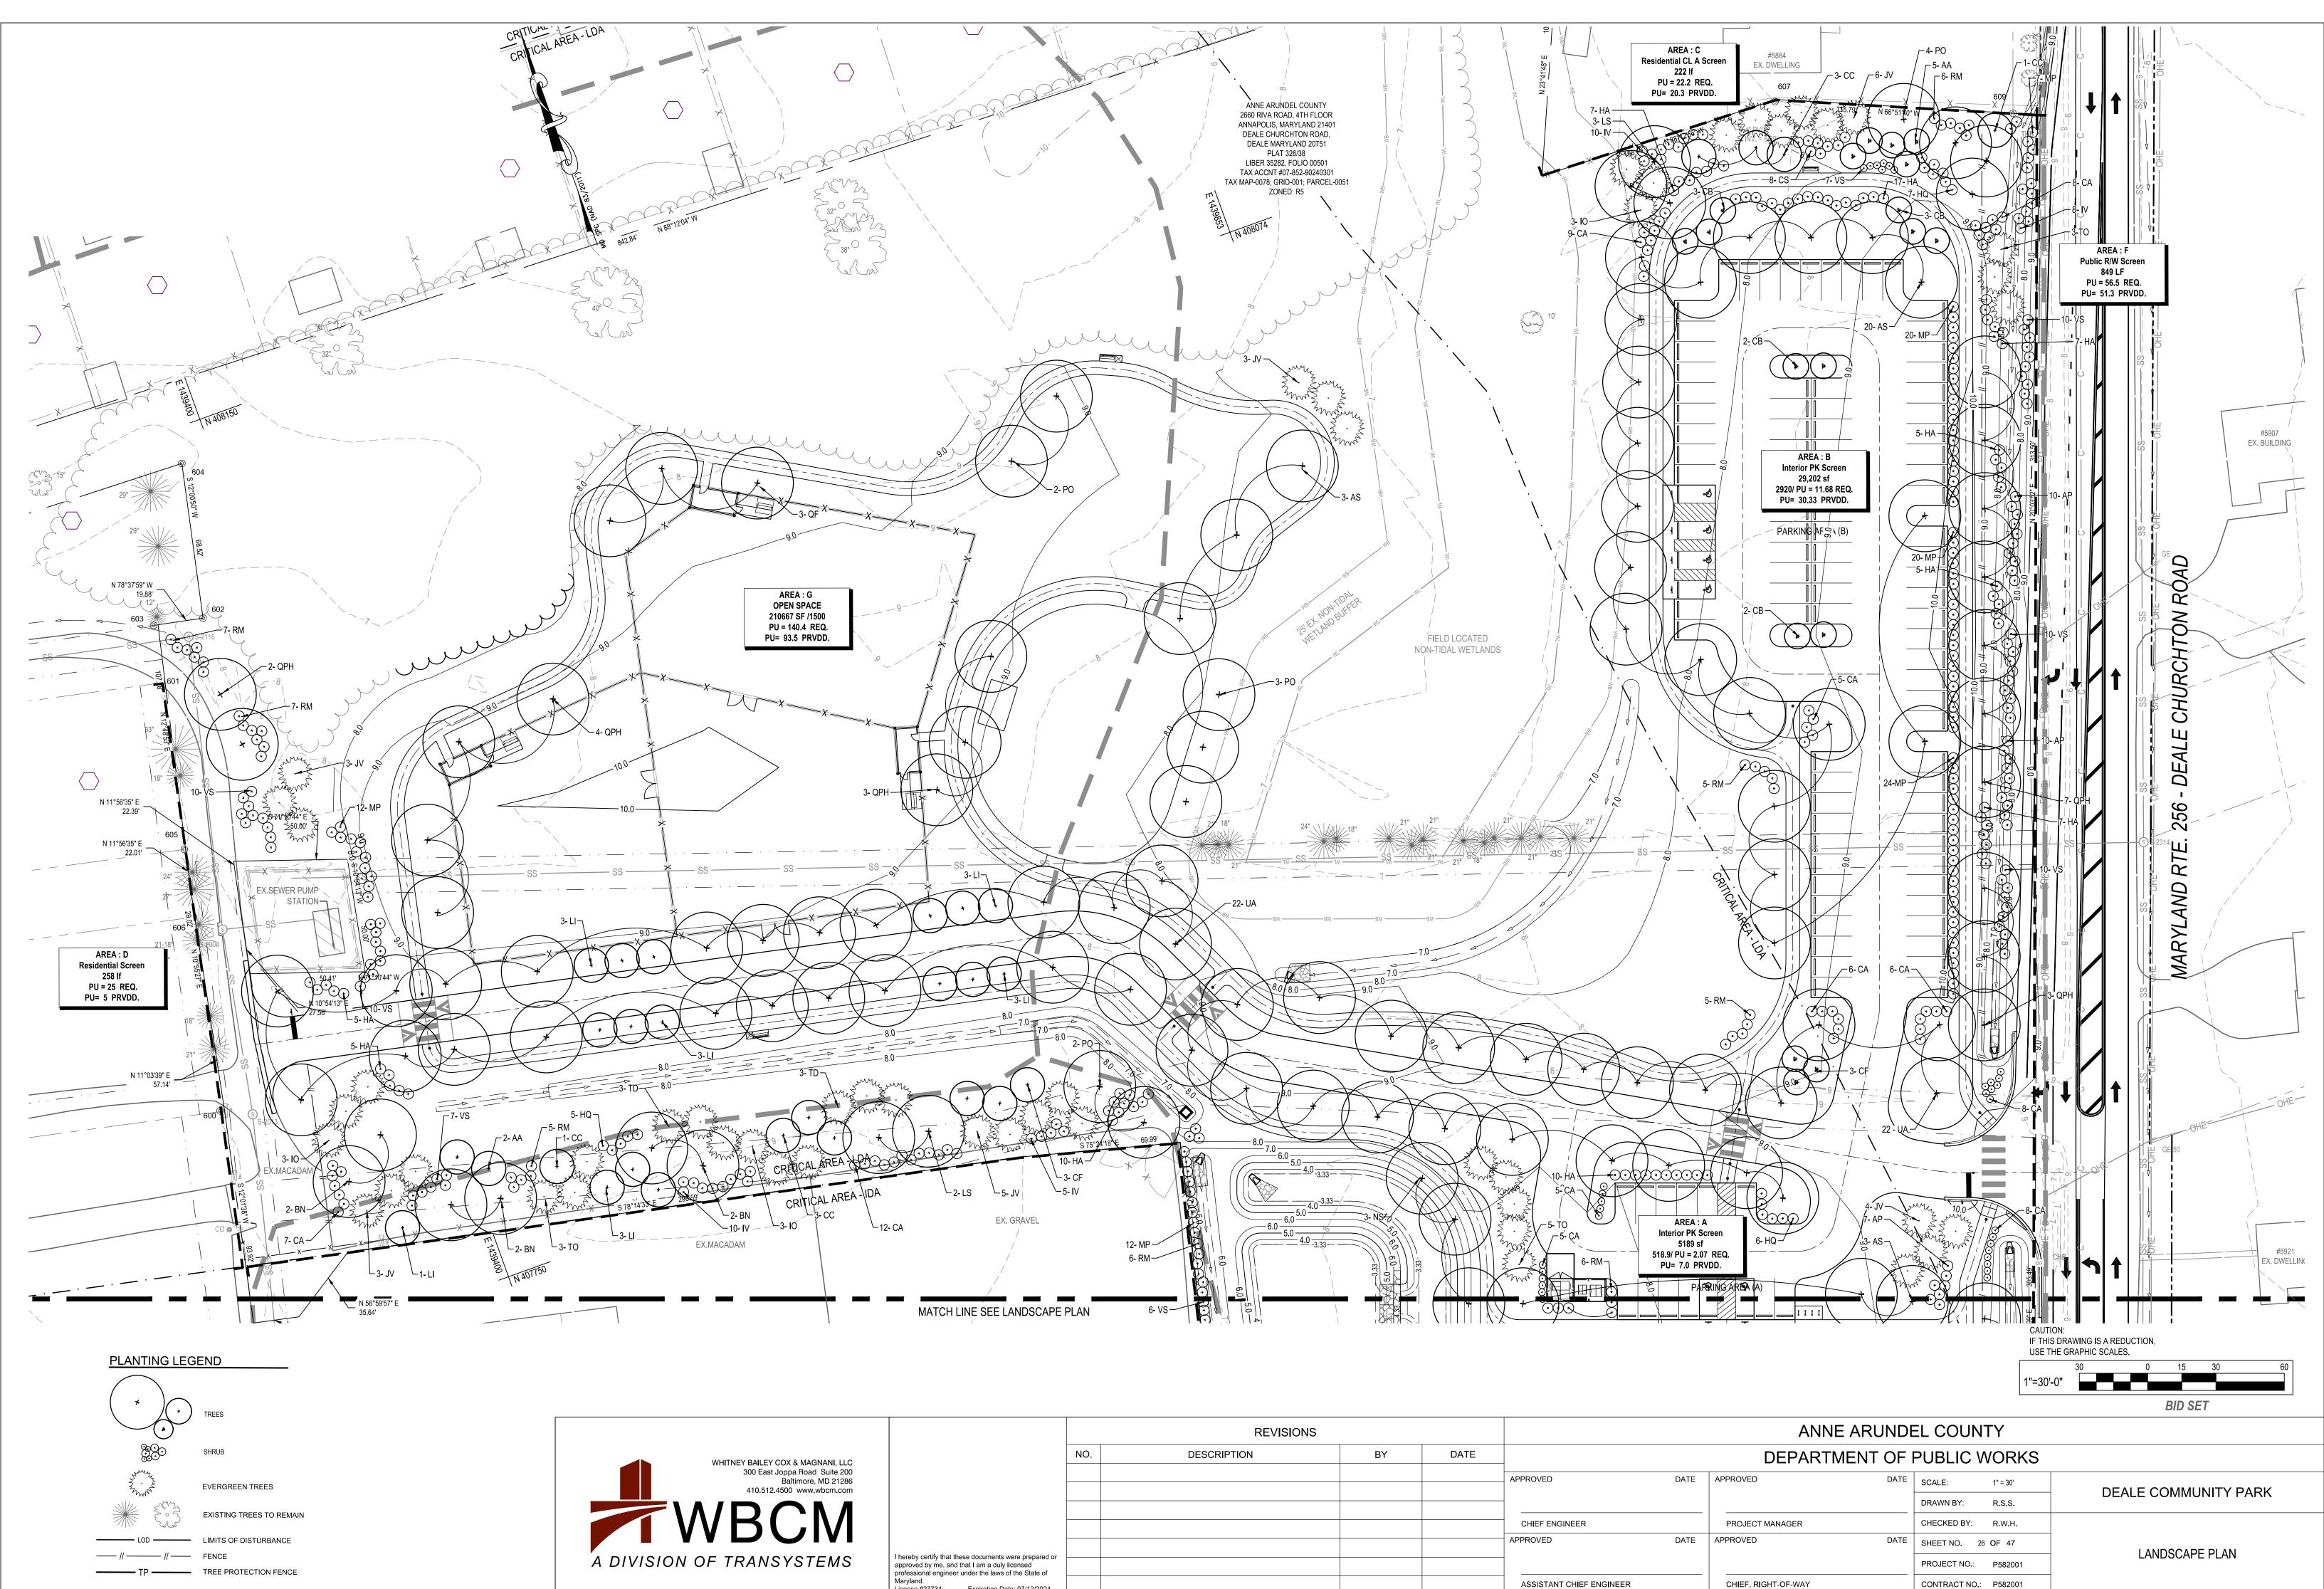

EY COX & MAGNANI, LLC		NO.	DESCRIPTION	BY	DATE	_
st Joppa Road Suite 200 Baltimore, MD 21286 12.4500 www.wbcm.com						APPROVED
CM						CHIEF ENGINEER
						APPROVED
ISYSTEMS	I hereby certify that these documents were prepared or approved by me, and that I am a duly licensed professional engineer under the laws of the State of					_
	Maryland. License #27734 Expiration Date: 07/12/2024					ASSISTANT CHIEF ENG

GINEER

CHIEF, RIGHT-OF-WAY





			REVISIONS	;		
Y COX & MAGNANI, LLC		NO.	DESCRIPTION	BY	DATE	_
at Joppa Road Suite 200 Baltimore, MD 21286 2.4500 www.wbcm.com						APPROVED
CM						
SYSTEMS	I hereby certify that these documents were prepared or approved by me, and that I am a duly licensed					APPROVED
	professional engineer under the laws of the State of Maryland. License #27734 Expiration Date: 07/12/2024					ASSISTANT CHIEF END


CHIEF, RIGHT-OF-WAY

PROJECT NO.: P582001

CONTRACT NO.: P582001

LANDSCAPE PLAN

IGINEER

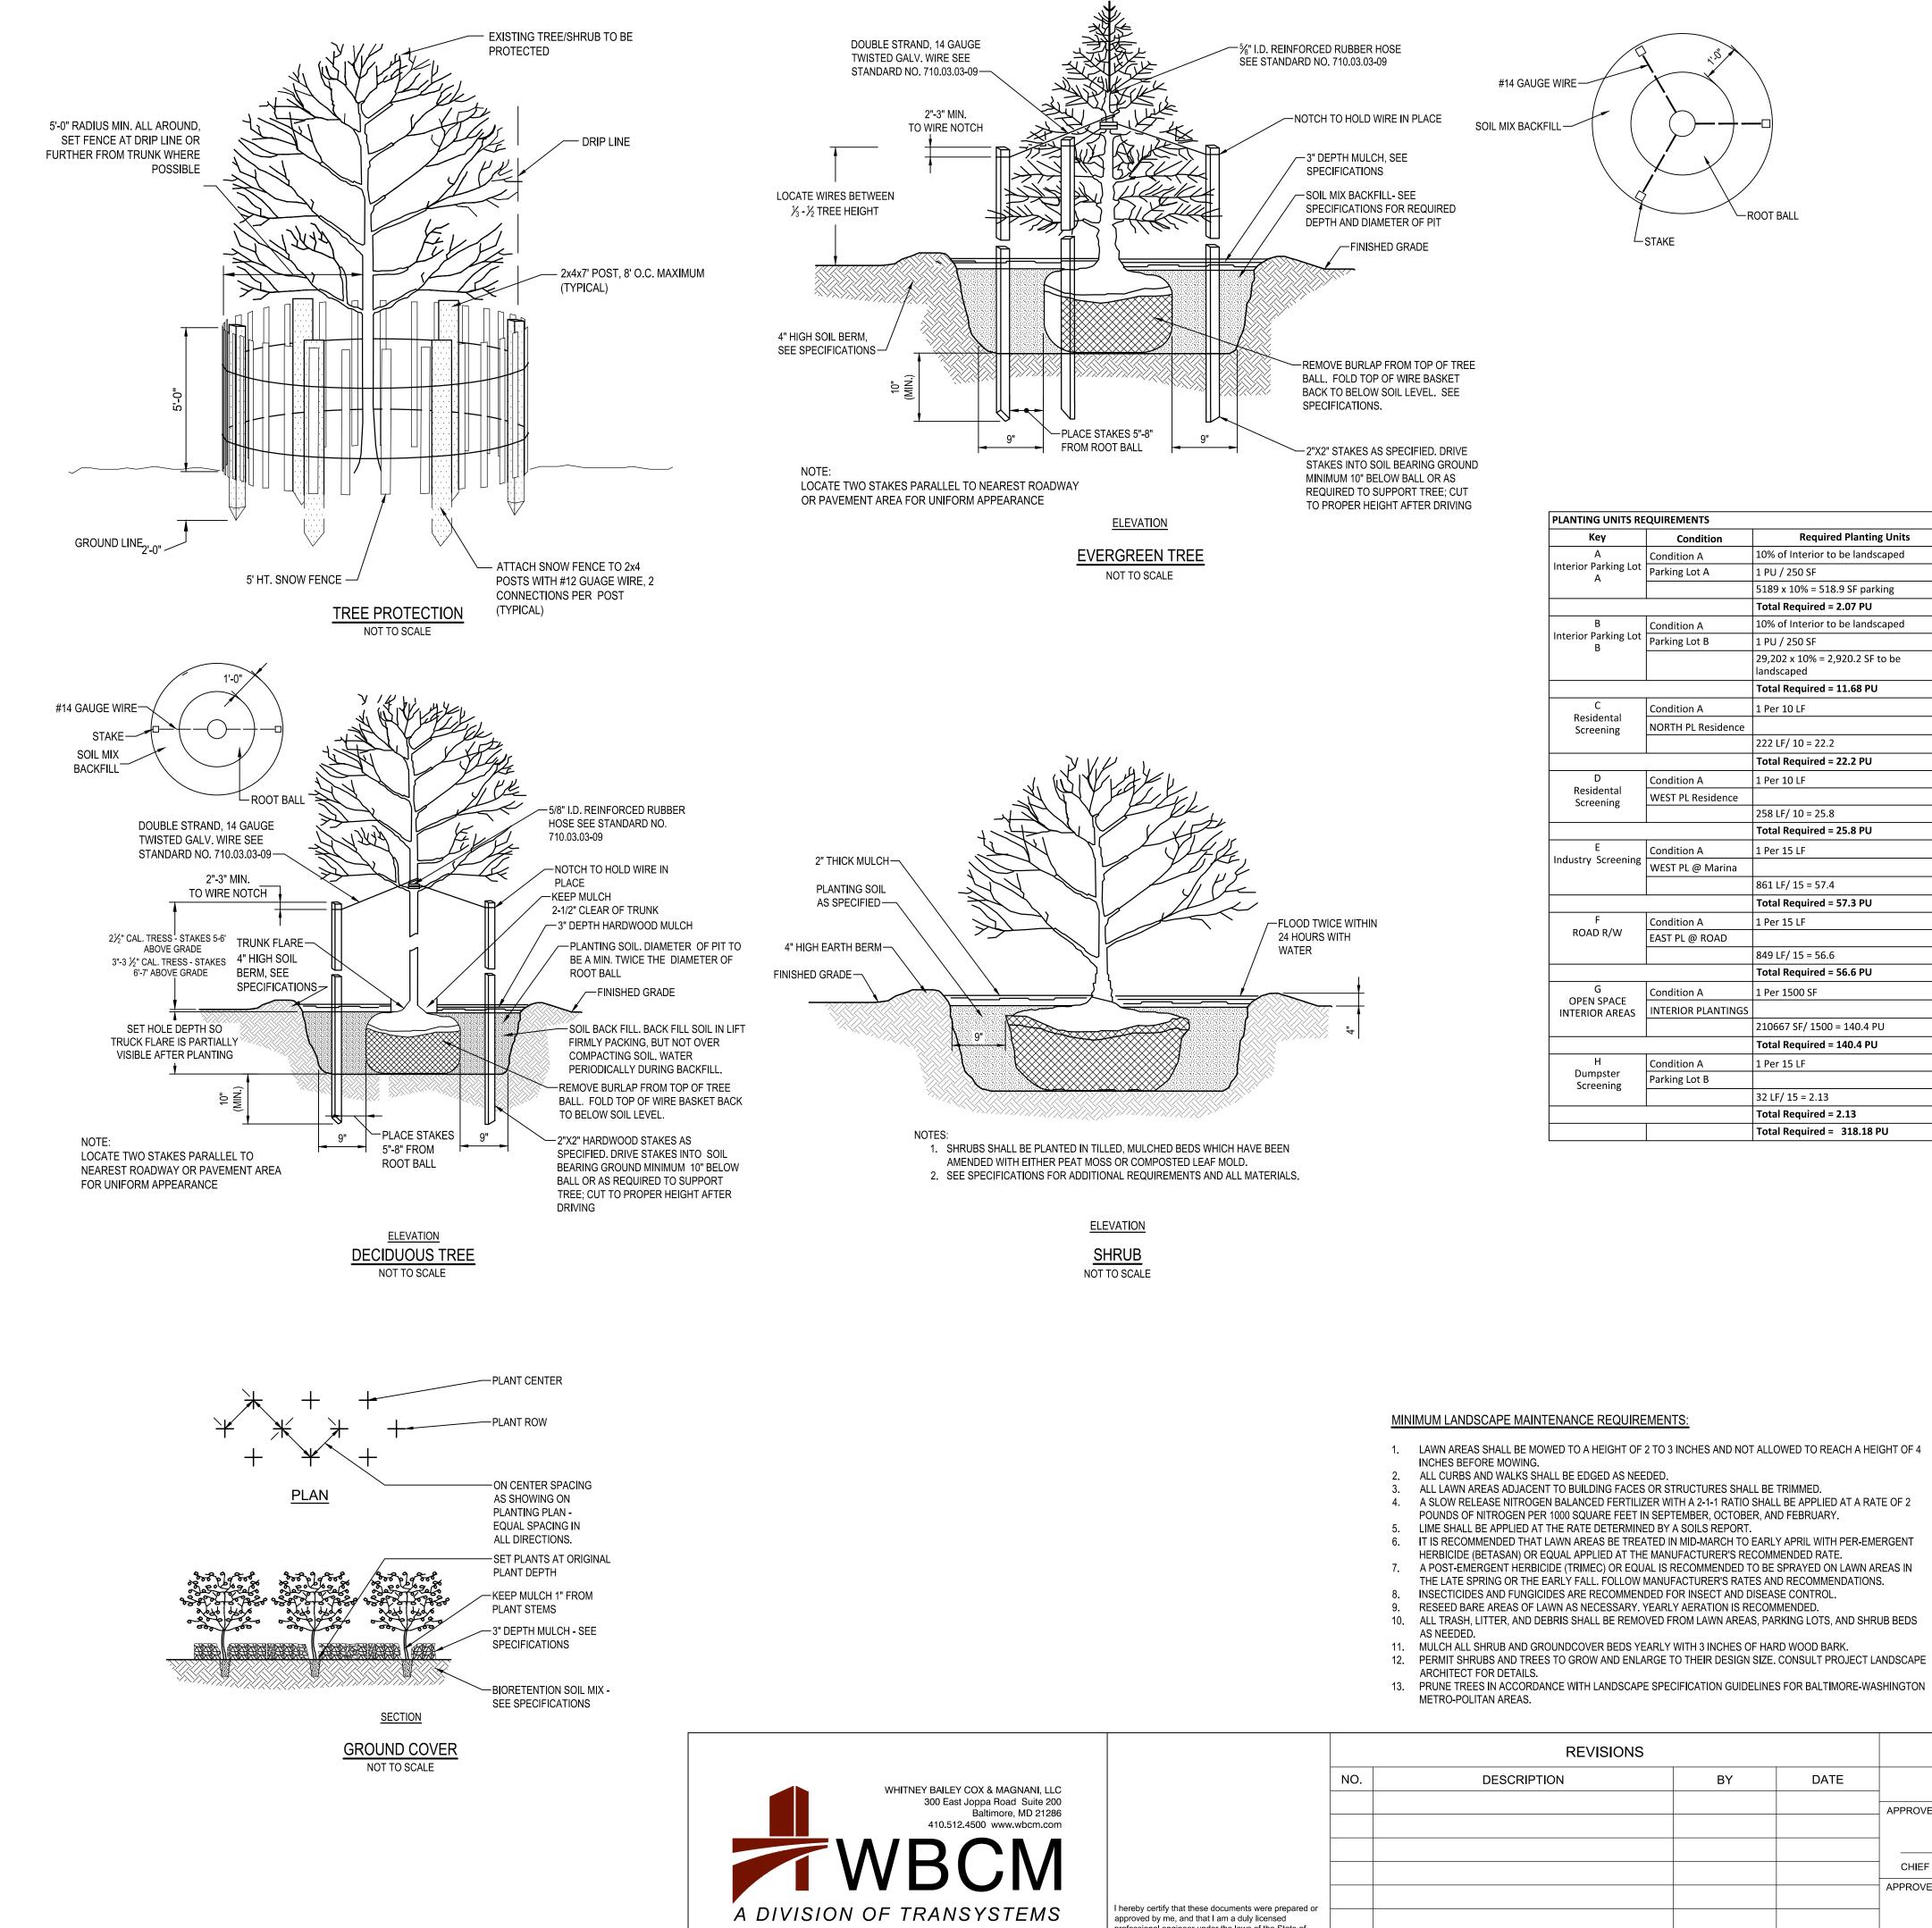

Кеу	Condition	Required Planting Units	Proposed Planting Units
А	Condition A	10% of Interior to be landscaped	(1 Major Tree 3 Shrubs) = 5.0 PU
nterior Parking Lot A	Parking Lot A	1 PU / 250 SF	(3 LG shrubs) = 2.0 PU
~		5189 x 10% = 518.9 SF parking	
		Total Required = 2.07 PU	Total Provided = 7.0 PU
В	Condition A	10% of Interior to be landscaped	(1 Major Tree 3 Shrubs) = 12PU
Interior Parking Lot B	Parking Lot B	1 PU / 250 SF	(2 Minor Trees 5 Shrubs)= 10/=5
U		29,202 x 10% = 2,920.2 SF to be landscaped	(3 LG shrubs) =40/ 13.3PU
	•	Total Required = 11.68 PU	Total Provided = 30.33 PU
С	Condition A	1 Per 10 LF	(1 Major Tree 3 Shrubs) = 7 PU
Residental Screening	NORTH PL Residence		(2 Minor Trees 5 Shrubs)= 4.5 PU (3 Evergreens) = 3.0 PU
ourcenting		222 LF/ 10 = 22.2	(3 LG shrubs) = 7.5/2.5 PU
	1	Total Required = 22.2 PU	Total Provided = 17.0 PU
D	Condition A	1 Per 10 LF	(1 Major Tree 3 Shrubs) = 6 PU
Residental Screening	WEST PL Residence		(3 Evergreens) = 2.0 PU (3 LG shrubs) = 15.0 PU
		258 LF/ 10 = 25.8	(3 LG shrubs) = 15.0 PO
		Total Required = 25.8 PU	Total Provided = 23.0 PU
E	Condition A	1 Per 15 LF	(1 Major Tree 3 Shrubs) = 8 PU
ndustry Screening	WEST PL @ Marina		(2 Minor Trees 5 Shrubs)= 11.0 PL (3 Evergreens) = 10.6 PU
		861 LF/ 15 = 57.4	(3 LG shrubs) = 5.3PU
	I	Total Required = 57.3 PU	Total Provided = 34.9 PU
F	Condition A	1 Per 15 LF	(1 Major Tree 3 Shrubs) = 20 PU
ROAD R/W	EAST PL @ ROAD		(3 Evergreens) = 2.0 PU
		849 LF/ 15 = 56.6	(3 LG shrubs) = 29.3PU
	•	Total Required = 56.6 PU	Total Provided = 51.3 PU
G	Condition A	1 Per 1500 SF	(1 Major Tree 3 Shrubs) = 74 PU
OPEN SPACE	INTERIOR PLANTINGS		(2 Minor Trees 5 Shrubs)= 7.5 PU (3 Evergreens) = 1.0PU
		210667 SF/ 1500 = 140.4 PU	(3 LG shrubs) = 11.0 PU
	1	Total Required = 140.4 PU	Total Provided = 95.1 PU
Н	Condition A	1 Per 15 LF	(1 Major Tree 3 Shrubs) = 1 PU
Dumpster Screening	Parking Lot B		(3 Evergreens) = 1.6 PU (3 LG shrubs) = 2.60 PU
Serverning		32 LF/ 15 = 2.13	
		Total Required = 2.13	Total Provided = 5.2
		Total Required = 318.18 PU	Total Provided = 263.83

- 1. LAWN AREAS SHALL BE MOWED TO A HEIGHT OF 2 TO 3 INCHES AND NOT ALLOWED TO REACH A HEIGHT OF 4
- 3. ALL LAWN AREAS ADJACENT TO BUILDING FACES OR STRUCTURES SHALL BE TRIMMED.
- POUNDS OF NITROGEN PER 1000 SQUARE FEET IN SEPTEMBER, OCTOBER, AND FEBRUARY.
- HERBICIDE (BETASAN) OR EQUAL APPLIED AT THE MANUFACTURER'S RECOMMENDED RATE.
- 8. INSECTICIDES AND FUNGICIDES ARE RECOMMENDED FOR INSECT AND DISEASE CONTROL.
- 9. RESEED BARE AREAS OF LAWN AS NECESSARY. YEARLY AERATION IS RECOMMENDED.
- 11. MULCH ALL SHRUB AND GROUNDCOVER BEDS YEARLY WITH 3 INCHES OF HARD WOOD BARK.
- 13. PRUNE TREES IN ACCORDANCE WITH LANDSCAPE SPECIFICATION GUIDELINES FOR BALTIMORE-WASHINGTON

	NO.	DESCRIPTION	BY	DATE	_
					APPROVED
					_
					CHIEF ENGINEER APPROVED
were prepared or licensed of the State of					
ate: 07/12/2024					ASSISTANT CHIEF ENGINEER

professional engineer under the laws of t Maryland. License #27734 Expiration Date:

Qty.	SYM.	Botanical Name	Common Name	Size (Min.)	Root	Remarks
Major Decid	uous Trees		1			
26	AS	Acer saccharum 'Legacy'	Sugar Maple Legacy	2.5" Cal.	B&B	As Shown
6	BN	Betula nigra	River Birch	2.5" Cal.	B&B	As Shown
5	LS	Liquidambar styraciflua	Sweet Gum	2.5" Cal.	B&B	As Shown
16	NS	Nyssa sylvatica 'Wildfire'	Black Tupelo	2.5" Cal.	B&B	As Shown
11	PO	Platanus occidentalis	American Sycamore	2.5" Cal.	B&B	As Shown
30	QPH	Quercus phellos	Willow Oak	2.5" Cal.	B&B	As Shown
44	UA	Ulmus americana 'Delaware'	Delaware Americana Elm	2.5" Cal.	B&B	As Shown
138		Total				
Minor Decid	uous Trees					
33	AA	Amelanchier arborea	Downy Serviceberry	1-1/2" Cal.	B&B	As Shown
10	СВ	Carpinus betulus 'Fastigiata'	European Hornbeam	1-1/2" Cal.	B&B	As Shown Limbed up to 6'
8	СС	Cercis canadensis	Eastern Redbud	1-1/2" Cal.	B&B	Multistem
6	CF	Cornus florida	Flowering Dogwood	1-1/2" Cal.	B&B	As Shown
19	LI	Lagerstroemia indica x fauriei 'Muskogee'	Muskogee Crape Myrtle	1-1/2" Cal.	B&B	As Shown
76		Total		•		•
Evergreen T	rees					
9	IO	Ilex opaca 'Jersey Princess'	American Holly	8-10' Hgt.	B&B	As Shown
24	JV	Juniperus virginiana 'Canaertil'	Eastern Red Cedar	10-12' Hgt.	B&B	As Shown
17	TD	Taxodium distichum	Bald cypress	8-10' Hgt.	B&B	As Shown
12	то	Thuja occidentalis	Eastern Arborvitae	8-10' Hgt.	B&B	As Shown
62		Total	•			•
Shrubs						
37	AP	Asculus parviflora	Bottlebrush Buckeye	#7	Cont.	3' O.C.
73	CA	Clethra alnifolia 'Hummingbird'	Summersweet	#3	Cont.	3' O.C.
19	CS	Cornus sericea 'Baileyi'	RedTwig Dogwood	#5	Cont.	6' O.C.
93	НА	Hydrangea aborscens 'Annabelle'	Smooth Hydrangea	#5	Cont.	di
41	HQ	Hydrangea quercifolia 'Ruby Slippers'	Oakleaf Hydrangea	#5	Cont.	di
43	IV	llex verticillatta	Winterberry Holly	#5	Cont.	6' O.C.
9	IV	Ilex verticillatta 'Southern Gentleman'	Winterberry Holly	#5	Cont.	6' O.C. 1 male per 7
60	VS	Itea virginica 'Henry's Garnet'	Virginia Sweetspire	#3	Cont.	3' O.C.
115	MP	Myrica pensylvanica	Northern Bayberry	#5	Cont.	5' O.C.
40	RM	Rhododendron maximum	Rosebay Rhododendron	3-4' Hgt.	Cont.	5' O.C.
530		Total		· · ·		


GENERAL NOTES:

- 1. ALL PLANT MATERIAL SHALL CONFORM TO THE SIZES GIVEN IN THE PLANT LIST AND SHALL BE NURSERY GROWN IN ACCORDANCE WITH THE "AMERICAN STANDARDS FOR NURSERY STOCK, ANSI Z60.1-2004" LATEST EDITION PREPARED BY THE AMERICAN ASSOCIATION OF NURSERYMEN, 230 SOUTHERN BUILDING, WASHINGTON, DC, 20005.
- 2. CONTRACTOR MUST VERIFY THE CORRECT LOCATION OF ANY EXISTING UTILITIES WHICH ARE UNDERGROUND, PRIOR TO PLANT INSTALLATION. THE CONTRACTOR SHALL CALL MISS UTILITY (1-800-257-7777) A MINIMUM OF 48 HOURS PRIOR TO CONSTRUCTION CONTRACTOR IS RESPONSIBLE FOR OBTAINING ALL PERMITS AND REQUIREMENTS FOR CONSTRUCTION.
- 3. ALL PLANT BEDS SHALL BE MULCHED WITH A MINIMUM OF 2" AND A MAXIMUM OF 3" LAYER OF MULCH WITHIN TWO DAYS AFTER PLANTING. THIS SHALL BE SHREDDED HARDWOOD BARK, AND SHALL COVER ENTIRELY THE PLANTING BED.
- 4. ALL PLANTS SHALL BE GUARANTEED TO REMAIN ALIVE AND HEALTHY FOR A PERIOD OF TWO FULL YEARS AFTER INITIAL ACCEPTANCE. ANY REPLACEMENT PLANTS, REQUIREMENTS, ETC. AND METHOD OF PLACING SHALL COMPLY WITH THE REQUIREMENTS SPECIFIED HEREIN AND ON THE DRAWINGS.
- 5. EXISTING SOIL IN BED AREAS SHALL BE AMENDED TO A DEPTH OF 12". SOIL MIX IN ALL BEDS SHALL BE 2/3 EXISTING SOIL, AND 1/3 ORGANIC MATERIAL SUCH AS LEAFGRO.
- 6. PLANT MATERIAL AVAILABILITY MAY VARY AT THE TIME OF CONSTRUCTION. ANY SUBSTITUTIONS ARE TO BE OF EQUIVALENT TYPE AND SIZE (OR LARGER), AND MUST BE APPROVED BY LANDSCAPE ARCHITECT BEFORE INSTALLATION.
- WHERE THE CONDITION EXISTS THAT BALLED AND BURLAPPED TREES ARE DELIVERED IN WIRE BASKETS, THE WIRE BASKETS SHALL BE CUT DOWN THE SIDE OF EACH MESH AND PEELED AWAY FROM THE ROOTBALL OR REMOVED IN ENTIRETY. NO PORTION OF THE WIRE BASKET SHALL REMAIN INTACT AROUND THE SIDES OF THE ROOTBALL OR EXTEND ABOVE FINISHED GRADE.
- 8. ANY DAMAGE TO THE EXISTING UTILITIES, BUILDINGS, PAVING, CURB, WALLS, AND VEGETATION (NOT SO DESIGNATED FOR REMOVAL ON THESE PLANS) SHALL BE REPAIRED TO PREVIOUS CONDITION OR REPLACED BY THE CONTRACTOR AT HIS EXPENSE. ALL AREAS DISTURBED DURING CONSTRUCTION ARE TO BE SEEDED UNLESS NOTED OTHERWISE.
- 9. ADJUST TREE LOCATIONS IN THE FIELD IF LOCATIONS SHOWN CONFLICT WITH EXISTING VEGETATION NOT PICKED UP IN SURVEY.
- 10. SEED DISTURBED AREAS.

ANNE ARUNDEL COUNTY

DEPARTMENT OF PUBLIC WORKS DATE APPROVED DATE SCALE: AS SHOWN DEALE COMMUNITY PARK R.S.S. DRAWN BY: PROJECT MANAGER CHECKED BY: R.W.H. DATE APPROVED DATE SHEET NO. 28 OF 47 LANDSCAPE NOTES AND DETAILS PROJECT NO.: P582001 CHIEF, RIGHT-OF-WAY CONTRACT NO.: P582001

BID SET

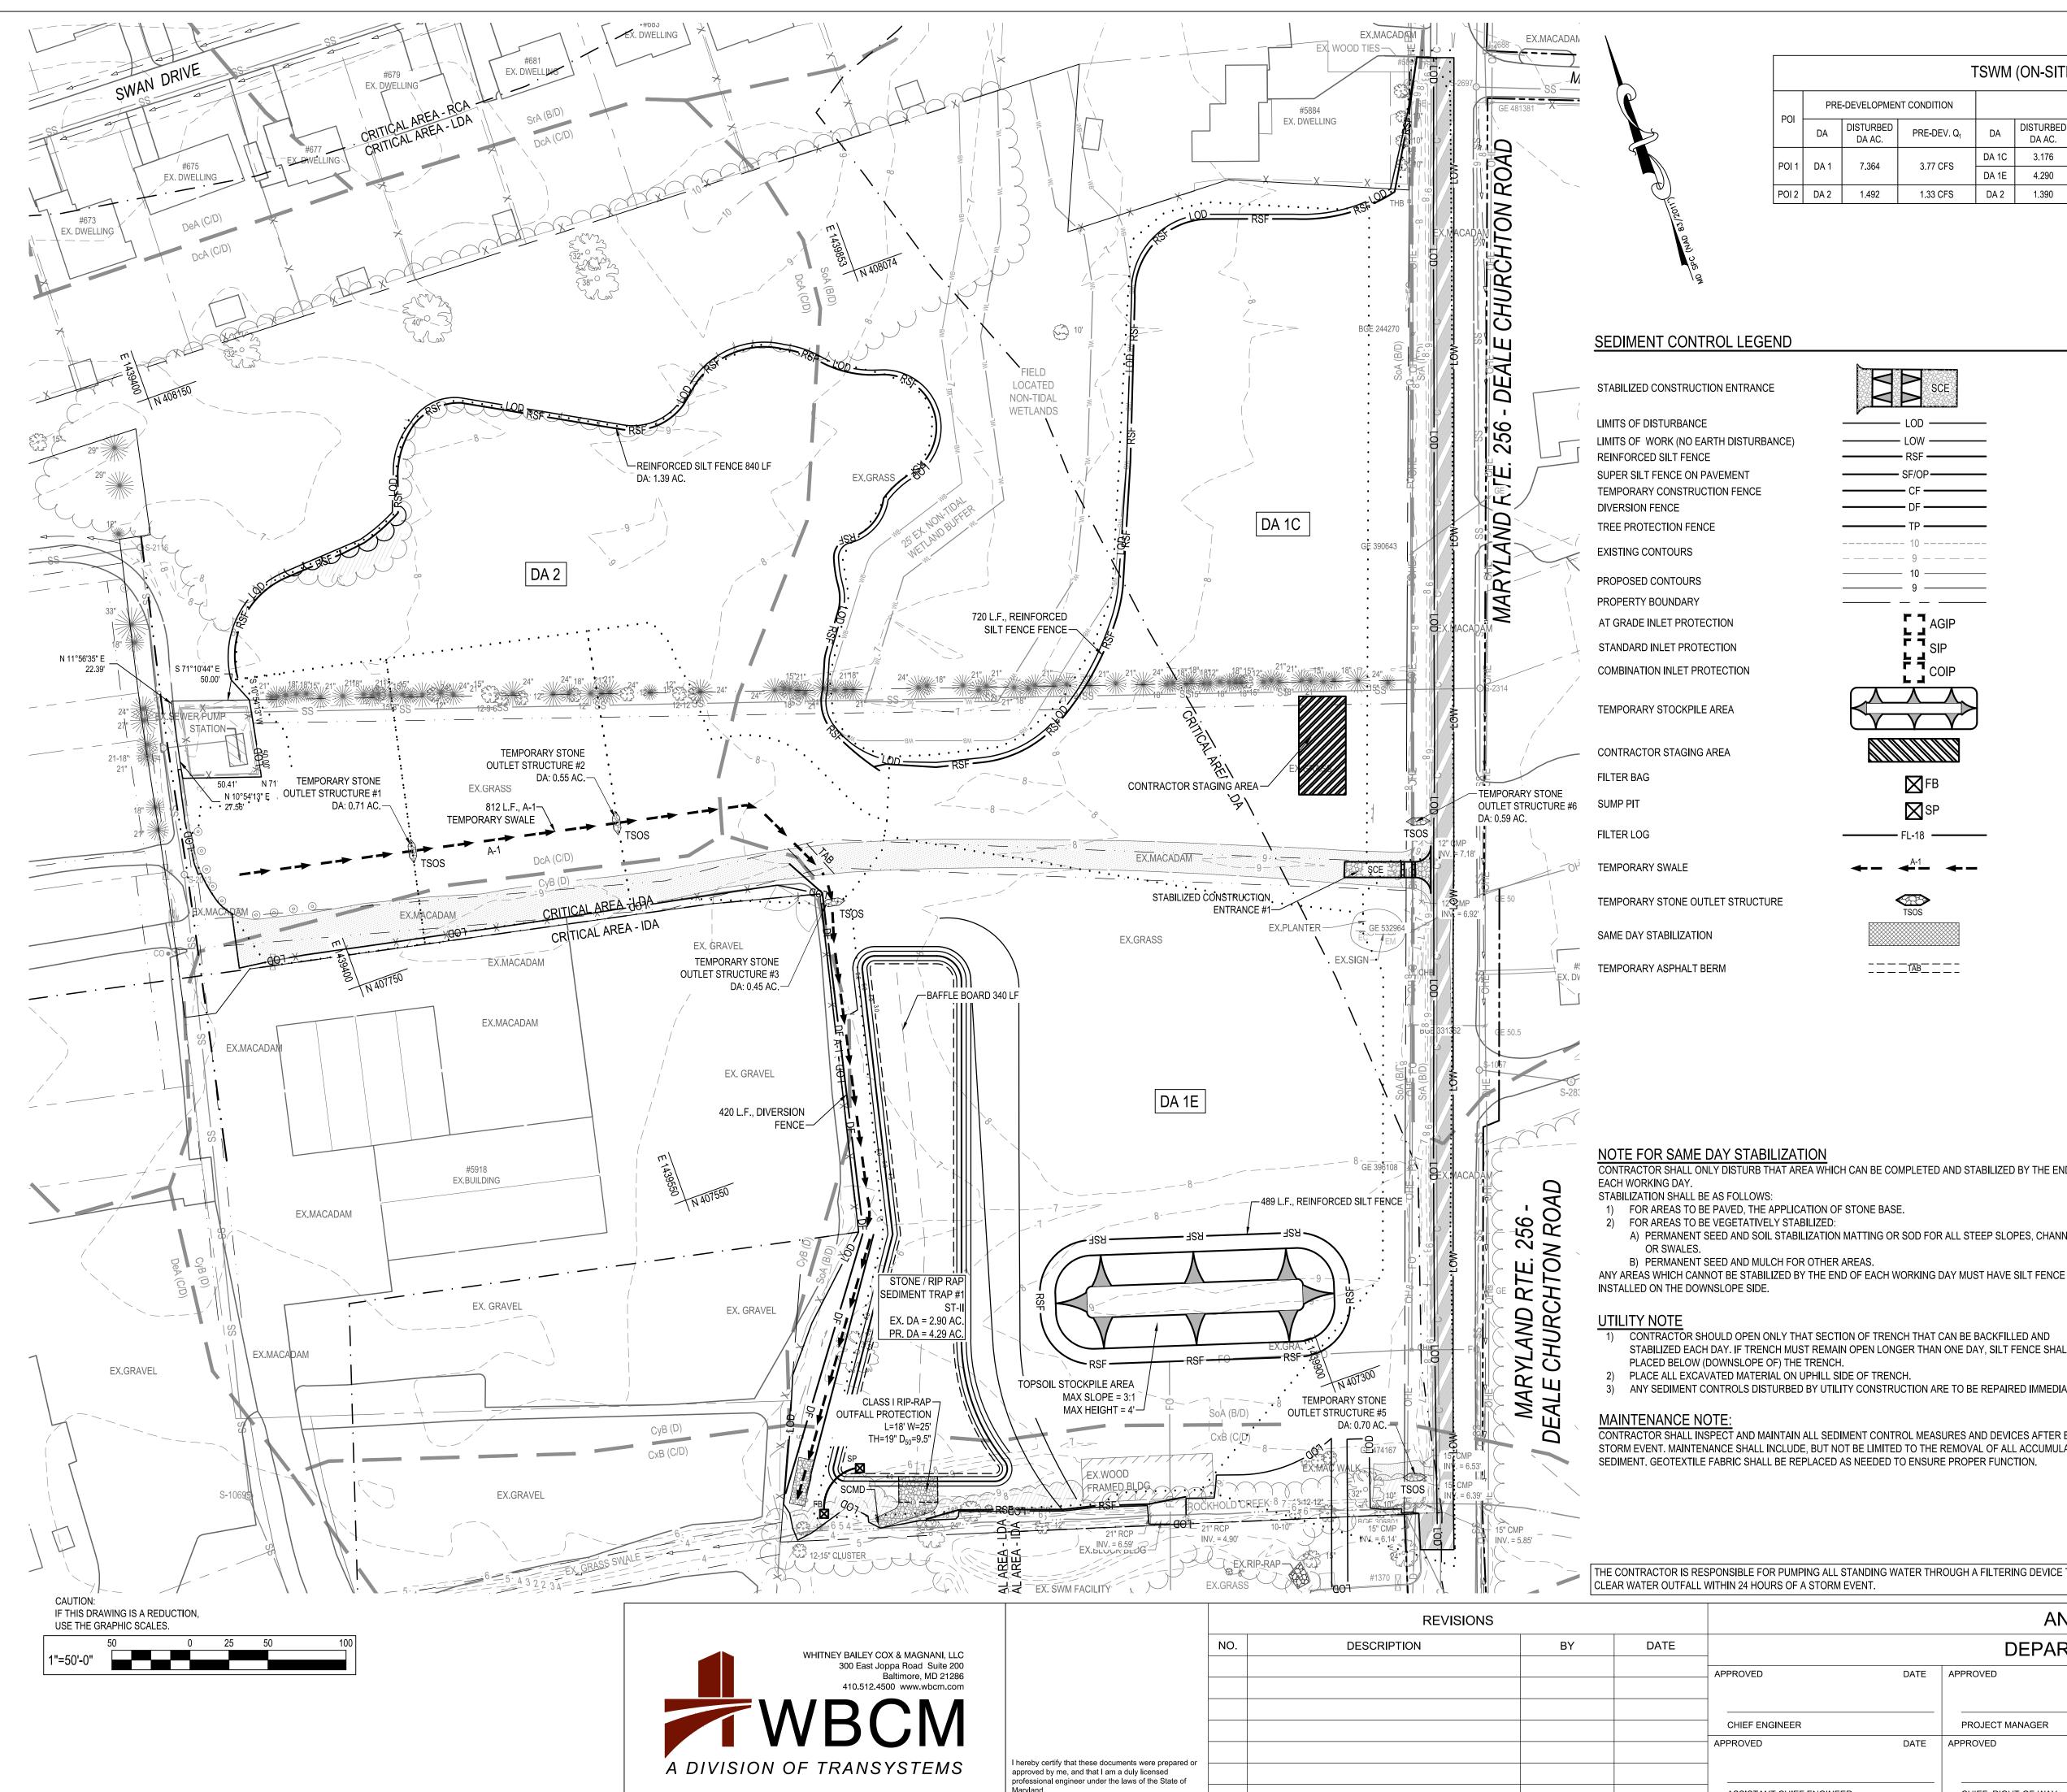

Maryland. _icense #27734 Expiration Date: 07/12/2024

ASSISTANT CHIEF ENG

TSWM (ON-SITE DA)

PRE-DEVELOPMENT CONDITION					INTERIM CON	DITION
DA	DISTURBED DA AC.	PRE-DEV. Q ₁	DA	DISTURBED DA AC.	INTERIM Q ₁	PROPOSED ESC PRACTICE
)A 1	7.004	7,364 3,77 CFS	DA 1C	3.176	4.55 CFS	SHEET FLOW TO RSF
A 1 7.364		7.304 3.77 CF3	DA 1E	4.290	4.55 013	ST II
A 2	1.492	1.33 CFS	DA 2	1.390	2.66 CFS	SHEET FLOW TO RSF

SEQUENCE OF CONSTRUCTION

INITIAL PHASE

- 1. PRE-CONSTRUCTION MEETING: NOTIFY THE DEPARTMENT OF INSPECTIONS AND PERMITS. (410-222-7780), RECREATION AND PARKS CONTACT ERICA JACKSON (410-222-2866) AT LEAST 48 HOURS BEFORE COMMENCING WORK. WORK MAY NOT COMMENCE UNTIL THE PERMITTEE OR THE RESPONSIBLE PERSONNEL HAVE MET ON SITE WITH THE SEDIMENT AND EROSION CONTROL INSPECTOR TO REVIEW THE APPROVED PLANS. THE PERMITTEE OR CONTRACTOR SHALL NOT COMMENCE WITH CLEARING OR ANY EARTH DISTURBANCE ACTIVITIES ON THE SITE DURING OR BEFORE PREDICTED WET WEATHER EVENTS. ONCE SITE WORK BEGINS, CLEARING AND GRUBBING ACTIVITIES SHALL BE FOR THE INSTALLATION AND STABILIZATION OF THE PERIMETER EROSION CONTROL
- MEASURES ONLY. 2. CONTRACTOR SHALL LOCATE AND PROCURE ALL STAGING AND STOCKPILING AREAS WHICH SHALL BE APPROVED BY
- THE PROJECT INSPECTOR. 3. PRESENT FINALIZED SCHEDULE OF WORK AND MAINTENANCE OF TRAFFIC OPERATIONS TO THE ENGINEER AND
- ANNE ARUNDEL COUNTY INSPECTIONS AND PERMITS DIVISION. 4. THE EXISTING MACADAM ROAD SERVING THE ADJACENT PROPERTIES LOCATED TO THE WEST OF THE SITE SHALL BE MAINTAINED DURING CONSTRUCTION.
- 5. CLEAR MINIMUM AREAS NECESSARY FOR INSTALLATION OF SEDIMENT AND EROSION PERIMETER CONTROLS, INCLUDING STABILIZED CONSTRUCTION ENTRANCE, REINFORCED SILT FENCE, DIVERSION FENCE, AND TEMPORARY SWALE WITH TEMPORARY STONE OUTLET STRUCTURES PER PLAN.
- 6. BUILD STAGING AND STOCKPILE AREAS AND INSTALL SEDIMENT RAP. INSTALL SEDIMENT TRAP #1 WITH SEDIMENT CONTROL MONITORING DEVICE.
- 7. INSTALL REMAINING SEDIMENT CONTROL DEVICES AS REQUIRED PER THE PLANS. CONTACT THE INSPECTOR FOR APPROVAL OF THE SEDIMENT CONTROL INSTALLATION. INSPECTION AND PERMITS WILL BE REQUIRED THAT AN INSPECTION AND CERTIFICATION OF THE INSTALLATION OF THE SEDIMENT CONTROLS BE PERFORMED BY A DESIGN PROFESSIONAL PRIOR TO CONSTRUCTION COMMENCING.
- 8. BUILD STAGING AND STOCKPILE AREAS. OBTAIN APPROVAL FROM THE COUNTY SEDIMENT AND EROSION CONTROL INSPECTOR.
- 9. BEGIN PAVEMENT REMOVAL. AND MASS GRADING OF PROPOSED GRASS PLAYING FIELD.
- 10. INSTALL REMAINING TEMPORARY STONE OUTLET STRUCTURES PER PLANS.
- 11. PERFORM THE FOLLOWING SEQUENCE FOR EACH DAY OF UTILITY CONSTRUCTION OPERATIONS:
 - CONTRACTOR TO ONLY DISTURB THE AREA THAT WILL BE STABILIZED THE SAME DAY. INSTALL REINFORCED SILT FENCE DOWNGRADE OF AREA TO BE WORKED ON A DAILY BASIS.
- C. INSTALL TEMPORARY PAVING OR, PLACE TOPSOIL, FINE GRADE, SEED AND APPLY MULCH IN UNPAVED DISTURBED AREAS.

DETAIL G-1-2 STONE/RIPRAP OUTLET SEDIMENT TRAP ST-II

10. STREETS ARE TO BE SWEPT FREE OF DIRT AND DEBRIS.

DETAIL G-1-2 STONE/RIPRAP OU	JILEI SEDIMENT	1KAP 51-11
	TRAP NO	1
DRAINAGE AREA - INITIAL	2.90	ACRES
DRAINAGE AREA - INTERIM	4.29	ACRES
DRAINAGE AREA - FINAL	4.29	ACRES
TOTAL STORAGE REQUIRED	15,444	CF
TOTAL STORAGE PROVIDED	21,173	CF
WET STORAGE REQUIRED	7,722	CF
WET STORAGE PROVIDED	11,711	CF
DRY STORAGE REQUIRED	7,722	CF
DRY STORAGE PROVIDED	9,462	CF
EXISTING GROUND ELEVATION AT OUTLET (WET STORAGE ELEVATION)	4.00	FT
TRAP BOTTOM ELEVATION	3.33	FT
TRAP BOTTOM DIMENSIONS	326 x 51	(L) FT X (W) FT
WEIR LENGTH	25.00	FT
WEIR CREST (DRY STORAGE) ELEVATION	4.50	FT
CLEANOUT ELEVATION	4.00	FT
TOP OF EMBANKMENT ELEVATION	6.00	FT
SIDE SLOPE	3:1	H:V RATIO
EMBANKMENT TOP WIDTH	3	FT
OUTLET PROTECTION-LENGTH	18	FT
OUTLET PROTECTION-DEPTH	19	IN

STANDARD STABILIZATION NOTE:

FOLLOWING INITIAL SOIL DISTURBANCE OR REDISTURBANCE, PERMANENT OR TEMPORARY STABILIZATION SHALL BE COMPLETED WITHIN THREE (3) CALENDAR DAYS AS TO THE SURFACE OF ALL PERIMETER CONTROLS, DIKES, SWALES, DITCHES, PERIMETER SLOPES, AND ALL SLOPES GREATER THAN 3 HORIZONTAL TO 1 VERTICAL (3:1); AND SEVEN DAYS (7) AS TO ALL OTHER DISTURBED OR GRADED AREAS ON THE PROJECT SITE."

MAINTENANCE OF SEDIMENT CONTROL

CONTRACTOR SHALL WITHOUT EXTRA COST TO THE PROJECT, REPAIR AND MAINTAIN EXISTING SEDIMENT CONTROL DEVICES UNTIL ALL AREAS WITHIN LIMITS OF CONSTRUCTION ARE STABILIZED. ALL SEDIMENT CONTROL MEASURES REFERRED TO ON THESE PLANS SHALL BE IN ACCORDANCE WITH THE PUBLICATION ENTITLED "2011 MARYLAND STANDARDS AND SPECIFICATIONS FOR EROSION AND SEDIMENT CONTROL".

CONTRACTOR SHALL INSPECT AND MAINTAIN ALL SEDIMENT CONTROL MEASURES AND DEVICES AFTER EVERY STORM EVENT. MAINTENANCE SHALL INCLUDE, BUT NOT BE LIMITED TO THE REMOVAL OF ALL ACCUMULATED SEDIMENT. GEOTEXTILE FABRIC SHALL BE REPLACED AS NEEDED TO ENSURE PROPER FUNCTION. BID SET

- SE/OP----_____ 10 _____ _____9 ____ _____ 10 _____ _____ 9 _____ F i _{SIP} COIP LJ FI \square TSOS

CONTRACTOR SHALL ONLY DISTURB THAT AREA WHICH CAN BE COMPLETED AND STABILIZED BY THE END OF

A) PERMANENT SEED AND SOIL STABILIZATION MATTING OR SOD FOR ALL STEEP SLOPES, CHANNELS

1) CONTRACTOR SHOULD OPEN ONLY THAT SECTION OF TRENCH THAT CAN BE BACKFILLED AND STABILIZED EACH DAY. IF TRENCH MUST REMAIN OPEN LONGER THAN ONE DAY, SILT FENCE SHALL BE

3) ANY SEDIMENT CONTROLS DISTURBED BY UTILITY CONSTRUCTION ARE TO BE REPAIRED IMMEDIATELY


CONTRACTOR SHALL INSPECT AND MAINTAIN ALL SEDIMENT CONTROL MEASURES AND DEVICES AFTER EVERY STORM EVENT. MAINTENANCE SHALL INCLUDE, BUT NOT BE LIMITED TO THE REMOVAL OF ALL ACCUMULATED

THE CONTRACTOR IS RESPONSIBLE FOR PUMPING ALL STANDING WATER THROUGH A FILTERING DEVICE TO A

ANNE ARUNDEL COUNTY


DEPARTMENT OF PUBLIC WORKS


DEFARINIENT OF FUDLIG WORKS				
DATE	APPROVED DATE	SCALE: 1" = 50'	DEALE COMMUNITY PARK	
		DRAWN BY: R.S.S.		
	PROJECT MANAGER	CHECKED BY: R.W.H.		
DATE	APPROVED DATE	SHEET NO. 29 OF 47	EROSION AND SEDIMENT CONTROL PLAN	
		PROJECT NO.: P582001	PHASE #1	
GINEER	CHIEF, RIGHT-OF-WAY	CONTRACT NO.: P582001		

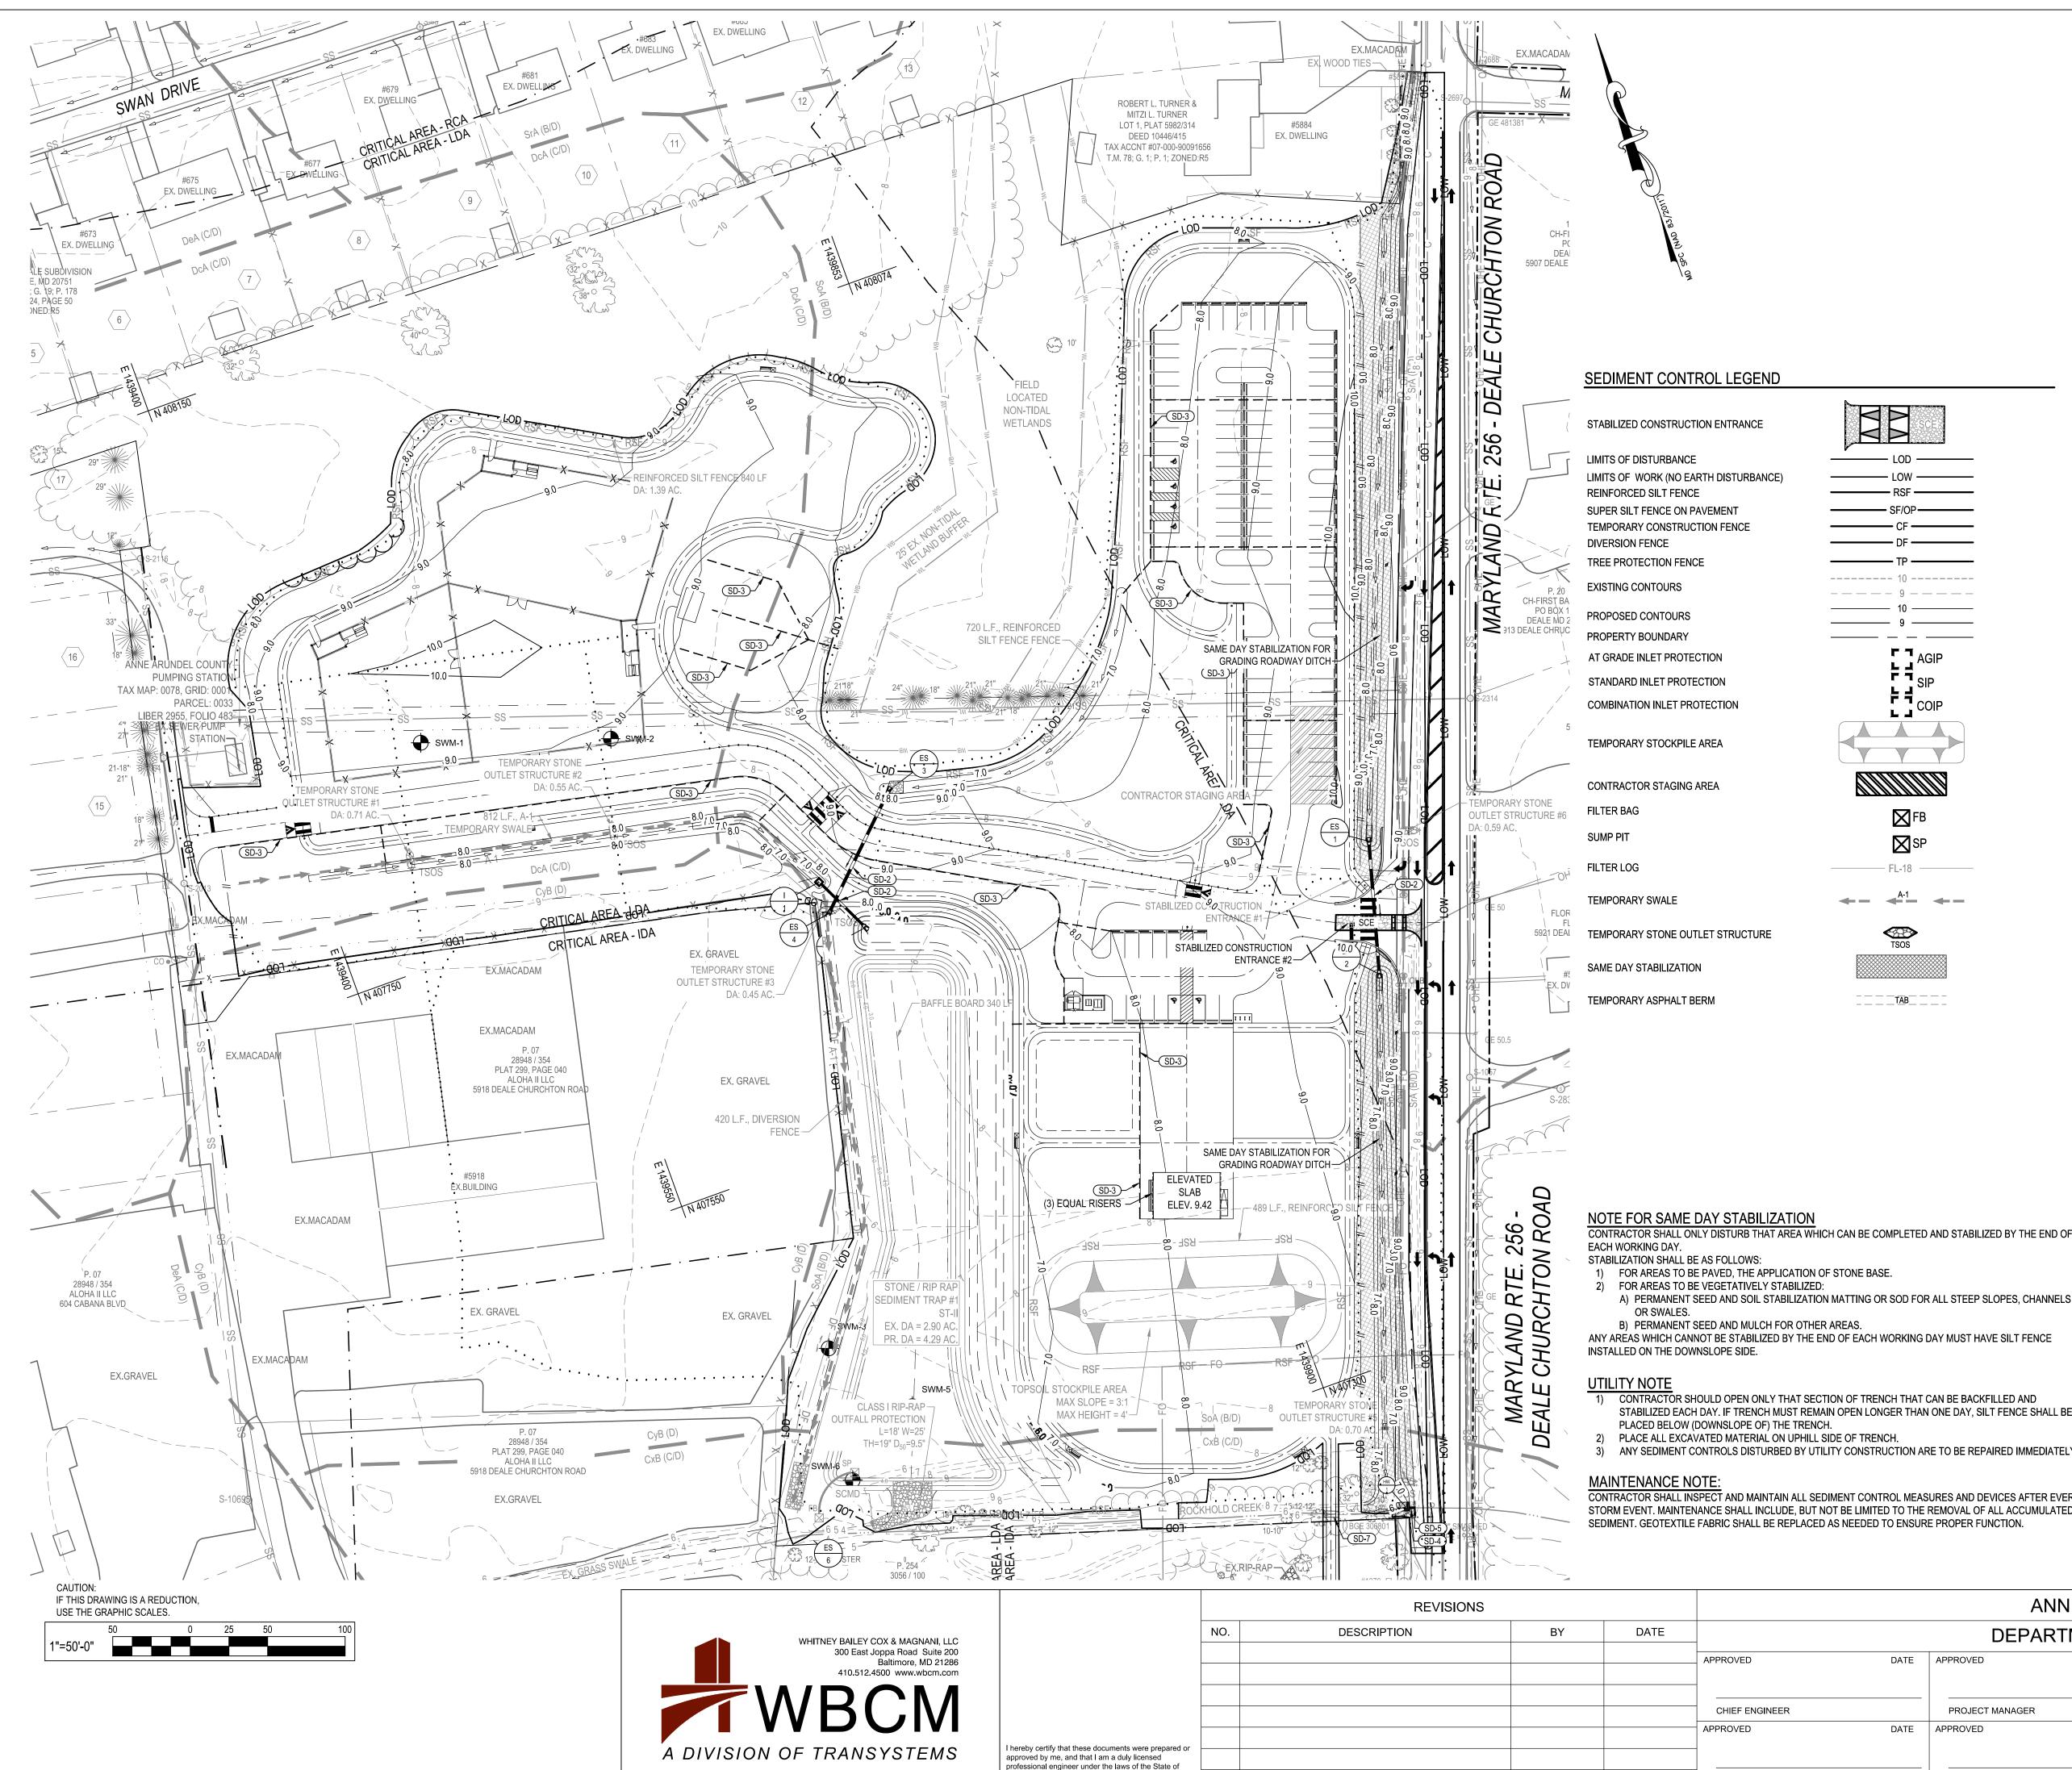

professional engineer under the laws of the State of Maryland. _icense #27734 Expiration Date: 07/12/2024

ASSISTANT CHIEF ENGIN

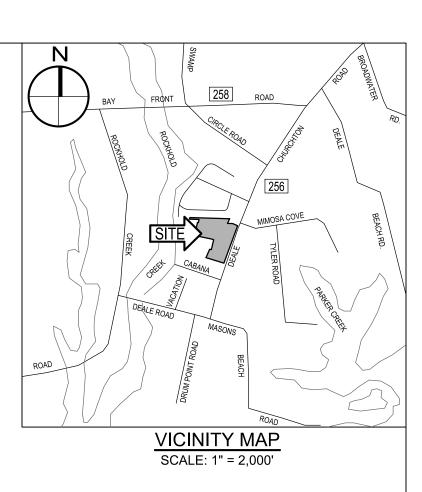

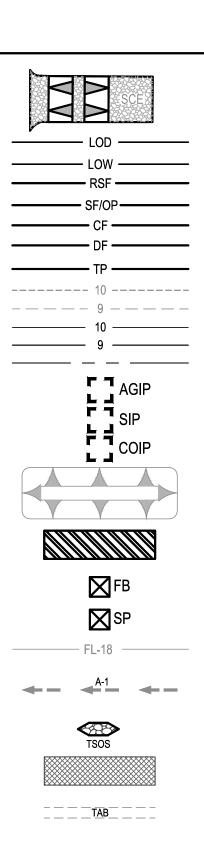

SEQUENCE OF CONSTRUCTION:

FINAL PHASE:

- 1. COMPLETE MASS GRADING AND BEGIN INSTALLATION OF PARKING LOT, TRAIL AND SIDEWALK PAVING.
- 2. INSTALL PROPOSED THREE CULVERTS AT LOCATION OF PROPOSED DRIVEWAY AND DRIVEWAY
- ENTRANCE. PERFORM SAME DAY STABILIZATION FOR FOR THE GRADING AT THE ROADWAY DITCH. 3. FINISH FINE GRADING THE SITE AND UPON COMPLETION OF PAVING AND TRAIL INSTALLATION AND DURING A NOAA 3-DAY DRY FORECASTED PERIOD, STABILIZE ANY REMAINING DISTURBED AREAS
- AS REQUIRED. 4. ONCE UPSTREAM AREAS ARE 95% STABILIZED, DEWATER SEDIMENT TRAP USING AASCE APPROVED DEVICE. CONVERT AND REGRADE TRAP INTO SGW AND INSTALL FOREBAY. CONVERT THE OUTFALL WIER OPENNING INTO SGW OUTFALL WEIR. INSTALL SWM SYSTEMS, CONTROL STRUCTURE AND DEVICES AND/OR PLANTINGS. REFER TO SWM SHEETS FOR SGW PLAN AND DETAILS. (SEDIMENT IS TO BE PREVENTED FROM ENTERING SWM SYSTEMS DURING CONSTRUCTION. THE ENGINEER MUST CERTIFY SWM INSTALLATION.
- REMOVE ANY REMAINING SEDIMENT CONTROLS AFTER PRIOR APPROVAL FROM ANNE ARUNDEL COUNTY INSPECTIONS AND PERMITS DIVISION. FINE GRADE AND STABILIZE AREA FORMERLY OCCUPIED BY PERIMETER CONTROLS.

STORMDRAIN NOTES

- SD-1 NEW 6" PERFORATED SCH 40 PVC PIPE.
- SD-2 NEW 14" x 23" HERCP PIPE. SD-3 NEW 4" PERFORATED UNDER DRAIN.
- SD-4 NEW 15" CMP.
- SD-5 NEW DISSIMILAR MAR MAC PIPE COUPLER. SD-6 NEW 18" HDPE.
- SD-7 NEW 24"x48" REINF. CONCRETE BOX CULVERT

GRADING LEGEND

NEW END SECTION	
NEW RISER STRUCTURE	
FLOW ARROW	
NEW STORM DRAIN	
NEW UNDER DRAIN	
NEW CLEAN OUT	CO #
NEW RISER STRUCTURE	RS #
NEW END SECTION	ES #
NEW OBSERVATION WELL	OB #
NEW SINGLE TYPE Y INLET	

A) PERMANENT SEED AND SOIL STABILIZATION MATTING OR SOD FOR ALL STEEP SLOPES, CHANNELS

ANY AREAS WHICH CANNOT BE STABILIZED BY THE END OF EACH WORKING DAY MUST HAVE SILT FENCE

1) CONTRACTOR SHOULD OPEN ONLY THAT SECTION OF TRENCH THAT CAN BE BACKFILLED AND STABILIZED EACH DAY. IF TRENCH MUST REMAIN OPEN LONGER THAN ONE DAY, SILT FENCE SHALL BE

3) ANY SEDIMENT CONTROLS DISTURBED BY UTILITY CONSTRUCTION ARE TO BE REPAIRED IMMEDIATELY.

CONTRACTOR SHALL INSPECT AND MAINTAIN ALL SEDIMENT CONTROL MEASURES AND DEVICES AFTER EVERY STORM EVENT. MAINTENANCE SHALL INCLUDE, BUT NOT BE LIMITED TO THE REMOVAL OF ALL ACCUMULATED

STANDARD STABILIZATION NOTE:

FOLLOWING INITIAL SOIL DISTURBANCE OR REDISTURBANCE, PERMANENT OR TEMPORARY STABILIZATION SHALL BE COMPLETED WITHIN THREE (3) CALENDAR DAYS AS TO THE SURFACE OF ALL PERIMETER CONTROLS, DIKES, SWALES, DITCHES, PERIMETER SLOPES, AND ALL SLOPES GREATER THAN 3 HORIZONTAL TO 1 VERTICAL (3:1); AND SEVEN DAYS (7) AS TO ALL OTHER DISTURBED OR GRADED AREAS ON THE PROJECT SITE."

MAINTENANCE OF SEDIMENT CONTROL

CONTRACTOR SHALL WITHOUT EXTRA COST TO THE PROJECT, REPAIR AND MAINTAIN EXISTING SEDIMENT CONTROL DEVICES UNTIL ALL AREAS WITHIN LIMITS OF CONSTRUCTION ARE STABILIZED. ALL SEDIMENT CONTROL MEASURES REFERRED TO ON THESE PLANS SHALL BE IN ACCORDANCE WITH THE PUBLICATION ENTITLED "2011 MARYLAND STANDARDS AND SPECIFICATIONS FOR EROSION AND SEDIMENT CONTROL".

CONTRACTOR SHALL INSPECT AND MAINTAIN ALL SEDIMENT CONTROL MEASURES AND DEVICES AFTER EVERY STORM EVENT. MAINTENANCE SHALL INCLUDE, BUT NOT BE LIMITED TO THE REMOVAL OF ALL ACCUMULATED SEDIMENT. GEOTEXTILE FABRIC SHALL BE REPLACED AS NEEDED TO ENSURE PROPER FUNCTION.

THE CONTRACTOR IS RESPONSIBLE FOR PUMPING ALL STANDING WATER THROUGH A FILTERING DEVICE TO A CLEAR WATER OUTFALL WITHIN 24 HOURS OF A STORM EVENT. BID SET

DEPARTMENT OF PUBLIC WORKS				
DATE	APPROVED DATE	SCALE: 1" = 50'	DEALE COMMUNITY PARK	
		DRAWN BY: R.S.S.		
	PROJECT MANAGER	CHECKED BY: R.W.H.		
DATE	APPROVED DATE	SHEET NO. 30 OF 47	EROSION AND SEDIMENT CONTROL PLAN	
		PROJECT NO.: P582001	PHASE #2	
GINEER	CHIEF, RIGHT-OF-WAY	CONTRACT NO.: P582001		

2018 VEGETATIVE ESTABLISHMENT

FOLLOWING INITIAL SOIL DISTURBANCES OR REDISTURBANCE, PERMANENT OR TEMPORARY STABILIZATION SHALL BE COMPLETED WITHIN THREE CALENDAR DAYS FOR THE SURFACE OF ALL PERIMETER CONTROLS, DIKES, SWALES, DITCHES, PERIMETER SLOPES, AND ALL SLOPES GREATER THAN 3 HORIZONTAL TO 1 VERTICAL (3:1) AND SEVEN DAYS FOR ALL OTHER DISTURBED OR GRADED AREAS ON THE PROJECT SITE.

- 1. PERMANENT SEEDING:
- A. SOIL TESTS: LIME AND FERTILIZER WILL BE APPLIED PER SOIL TESTS RESULTS FOR SITES GREATER THAN 5 ACRES. SOIL TESTS WILL BE DONE AT COMPLETION OF INITIAL ROUGH GRADING OR AS RECOMMENDED BY THE SEDIMENT CONTROL INSPECTOR. RATES AND ANALYSES WILL BE PROVIDED TO THE GRADING INSPECTOR AS WELL AS THE CONTRACTOR. OCCURRENCE OF ACID SULFATE SOILS (GRAYISH BLACK COLOR) WILL REQUIRE COVERING WITH A MINIMUM OF 12 INCHES OF CLEAN SOIL WITH 6 INCHES MINIMUM CAPPING OF TOP SOIL. NO STOCKPILING OF MATERIAL IS ALLOWED. IF NEEDED, SOIL TESTS SHOULD BE DONE BEFORE AND AFTER A 6-WEEK INCUBATION PERIOD TO ALLOW OXIDATION OF SULFATES. THE MINIMUM SOIL CONDITIONS REQUIRED FOR PERMANENT VEGETATIVE ESTABLISHMENT ARE:
- a. SOIL PH SHALL BE BETWEEN 6.0 AND 7.0.
- b. SOLUBLE SALTS SHALL BE LESS THAN 500 PARTS PER MILLION (PPM).
- c. THE SOIL SHALL CONTAIN LESS THAN 40% CLAY BUT ENOUGH FINE GRAINED MATERIAL (> 30% SILT PLUS clay) TO PROVIDE THE CAPACITY TO HOLD A MODERATE AMOUNT OF MOISTURE. AN EXCEPTION IS IF LOVEGRASS OR SERECIA LESPEDEZA IS TO BE PLANTED, THEN A SANDY SOIL (< 30% SILT PLUS CLAY) WOULD BE ACCEPTABLE.
- d. SOIL SHALL CONTAIN 1.5% MINIMUM ORGANIC MATTER BY WEIGHT.
- e. SOIL MUST CONTAIN SUFFICIENT PORE SPACE TO PERMIT ADEQUATE ROOT PENETRATION.
- f. IF THESE CONDITIONS CANNOT BE MET BY SOILS ON SITE, ADDING TOPSOIL IS REQUIRED IN ACCORDANCE WITH THE STANDARD AND SPECIFICATION FOR SOIL PREPARATION, TOPSOILING AND SOIL AMENDMENTS FROM THE 2011 MARYLAND STANDARDS AND SPECIFICATIONS FOR SOIL EROSION AND SEDIMENT CONTROL OR AMENDMENTS MADE AS RECOMMENDED BY A CERTIFIED AGRONOMIST.
- B. SEEDBED PREPARATION: AREA TO BE SEEDED SHALL BE LOOSE AND FRIABLE TO A DEPTH OF AT LEAST 3-5 INCHES. THE TOP LAYER SHALL BE LOOSENED BY RAKING, DISKING OR OTHER ACCEPTABLE MEANS BEFORE SEEDING OCCURS. FOR SITES LESS THAN 5 ACRES, APPLY 100 POUNDS DOLOMITIC LIMESTONE AND 21 POUNDS OF 10-10-10 FERTILIZER PER 1,000 SQUARE FEET. HARROW OR DISK LIME AND FERTILIZER INTO THE SOIL TO A DEPTH OF AT LEAST 3-5 INCHES ON SLOPES FLATTER THAN 3:1.
- C. SEEDING: APPLY 5-6 POUNDS PER 1,000 SQUARE FEET OF TALL FESCUE BETWEEN FEBRUARY 1 AND APRIL 30 OR BETWEEN AUGUST 15 AND OCTOBER 31. APPLY SEED UNIFORMLY ON A MOIST FIRM SEEDBED WITH A CYCLONE SEEDER, CULTIPACKER SEEDER OR HYDROSEEDER (SLURRY INCLUDES SEEDS AND FERTILIZER, RECOMMENDED ON STEEP SLOPES ONLY). MAXIMUM SEED DEPTH SHOULD BE 1/4 INCH IN CLAYEY SOILS AND ½ INCH IN SANDY SOILS WHEN USING OTHER THAN THE HYDROSEEDER METHOD. IRRIGATE WHERE NECESSARY TO SUPPORT ADEQUATE GROWTH UNTIL VEGETATION IS FIRMLY ESTABLISHED. IF OTHER SEED MIXES ARE TO BE USED, SELECT FROM TABLE B3 AND B5 OF THE 2011 MARYLAND STANDARDS AND SPECIFICATIONS FOR SOIL EROSION AND SEDIMENT CONTROL.
- D. MULCHING: MULCH SHALL BE APPLIED TO ALL SEEDED AREAS IMMEDIATELY AFTER SEEDING. DURING THE TIME PERIODS WHEN SEEDING IS NOT PERMITTED, MULCH SHALL BE APPLIED IMMEDIATELY AFTER GRADING. MULCH SHALL BE UNROTTED, UNCHOPPED, SMALL GRAIN STRAW APPLIED AT A RATE OF 2 TONS PER ACRE OR 90 POUNDS PER 1,000 SQUARE FEET (2 BALES). APPLY MULCH TO ACHIEVE A UNIFORM DISTRIBUTION AND DEPTH SO THAT THE SOIL SURFACE IS NOT EXPOSED. IF A MULCH-ANCHORING TOOL IS USED, APPLY 2.5 TONS PER ACRE. MULCH MATERIALS SHALL BE RELATIVELY FREE OF ALL KINDS OF WEEDS AND SHALL BE COMPLETELY FREE OF PROHIBITED NOXIOUS WEEDS. SPREAD MULCH UNIFORMLY, MECHANICALLY OR BY HAND, TO A DEPTH OF 1-2 INCHES.
- . SECURING STRAW MULCH: STRAW MULCH SHALL BE SECURED IMMEDIATELY FOLLOWING MULCH APPLICATION TO MINIMIZE MOVEMENT BY WIND OR WATER. THE FOLLOWING METHODS ARE PERMITTED:
- i. USE A MULCH-ANCHORING TOOL WHICH IS DESIGNED TO PUNCH AND ANCHOR MULCH INTO THE SOIL SURFACE TO A MINIMUM DEPTH OF 2 INCHES. THIS IS THE MOST EFFECTIVE METHOD FOR SECURING MULCH, HOWEVER, IT IS LIMITED TO RELATIVELY FLAT AREAS WHERE EQUIPMENT CAN OPERATE SAFELY.
- ii. WOOD CELLULOSE FIBER MAY BE USED FOR ANCHORING STRAW. APPLY THE FIBER BINDER AT A NET DRY WEIGHT OF 750 POUNDS PER ACRE. IF MIXED WITH WATER, USE 50 POUNDS OF WOOD CELLULOSE FIBER PER 100 GALLONS OF WATER.
- iii. LIQUID BINDERS MAY BE USED. APPLY AT HIGHER RATES AT THE EDGES WHERE WIND CATCHES MULCH, SUCH AS IN VALLEYS AND ON CRESTS OF SLOPES. THE REMAINDER OF THE AREA SHOULD APPEAR UNIFORM AFTER BINDER APPLICATION. BINDERS LISTED IN THE 2011 MARYLAND STANDARDS AND SPECIFICATIONS FOR SOIL EROSION AND SEDIMENT CONTROL OR APPROVED EQUAL SHALL BE APPLIED AT RATES RECOMMENDED BY THE MANUFACTURERS.
- iv. LIGHTWEIGHT PLASTIC NETTING MAY BE USED TO SECURE MULCH. THE NETTING WILL BE STAPLED TO THE GROUND ACCORDING TO MANUFACTURER'S RECOMMENDATIONS.
- 2. TEMPORARY SEEDING:

LIME: 100 POUNDS OF DOLOMITIC LIMESTONE PER 1,000 SQUARE FEET.

FERTILIZER: 15 POUNDS OF 10-10-10 PER 1,000 SQUARE FEET.

SEED: PERENNIAL RYE - 0.92 POUNDS PER 1,000 SQUARE FEET (FEBRUARY 1 THROUGH APRIL 30 OR AUGUST 15 THROUGH OCTOBER 31). MILLET - 0.92 POUNDS PER 1,000 SQUARE FEET (MAY 1 THROUGH AUGUST 15).

MULCH: SAME AS 1 D AND E ABOVE.

3. NO FILLS MAY BE PLACED ON FROZEN GROUND. ALL FILL IS TO BE PLACED IN APPROXIMATELY HORIZONTAL LAYERS, EACH LAYER HAVING A LOOSE THICKNESS OF NOT MORE THAN 8 INCHES. ALL COMPACTION REQUIREMENTS ARE IN ACCORDANCE TO ANNE ARUNDEL COUNTY STANDARD SPECIFICATIONS FOR CONSTRUCTION AS WELL AS THE AA COUNTY DESIGN MANUAL AND STANDARD DETAILS. FILLS FOR POND EMBANKMENTS SHALL BE COMPACTED AS PER MD-378 CONSTRUCTION SPECIFICATIONS. ALL OTHER FILLS SHALL BE COMPACTED SUFFICIENTLY SO AS TO BE STABLE AND PREVENT EROSION AND SLIPPAGE.

4. PERMANENT SOD:

INSTALLATION OF SOD SHOULD FOLLOW PERMANENT SEEDING DATES. SEEDBED PREPARATION FOR SOD SHALL BE AS NOTED IN SECTION (B) ABOVE. PERMANENT SOD IS TO BE TALL FESCUE, STATE APPROVED SOD; LIME AND FERTILIZER PER PERMANENT SEEDING SPECIFICATIONS AND LIGHTLY IRRIGATE SOIL PRIOR TO LAYING SOD. SOD IS TO BE LAID ON THE CONTOUR WITH ALL ENDS TIGHTLY ABUTTING. JOINTS ARE TO BE STAGGERED BETWEEN ROWS. WATER AND ROLL OR TAMP SOD TO INSURE POSITIVE ROOT CONTACT WITH THE SOIL. ALL SLOPES STEEPER THAN 3:1, AS SHOWN, ARE TO BE PERMANENTLY SODDED OR PROTECTED WITH AN APPROVED EROSION CONTROL NETTING. ADDITIONAL WATERING FOR ESTABLISHMENT MAY BE REQUIRED. SOD IS NOT TO BE INSTALLED ON FROZEN GROUND. SOD SHALL NOT BE TRANSPLANTED WHEN MOISTURE CONTENT (DRY OR WET) AND/OR EXTREME TEMPERATURE MAY ADVERSELY AFFECT ITS SURVIVAL. IN THE ABSENCE OF ADEQUATE RAINFALL, IRRIGATION SHOULD BE PERFORMED TO ENSURE ESTABLISHMENT OF SOD.


MINING OPERATIONS:

SEDIMENT CONTROL PLANS FOR MINING OPERATIONS MUST INCLUDE THE FOLLOWING SEEDING DATES AND MIXTURES: FOR SEEDING DATES OF FEBRUARY 1 THROUGH APRIL 30 AND AUGUST 15 THROUGH OCTOBER 31, USE SEED MIXTURE OF TALL FESCUE AT THE RATE OF 2 POUNDS PER 1,000 SQUARE FEET AND SERICEA LESPEDEZA AT THE MINIMUM RATE OF 0.5 POUNDS PER 1,000 SQUARE FEET.

- TOPSOIL SHALL BE APPLIED AS PER THE STANDARD AND SPECIFICATIONS FOR SOIL PREPARATION, TOPSOILING, AND SOIL AMENDMENTS FROM THE 2011 MARYLAND STANDARDS AND SPECIFICATIONS FOR SOIL EROSION AND SEDIMENT CONTROL.
- USE OF THESE VEGETATIVE ESTABLISHMENT SPECIFICATIONS DOES NOT PRECLUDE THE PERMITTEE OR CONTRACTOR FROM MEETING ALL OF THE REQUIREMENTS SET FORTH IN THE 2011 MARYLAND STANDARDS AND SPECIFICATIONS FOR SOIL EROSION AND SEDIMENT CONTROL.

- 2. <u>MINING OPERATIONS:</u>

1. TEMPORARY STABILIZATION 2. PERMANENT STABILIZATION I. SOIL PH BETWEEN 6.0 AND 7.0.

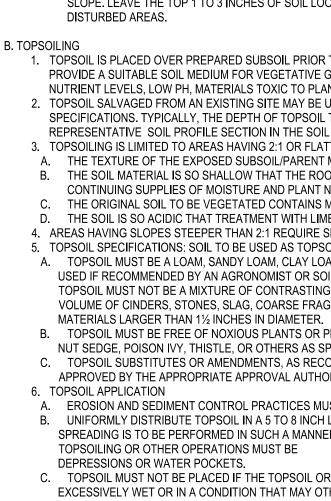



INSTALLATION OF SOD SHOULD FOLLOW PERMANENT SEEDING DATES. PERMANENT SOD IS TO BE TALL FESCUE, MARYLAND APPROVED SOD; LIME AND FERTILIZER PER PERMANENT SEEDING SPECIFICATIONS AND LIGHTLY IRRIGATE SOIL PRIOR TO LAYING SOD. SOD IS TO BE LAID ON THE CONTOUR WITH ALL ENDS TIGHTLY ABUTTING. JOINTS ARE TO BE STAGGERED BETWEEN ROWS. WATER AND ROLL OR TAMP SOD TO INSURE POSITIVE ROOF CONTACT WITH THE SOIL. ALL SLOPES STEEPER THAN 3:1, ARE TO BE PERMANENTLY SODDED OR PROTECTED WITH AN APPROVED EROSION CONTROL NETTING. ADDITIONAL WATERING FOR ESTABLISHMENT MAY BE REQUIRED. SOD IS NOT TO BE APPLIED ON FROZEN GROUND. SOD SHALL NOT BE HARVESTED OR TRANSPLANTED WHEN MOISTURE CONTENT (DRY OR WET) AND/OR EXTREME TEMPERATURE MAY ADVERSELY AFFECT ITS SURVIVAL. IN THE ABSENCE OF ADEQUATE RAINFALL, IRRIGATION SHOULD BE PERFORMED TO INSURE ESTABLISHED SOD.

SEDIMENT CONTROL PLANS FOR MINING OPERATIONS MUST INCLUDE THE FOLLOWING

NOTE: USE OF THIS INFORMATION DOES NOT PRECLUDE MEETING ALL OF THE REQUIREMEN SPECIFICATIONS FOR SOIL EROSION AND SEDIMENT CONTROL."


SOIL PREPARATION, TOPSOILING, AND SOIL AMENDMENTS

A. SOIL PREPARATION

C. SOIL AMENDMENTS (FERTILIZER AND LIME SPECIFICATIONS)

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Baltimore, MD 21286				
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BCM				
NSYSTEMS				

NING OPERATIONS:						
EDIMENT CONTROL PLANS FOR MINING OPERATIONS MUST INCLUDE THE FOLLOWING SEEDING DATES	S AND MIXTURES:					
OR SEEDING DATES OF FEBRUARY 1 THROUGH APRIL 30 AND AUGUST 15 THROUGH OCTOBER 31 USE IE RATE OF 2 POUNDS PER 1,000 SQUARE FEET AND SERICEA LESPEDEZA AT THE RATE OF 0.5 POUNI				stake elevation directly	Protective cap required 1½" Dla (see detall)	. SCH40 PVC cap
OR SEEDING DATES OF MAY 1 THROUGH AUGUST 14 USE SEED MIXTURE OF TALL FESCUE AT THE RAT EET AND WEEPING LOVEGRASS AT THE RATE OF 0.1 POUND PER 1,000 SQUARE FEET.	E OF 2 POUNDS PER 1,000 SQUARE			onto the marker	1½" to 2	PVC pipe
OPSOIL SHALL BE APPLIED AS PER THE STANDARD AND SPECIFICATIONS FOR SOIL PREPARATION, TO ROM THE 2011 MARYLAND STANDARDS AND SPECIFICATIONS FOR SOIL EROSION AND SEDIMENT CON				1' Indicator mark	or as pe	er manufacturers'
USE OF THIS INFORMATION DOES NOT PRECLUDE MEETING ALL OF THE REQUIREMENTS OF THE "201 ICATIONS FOR SOIL EROSION AND SEDIMENT CONTROL."	1 MARYLAND STANDARDS AND			6" indicator mark & ₹	-	CAP DETAIL NOT TO SCALE el and mark 1' increments
PREPARATION, TOPSOILING, AND SOIL AMENDMENTS						a 1" wide band of highly ble color paint
DIL PREPARATION					Ŧ	
 IL FREPARATION TEMPORARY STABILIZATION A. SEEDBED PREPARATION CONSISTS OF LOOSENING SOIL TO A DEPTH OF 3 TO 5 INCHES BY MEAN OR CONSTRUCTION EQUIPMENT, SUCH AS DISC HARROWS OR CHISEL PLOWS OR RIPPERS MOU EQUIPMENT. AFTER THE SOIL IS LOOSENED, IT MUST NOT BE ROLLED OR DRAGGED SMOOTH BU CONDITION. SLOPES 3:1 OR FLATTER ARE TO BE TRACKED WITH RIDGES RUNNING PARALLEL TO B. APPLY FERTILIZER AND LIME AS PRESCRIBED ON THE PLANS. C. INCORPORATE LIME AND FERTILIZER INTO THE TOP 3 TO 5 INCHES OF SOIL BY DISKING OR OTHE PERMANENT STABILIZATION A. A SOIL TEST IS REQUIRED FOR ANY EARTH DISTURBANCE OF 5 ACRES OR MORE. THE MINIMUM 3 	NTED ON CONSTRUCTION T LEFT IN THE ROUGHENED THE CONTOUR OF THE SLOPE. R SUITABLE MEANS.			Provide existing ground elevation		k 6" increments with a ¼" e band of highly visible or paint
 A. A SOIL TEST IS REQUIRED FOR ANY EARTH DISTORBANCE OF SACRES OR MORE. THE MINIMUM S FOR PERMANENT VEGETATIVE ESTABLISHMENT ARE: SOIL PH BETWEEN 6.0 AND 7.0. SOLUBLE SALTS LESS THAN 500 PARTS PER MILLION (PPM). SOIL CONTAINS LESS THAN 40 PERCENT CLAY BUT ENOUGH FINE GRAINED MATERIAL (GRE PLUS CLAY) TO PROVIDE THE CAPACITY TO HOLD A MODERATE AMOUNT OF MOISTURE. AN WILL BE PLANTED, THEN A SANDY SOIL (LESS THAN 30 PERCENT SILT PLUS CLAY) WOULD E IV. SOIL CONTAINS 1.5 PERCENT MINIMUM ORGANIC MATTER BY WEIGHT. SOIL CONTAINS SUFFICIENT PORE SPACE TO PERMIT ADEQUATE ROOT PENETRATION. B. APPLICATION OF AMENDMENTS OR TOPSOIL IS REQUIRED IF ON-SITE SOILS DO NOT MEET THE A 	ATER THAN 30 PERCENT SILT EXCEPTION: IF LOVEGRASS 3E ACCEPTABLE.			directly onto marker	NOT	TE: Stake to be placed at the ter of all receiving channels as cted by AASCD
 C. GRADED AREAS MUST BE MAINTAINED IN A TRUE AND EVEN GRADE AS SPECIFIED ON THE APPR OR OTHERWISE LOOSENED TO A DEPTH OF 3 TO 5 INCHES. D. APPLY SOIL AMENDMENTS AS SPECIFIED ON THE APPROVED PLAN OR AS INDICATED BY THE RE MIX SOIL AMENDMENTS INTO THE TOP 3 TO 5 INCHES OF SOIL BY DISKING OR OTHER SUITABLE I SMOOTH THE SURFACE, REMOVE LARGE OBJECTS LIKE STONES AND BRANCHES, AND READY TH APPLICATION. LOOSEN SURFACE SOIL BY DRAGGING WITH A HEAVY CHAIN OR OTHER EQUIPMEN WHERE SITE CONDITIONS WILL NOT PERMIT NORMAL SEEDBED PREPARATION. TRACK SLOPES 3 EQUIPMENT LEAVING THE SOIL IN AN IRREGULAR CONDITION WITH RIDGES RUNNING PARALLEL SLOPE. LEAVE THE TOP 1 TO 3 INCHES OF SOIL LOOSE AND FRIABLE. SEEDBED LOOSENING MAY DISTURBED AREAS. 	SULTS OF A SOIL TEST. MEANS. RAKE LAWN AREAS TO HE AREA FOR SEED NT TO ROUGHEN THE SURFACE 11 OR FLATTER WITH TRACKED TO THE CONTOUR OF THE			2'-6"	anchor plates, with a mini	ed or punched "T" shaped with mum weight of 1.25 pounds an of loose scale with one or sistant paint applied.
SOILING TOPSOIL IS PLACED OVER PREPARED SUBSOIL PRIOR TO ESTABLISHMENT OF PERMANENT VEGETA				<u> </u>		
PROVIDE A SUITABLE SOIL MEDIUM FOR VEGETATIVE GROWTH. SOILS OF CONCERN HAVE LOW MOI NUTRIENT LEVELS, LOW PH, MATERIALS TOXIC TO PLANTS, AND/OR UNACCEPTABLE SOIL GRADATIC TOPSOIL SALVAGED FROM AN EXISTING SITE MAY BE USED PROVIDED IT MEETS THE STANDARDS A SPECIFICATIONS. TYPICALLY, THE DEPTH OF TOPSOIL TO BE SALVAGED FOR A GIVEN SOIL TYPE CA REPRESENTATIVE SOIL PROFILE SECTION IN THE SOIL SURVEY PUBLISHED BY USDA-NRCS. TOPSOILING IS LIMITED TO AREAS HAVING 2:1 OR FLATTER SLOPES WHERE:	NN. S SET FORTH IN THESE			SEDIMENT CONTRO	OL MONITORING DI	EVICE DETAIL
 A. THE TEXTURE OF THE EXPOSED SUBSOIL/PARENT MATERIAL IS NOT ADEQUATE TO PRODUCE VI B. THE SOIL MATERIAL IS SO SHALLOW THAT THE ROOTING ZONE IS NOT DEEP ENOUGH TO SUPPO CONTINUING SUPPLIES OF MOISTURE AND PLANT NUTRIENTS. C. THE ORIGINAL SOIL TO BE VEGETATED CONTAINS MATERIAL TOXIC TO PLANT GROWTH. D. THE SOIL IS SO ACIDIC THAT TREATMENT WITH LIMESTONE IS NOT FEASIBLE. AREAS HAVING SLOPES STEEPER THAN 2:1 REQUIRE SPECIAL CONSIDERATION AND DESIGN. TOPSOIL SPECIFICATIONS: SOIL TO BE USED AS TOPSOIL MUST MEET THE FOLLOWING CRITERIA: A. TOPSOIL MUST BE A LOAM, SANDY LOAM, CLAY LOAM, SUIL LOAM, SANDY LOAM, DESIGN, DESIGN,	RT PLANTS OR FURNISH 7 SAND. OTHER SOILS MAY BE					
 USED IF RECOMMENDED BY AN AGRONOMIST OR SOIL SCIENTIST AND APPROVED BY THE APPROF TOPSOIL MUST NOT BE A MIXTURE OF CONTRASTING TEXTURED SUBSOILS AND MUST CONTAIN LI VOLUME OF CINDERS, STONES, SLAG, COARSE FRAGMENTS, GRAVEL, STICKS, ROOTS MATERIALS LARGER THAN 1½ INCHES IN DIAMETER. TOPSOIL MUST BE FREE OF NOXIOUS PLANTS OR PLANT PARTS SUCH AS BERMUDA GRASS, QU/ NUT SEDGE, POISON IVY, THISTLE, OR OTHERS AS SPECIFIED. TOPSOIL SUBSTITUTES OR AMENDMENTS, AS RECOMMENDED BY A QUALIFIED AGRONOMIST OR APPROVED BY THE APPROPRIATE APPROVAL AUTHORITY, MAY BE USED IN LIEU OF NATURAL TOP 	ESS THAN 5 PERCENT BY 5, TRASH, OR OTHER ACK GRASS, JOHNSON GRASS, SOIL SCIENTIST AND					
TOPSOIL APPLICATION A. EROSION AND SEDIMENT CONTROL PRACTICES MUST BE MAINTAINED WHEN APPLYING TOPSOIL 3. UNIFORMLY DISTRIBUTE TOPSOIL IN A 5 TO 8 INCH LAYER AND LIGHTLY COMPACT TO A MINIMUM				SITE ANALYSIS		
SPREADING IS TO BE PERFORMED IN SUCH A MANNER THAT SODDING OR IRREGULARITIES IN THE TOPSOILING OR OTHER OPERATIONS MUST BE CORRECTED IN ORDER TO PRE	SURFACE RESULTING FROM		 TOTAL AREA TOTAL DISTU 		8.03 ACRES	NO DISTURBED AREA SHALL BE LEFT
DEPRESSIONS OR WATER POCKETS. C. TOPSOIL MUST NOT BE PLACED IF THE TOPSOIL OR SUBSOIL IS IN A FROZEN OR MUDDY CONDIT EXCESSIVELY WET OR IN A CONDITION THAT MAY OTHERWISE BE DETRIMENTAL TO PROPER GRA					.856 ACRES	UNSTABILIZED OVERNIGHT UNLESS RUNOFF
PREPARATION.			a. TOTAL IMF	PERVIOUS AREA: 4.	.28 ACRES	CONTROL DEVICE
AMENDMENTS (FERTILIZER AND LIME SPECIFICATIONS) SOIL TESTS MUST BE PERFORMED TO DETERMINE THE EXACT RATIOS AND APPLICATION RATES FOF ON SITES HAVING DISTURBED AREAS OF 5 ACRES OR MORE. SOIL ANALYSIS MAY BE PERFORMED B	Y A RECOGNIZED PRIVATE OR		b. TOTAL TO	BE VEGETATIVELY STABILIZED: 4.	576 ACRES	
COMMERCIAL LABORATORY. SOIL SAMPLES TAKEN FOR ENGINEERING PURPOSES MAY ALSO BE US FERTILIZERS MUST BE UNIFORM IN COMPOSITION, FREE FLOWING AND SUITABLE FOR ACCURATE AF EQUIPMENT. MANURE MAY BE SUBSTITUTED FOR FERTILIZER WITH PRIOR APPROVAL FROM THE AP	PLICATION BY APPROPRIATE				.02 ACRES	NOTE TO CONTRACTOR: SEDIMENT AND EROSION CONTROL SHALL BE STRICTLY ENFORCED.
AUTHORITY. FERTILIZERS MUST ALL BE DELIVERED TO THE SITE FULLY LABELED ACCORDING TO THE BEAR THE NAME, TRADE NAME OR TRADEMARK AND WARRANTY OF THE PRODUCER.	IE APPLICABLE LAWS AND MUST		5. ESTIMATED 6. ESTIMATED		755 CU.YDS. 969 CU.YDS.	
LIME MATERIALS MUST BE GROUND LIMESTONE (HYDRATED OR BURNT LIME MAY BE SUBSTITUTED E WHICH CONTAINS AT LEAST 50 PERCENT TOTAL OXIDES (CALCIUM OXIDE PLUS MAGNESIUM OXIDE) TO SUCH FINENESS THAT AT LEAST 50 PERCENT WILL PASS THROUGH A #100 MESH SIEVE AND 98 T	LIMESTONE MUST BE GROUND		NOTE:	FILL. 0,8	909 CO.TD3.	
THROUGH A #20 MESH SIEVE. LIME AND FERTILIZER ARE TO BE EVENLY DISTRIBUTED AND INCORPORATED INTO THE TOP 3 TO 5 IN OTHER SUITABLE MEANS.			WBCM MAKES NO G	QUANTITIES SHOWN HEREON ARE FOR INFORM GUARANTEES OF ACCURACY OF QUANTITIES OF ISIBILITY OF ACTUAL EARTHWORK QUANTITIES	R BALANCE OF SITE. THE CONTRACTOR	SHALL
WHERE THE SUBSOIL IS EITHER HIGHLY ACIDIC OR COMPOSED OF HEAVY CLAYS, SPREAD GROUND I TO 8 TONS/ACRE(200-400 POUNDS PER 1,000 SQUARE FEET) PRIOR TO THE PLACEMENT OF TOPSOIL			DURING CONSTRUC			STANDARD STABILIZATION NOTE
						SOIL DISTURBANCE OR RE-DISTURBANCE.
						MPORARY STABILIZATION MUST BE COMPLETED
			NOTES: 1. EROSION CONTROL MAT SLOPE AREAS 3:1 OR GR	TING SHALL BE INSTALLED ON ALL EATER.	DIKES, SWALES	NDAR DAYS AS TO THE SURFACE OF ALL PERIMETER CONTROLS, 5, DITCHES, PERIMETER SLOPES AND ALL SLOPES GREATER THAN NTAL TO ONE VERTICAL (3:1), AND
			2. FILL SOILS MAY BE AVAIL BORROW AREA PROVIDE PROJECT SPECIFICATION	D THE SOILS MEET THE		NDAR DAYS AS TO ALL OTHER DISTURBED OR GRADED AREAS ON SITE NOT UNDER ACTIVE GRADING.
			SOILS (TOP SOIL AND FIL	RESPONSIBLE FOR PROVIDING L SOIL) MEETING THE PROJECT DN-SITE AND OFF-SITE SOURCES.		BID SET
	REVISIONS			ANNE ARU	 NDEL COUNTY	
WHITNEY BAILEY COX & MAGNANI, LLC	NO. DESCRIPTION	BY DATE	-		OF PUBLIC WORKS	
300 East Joppa Road Suite 200 Baltimore, MD 21286 410.512.4500 www.wbcm.com			_ APPROVED DATE	APPROVED	DATE SCALE: AS SHOWN	DEALE COMMUNITY PARK
VBCM			 CHIEF ENGINEER	PROJECT MANAGER	DRAWN BY: R.S.S. CHECKED BY: R.W.H.	
			APPROVED DATE		DATE SHEET NO. 31 OF 47	
OF TRANSYSTEMS I hereby certify that these documents were prepared or approved by me, and that I am a duly licensed professional engineer under the laws of the State of			-		PROJECT NO.: P582001	EROSION AND SEDIMENT CONTROL NOTES
Maryland. License #27734 Expiration Date: 07/12/2024			ASSISTANT CHIEF ENGINEER	CHIEF, RIGHT-OF-WAY	CONTRACT NO.: P582001	

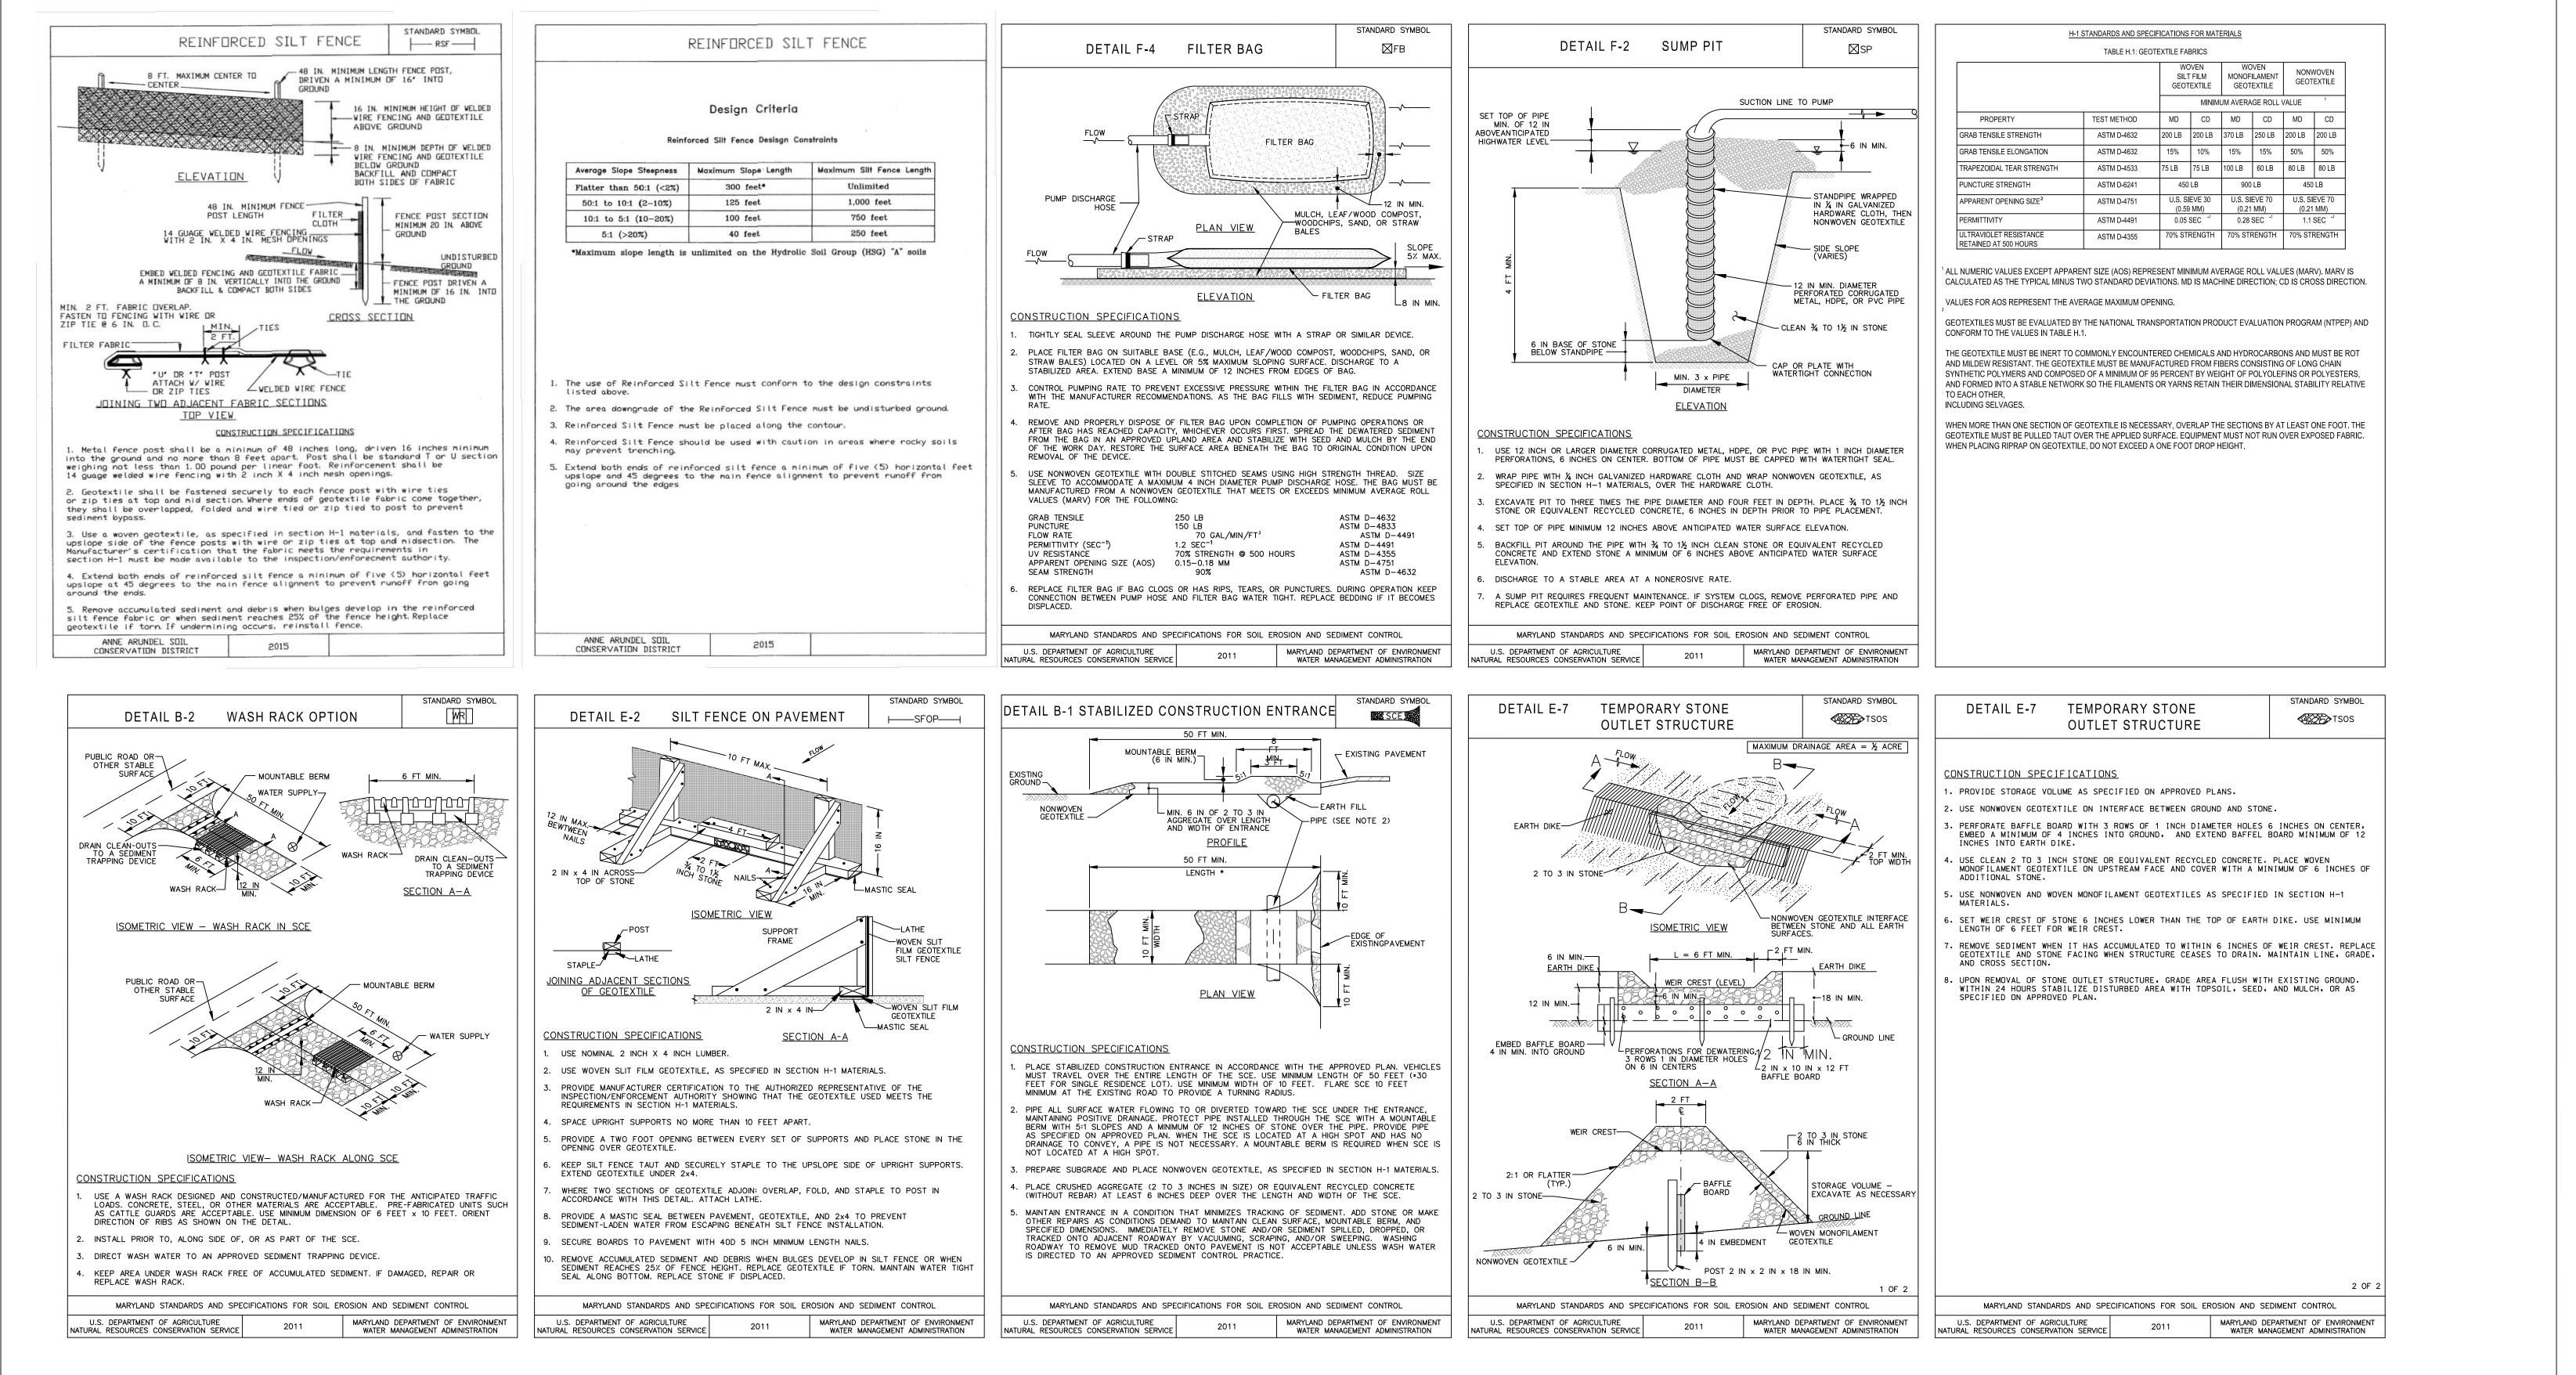




Y BAILEY COX & MAGNANI, LLC	
300 East Joppa Road Suite 200 Baltimore, MD 21286 410.512.4500 www.wbcm.com	
BCM	
PANSYSTEMS	I hereby certify that these documents were p approved by me, and that I am a duly licens professional engineer under the laws of the Marvland.

		REVISIONS				
	NO.	DESCRIPTION	BY	DATE	_	
					APPROVED CHIEF ENGINEER	
I hereby certify that these documents were prepared or approved by me, and that I am a duly licensed professional engineer under the laws of the State of Maryland. License #27734 Expiration Date: 07/12/2024					ASSISTANT CHIEF ENGINE	

ANNE ARUNDEL COUNTY

DEPARTMENT OF PUBLIC WORKS					
DATE	APPROVED DATE	SCALE: AS SHOWN	DEALE COMMUNITY PARK		
		DRAWN BY: R.S.S.			
	PROJECT MANAGER	CHECKED BY: R.W.H.			
DATE	APPROVED DATE	SHEET NO. 32 OF 47	EROSION AND SEDIMENT CONTROL DETAILS		
		PROJECT NO.: P582001	ERUSION AND SEDIMENT CONTROL DETAIL		
NGINEER	CHIEF, RIGHT-OF-WAY	CONTRACT NO.: P582001			

BID SET

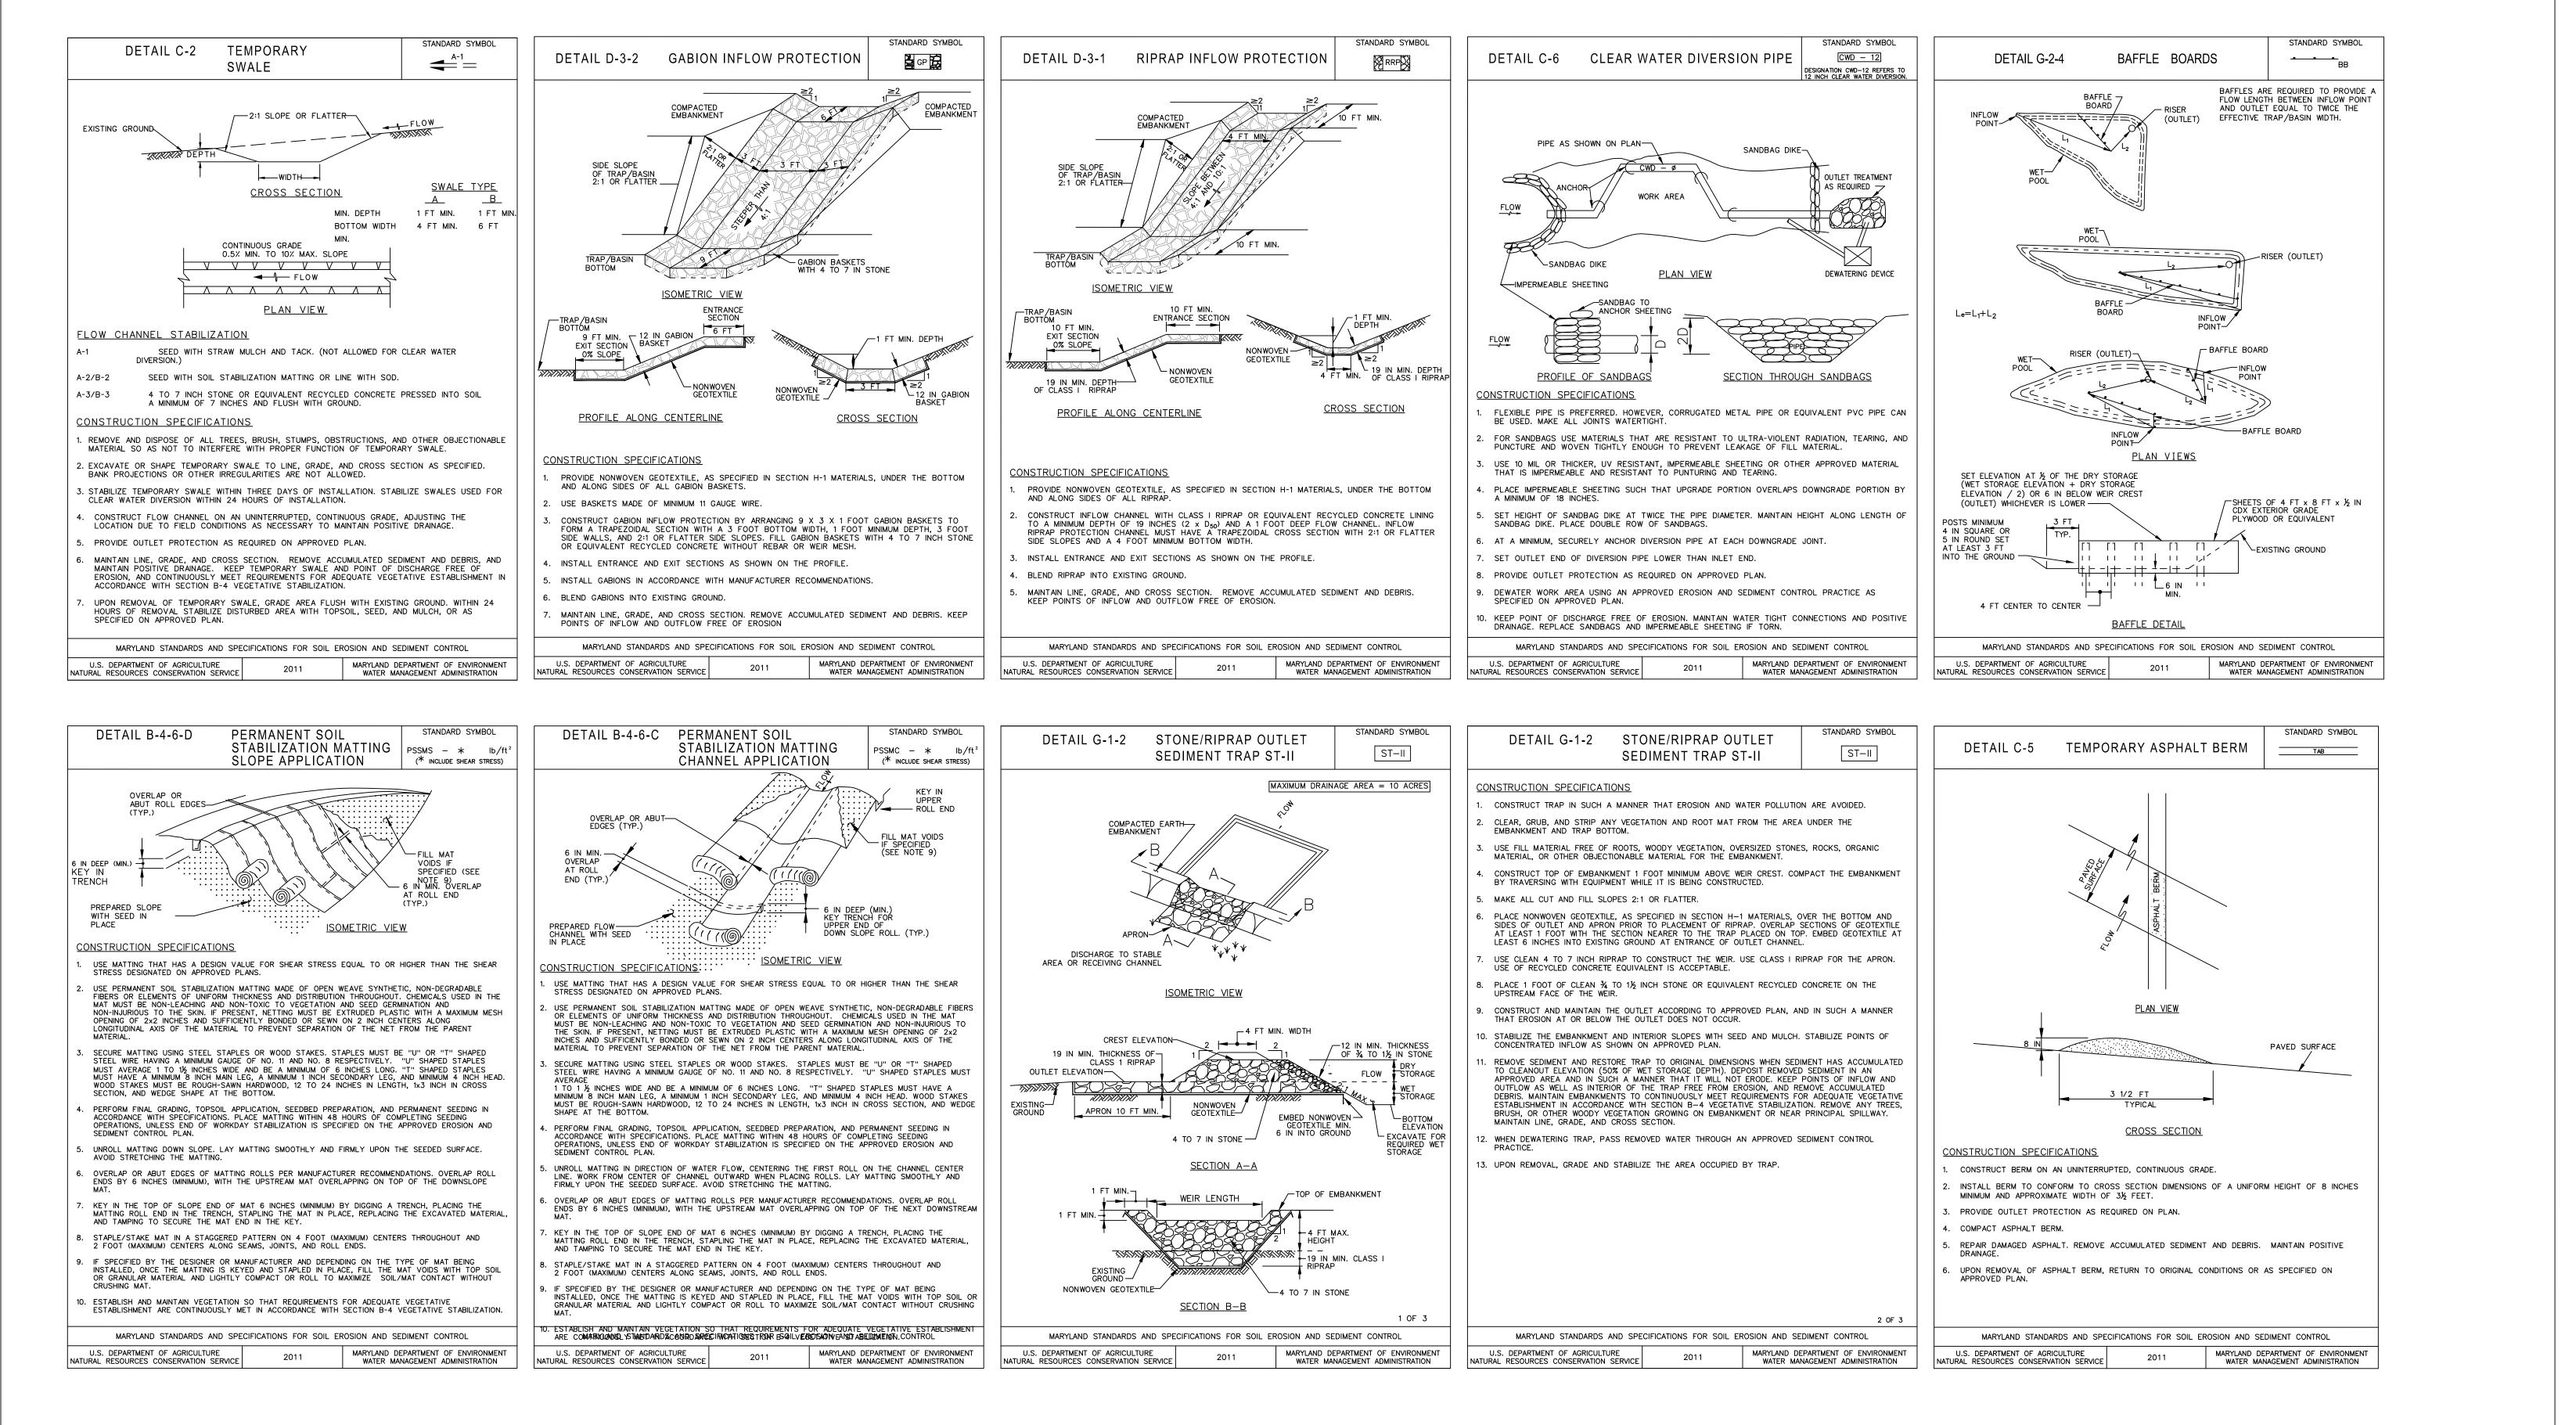



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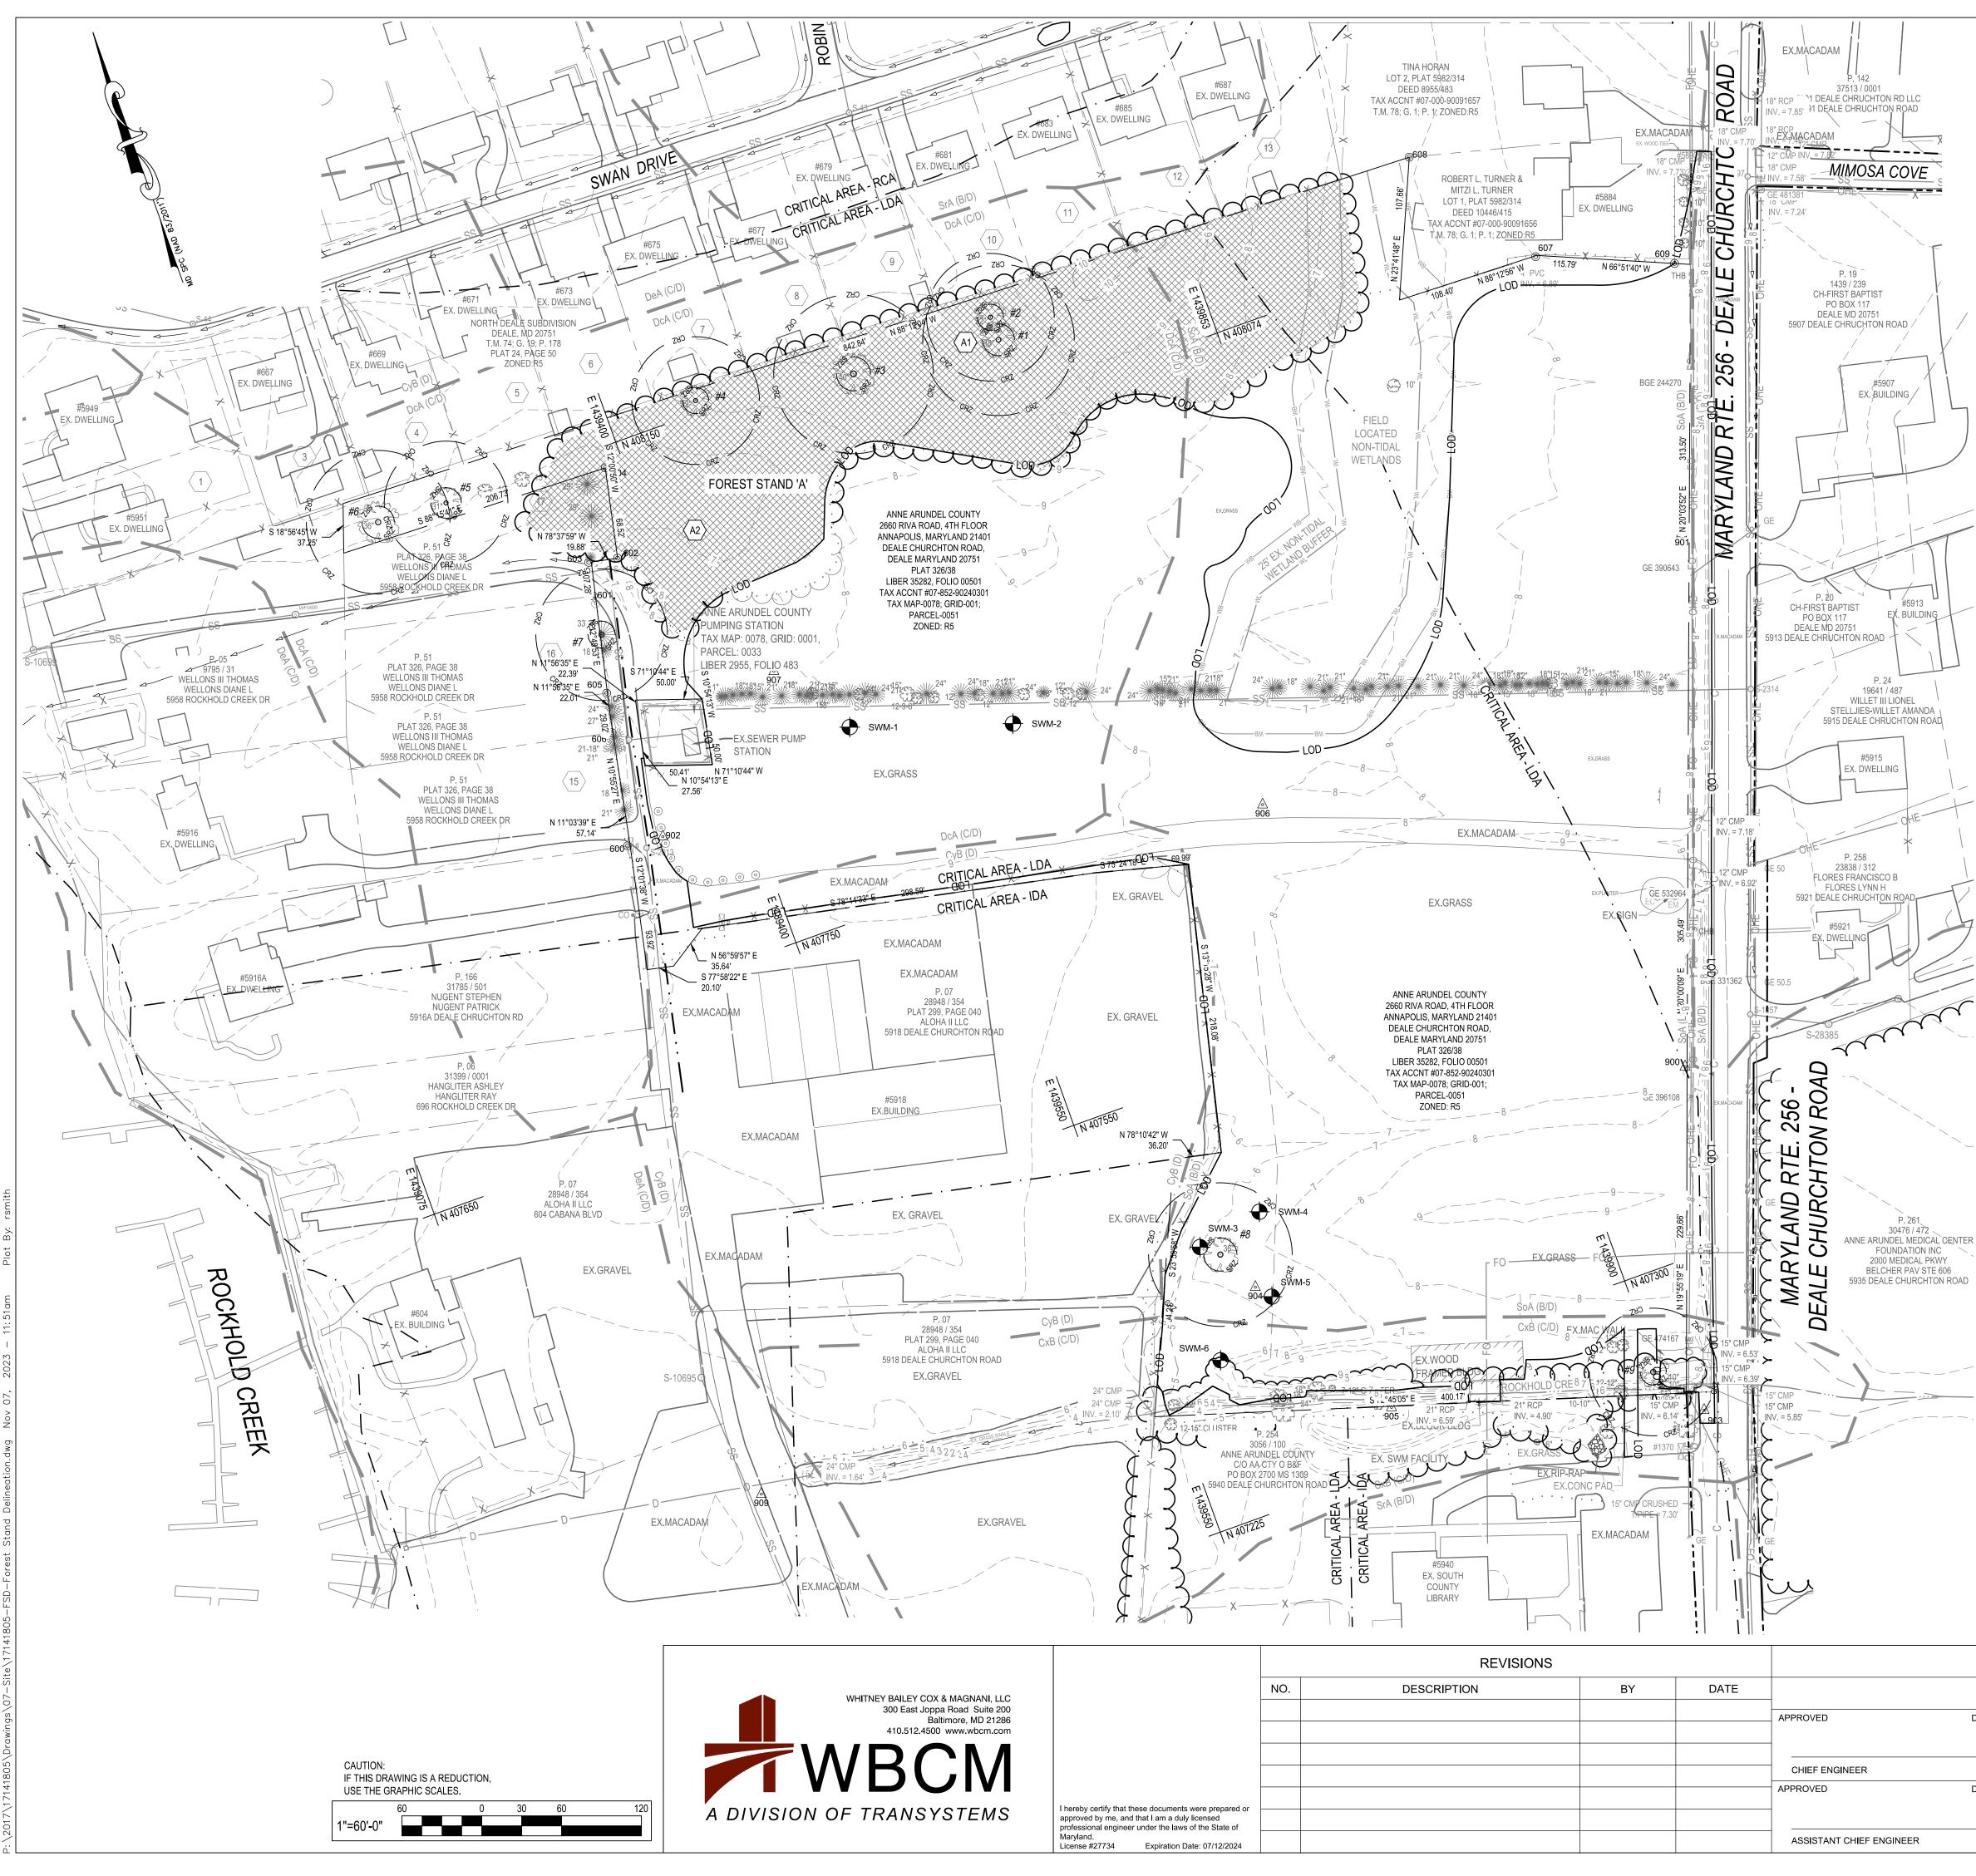
		REVISIONS			
	NO.	DESCRIPTION	BY	DATE	
					_ APPROVED
					 CHIEF ENGINEER
I hereby certify that these documents were prepared or					APPROVED
approved by me, and that I am a duly licensed professional engineer under the laws of the State of Maryland.					ASSISTANT CHIEF ENGIN
License #27734 Expiration Date: 07/12/2024					

ANNE ARUNDEL COUNTY

BID SET

DEPARTMENT OF PUBLIC WORKS

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		DRAWN BY: R.S.S.	
	PROJECT MANAGER	CHECKED BY: R.W.H.	
DATE	APPROVED DATE	SHEET NO. 33 OF 47	EROSION AND SEDIMENT CONTROL DETAILS
		PROJECT NO.: P582001	
NGINEER	CHIEF, RIGHT-OF-WAY	CONTRACT NO.: P582001	



LEGEND DESCRIPTION

BUILDING


BITUMINOUS CONCRETE PAVING

PORTLAND CEMENT CONCRETE

BITUMINOUS CONCRETE MILL & OVERLAY

BITUMINOUS CONCRETE PEDESTRIAN WALK

DECIDUOUS / EVERGREEN TREES	## 12" \$ 6" (3" 3"
CLEAN OUT	۲۳۳۸ کردیت کریے © c.o.
DRAIN INLET	
ELECTRIC MH	E
FIRE HYDRANT	
GAS VALVE	GV
HAND BOX	⊠н.в.
INLET MH	
UTILITY POLE	\mathcal{O}
SANITARY MH	S
SIGN (ONE-POST)	
STORM DRAIN MH	D
STREET LIGHT	\$
TRAVERSE STATION	<u></u> 900
BOLLARD	\odot
WATER VALVE	\bowtie
SPOT ELEVATION	+ 9.5
MAJOR CONTOUR	10
MINOR CONTOUR	9
WALL	
CONC. CURB	
SURVEY LIMITS	
CHAIN LINK FENCE LINE	XXX
SPLIT RAIL FENCE LINE	
O/H ELECTRIC	OHE
U/G FIBER OPTIC	FO
U/G GAS	G
U/G SANITARY	SS
U/G STORM	D
	W
	C
PROPERTY LINE	
RIGHT OF WAY SOIL BOR I NG	
	$\mathbf{\nabla}$
	SoA (B/D)
SOIL LINES	SrA (B/D)

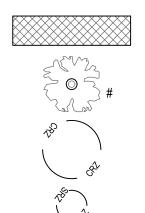

EXISTING

EX. BLDG

EX. MACADAM

EX. CONC.

EX. MACADAM

EXISTING FOREST ON PROJECT PROPERTY

SPECIMEN TREES

#5913

P. 261

ST #9

CRITICAL ROOT ZONE (CRZ)

STRUCTURAL ROOT ZONE (SRZ)

FSD FIELD SAMPLING PLOT LOCATION

	FSD FIELD SAMPLING PL	OT LOCATION	A			
ſ	Stand Variable		Stand #A1		Stand #2	
Ī	1. Dominant species / Codom	inant species	Red Oak, Elm & Cherry		Walr	nut, Maple & Ash
	2. Successional stage		Late			Late
Ī	3. Basal area in s.f. per acre		60			40
Ī	4. Size class of dominant spe	cies	> 30 IN DBH		6	- 12 IN DBH
Ī	5. Percent of canopy closure		95%		80%	
Ī	6. Number of tree species per	racre	5		4	
Ī	7. Common understory specie	es per acre	Cherry & Elm		Red I	Bud & Green Ash
Ī	8. Percent of understory cove	r 3' to 20' tall	27%			25%
Ī	9. Number of woody plant spe	ecies 3' to 20' tall	2			2
	10. Common herbaceous species 0' to 3' tall		Green Brier, Honey Suckle, Bramb Ivy	oles &	Honey	Suckle & Brambles
	11. Percent of herbaceous & woody plant cover 0' to 3' tall		83%			73%
	12. List of major invasive plant species & percent of cover		Honeysuckle, Ivy - 50%	Wisteria		& Honeysuckle- 30%
	13. Number of standing dead	trees 6" dbh or greater	3			1
	14. Comments		Lots of Brambles and downed tin debris, (3) specimen trees	nber		
		S	SPECIMAN TREE CHART			
	TREE NO.		SPECIES		DBH (in.)	CONDITION
	ST #1	Green Ash / F	Fraxinus pennsylvanica	32.00		Good
	ST #2	Red Oak	: / Quercus rubrum	38		Good
	ST #3	Red Oak	/ Quercus rubrum		40	Good
	ST #4	Red Oak	/ Quercus rubrum	31.5		Good
	ST #5	Red Oak	/ Quercus rubrum		31	Good
	ST #6		Inut / Juglans nigra		36	Good
	ST #7	Lobiolly	Pine / Pinus taeda		33	Good
	ST #8	Black Cherry / Prunus serotina			36"	Good

ANNE ARUNDEL COUNTY


Sweetgum / Liquidambar styraciflua

DEPARTMENT OF PUBLIC WORKS						
DATE	APPROVED DATE	SCALE: 1" = 60'	DEALE COMMUNITY PARK			
		DRAWN BY: R.S.S.				
	PROJECT MANAGER	CHECKED BY: R.W.H.				
DATE	APPROVED DATE	SHEET NO. 34 OF 47	FOREST STAND DELINEATION			
		PROJECT NO.: P582001				
INEER	CHIEF, RIGHT-OF-WAY	CONTRACT NO.: P582001				

32"

Good

BID SET

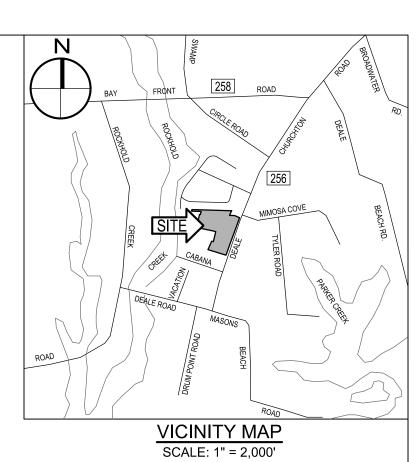

FOREST STAND DELINEATION NOTES:

1. PROPERTY ADDRESS: 5924 DEALE CHURCHTON ROAD, DEALE MARYLAND 20751

THE PROJECT AREA IS FOR THE DEVELOPMENT OF DEALE COMMUNITY PARK.

2. PROPERTY AREA IS COMPRISED OF THE FOLLOWING PARCEL: a. MAP 0078, GRID 0001, PARCEL 0051, DEED REFERENCE: LIBER 35282, FOLIO 00501 3. OWNER: ANNE ARUNDEL COUNTY

MAILING ADDRESS:

2660 RIVA ROAD, 4TH FLOOR

ANNAPOLIS, MARYLAND 21401 4. WETLANDS ARE PRESENT ON-SITE.

5. THE STATUS OF THE 100-YR FLOOD PLAIN: NO FLOOD PLAINS PRESENT ON-SITE. FEMA FLOOD MAP: FIRM PANEL 316 OF 385 SUFFIX

COMMUNITY NUMBER PANEL ANNE ARUNDEL COUNTY 240008 0316 F

6. INTERMITTENT AND PERENNIAL STREAMS ARE PRESENT ON-SITE.

7. ZONING: R5 - RESIDENTIAL 8. THE SITE IS WITHIN THE CHESAPEAKE BAY CRITICAL AREA.

FOREST STAND DELINEATION NARRATIVE

THE FSD INVESTIGATION PERFORMED BY WHITNEY, BAILEY, COX & MAGNANI, ON SEPTEMBER 21, 2022. THE SUBJECT PROPERTY IS A 12.03 ACRE PARCEL OF WHICH 1.81 ACRES IS FORESTED. THE FOREST HAS ONE (1) STAND. THE SURROUNDING AREA IS MARINA DISTRICT GENERAL COMMERCIAL AND LOW DENSITY RESIDENTIAL HOUSING. THERE IS A FORESTED CORRIDOR ON THE NORTH EDGE OF THE PROPERTY.

FOREST STAND A

FOREST STAND A IS 1.81 AC. THE TREE CANOPY IS TYPICAL OF A COASTAL PLAIN WALNUT -MAPLE LATE SUCCESSIONAL FOREST. THE STAND IS A BALANCED UN-EVEN AGED FOREST STRUCTURE WITH THE DOMINANT CANOPY CONSISTING OF THREE (3) SPECIES: OAK, MAPLE, AND WALNUT WITH A DOMINANT CLASS SIZE OF > 30 IN. DBH. OVERSTORY TREE SPECIES IN THE SHADYOAK-ELKTON COMPLEX SOILS ARE: BLACK WALNUT, SWEETGUM, RED MAPLE, LOBLOLLY PINE AND BLACK CHERRY.

THE STAND IS SITUATED IN A SHADYOAK-ELKTON COMPLEX SOILS RANGING IN 0-2 PERCENT SLOPES. THE DEALE-SHADYOAK COMPLEX SOILS ARE DESCRIBED AS FINE SANDY LOAM MINERAL SOIL, SILT LOAM, SILTY CLAY LOAM, SILTY EOLIAN MATERIAL UNDERLAIN BY LOAMY ALLUVIAL OR MARINE SEDIMENTS, POORLY DRAINED.

UNDERSTORY TREES INCLUDE: ELM, CHERRY, RED BUD AND GREEN ASH . WILDLIFE HABITAT VALUE ON THIS SITE IS EXCELLENT WITH COVER ALONG THE FOREST EDGE AND INTERIOR. THERE ARE SPECIMEN TREES (>30 DBH) SCATTERED IN THIS FOREST STAND.

OVERALL

THE STAND A IS IN FAIR CONDITION. AND HAS AN 85% CANOPY CLOSURE. THERE IS A 30% PRESENCE OF INVASIVE SPECIES THROUGHOUT THE STAND AND THERE ARE ENVIRONMENTAL RESOURCES PRESENT ON THE PROJECT SITE. THE FOREST STAND 'A' WOULD BE CLASSIFIED AS A PRIORITY ONE RANKING DUE TO THE BUFFERS FOR LAND USE AND CRITICAL HABITATS. THE SITE WAS HARVESTED 50 OR MORE YEARS AGO AS UNDERSTORY SHOWS SIGNS OF DISTURBANCE AND MANY SPECIMEN TREES.

DESCRIPTION	EXISTING	
BUILDING	EX. BLDG	
BITUMINOUS CONCRETE PAVING	EX. MACADAM	
PORTLAND CEMENT CONCRETE	EX. CONC.	
BITUMINOUS CONCRETE MILL & OVERLAY	EX. MACADAM	
BITUMINOUS CONCRETE PEDESTRIAN WA	ALK .	
DECIDUOUS / EVERGREEN TREES	#W_=12" \$ 6" (3"	and the second s
CLEAN OUT	O c.o.	lag
	Ē	
FIRE HYDRANT		
GAS VALVE	GV ⋈	
	⊠H.B.	#667
	\bigcirc	
UTILITY POLE	,C	
SANITARY MH		
SIGN (ONE-POST) STORM DRAIN MH	D	
STORM DRAIN MH STREET LIGHT	¢	
TRAVERSE STATION	↓	
BOLLARD	<u>></u>	
WATER VALVE	\bowtie	1 le x
SPOT ELEVATION	+ 9.5	#
MAJOR CONTOUR	10	S 18°56'45 W
MINOR CONTOUR	9	37.25'
CONC. CURB		
SURVEY LIMITS ·		
CHAIN LINK FENCE LINE	XXX	MiH10698
SPLIT RAIL FENCE LINE		
O/H ELECTRIC	OHE	
U/G FIBER OPTIC	FO	FOREST CONSERVATION NOTES:
U/G GAS	G	1. PROPERTY ADDRESS: 5924 DEALE CHURCHTON ROAD, DEALE MARYLAND 20751
U/G SANITARY	SS	2. PROPERTY AREA IS COMPRISED OF THE FOLLOWING PARCEL:
U/G STORM	D	a. MAP 0078, GRID 0001, PARCEL 0051, DEED REFERENCE: LIBER 35282, FOLIO 005
UG WATER .		3. OWNER: ANNE ARUNDEL COUNTY
	C	MAILING ADDRESS:
PROPERTY LINE		2660 RIVA ROAD, 4TH FLOOR ANNAPOLIS, MARYLAND 21401
SOIL BORING	swм#	4. EXISTING IMPERVIOUS AREA = 25,722 SQ.FT. / 0.59 ACRES. THE PROJECT IS LOCATED
	$\mathbf{\Psi}$	IS A PRIORITY FUNDING AREA (PFA). AS PER BILL 57-16 THE EXISTING IMPERVIOUS AR
SOIL LINES	SoA (B/D)	HAS BEEN SUBTRACTED FROM THE TOTAL TRACT AREA TO DETERMINE NET TRACT A
AFFORESTATION AREA	+ + + + + + + + + + + + + + + + + + +	5. PLANTING REQUIREMENTS PER THE FOREST CONSERVATION WORKSHEET ARE 636
NI UNEVIATIUN AREA		SF OR 0.0146 ACRES. 6. PLANTING REQUIREMENTS ARE PROPOSED TO BE MET THROUGH ON-SITE PLANTING
EXISTING FOREST ON		OF 0.0146 ACRES TO BE LOCATED ADJACENT EXISTING FOREST COVER NEAR THE
PROJECT PROPERTY		NORTHERN PROPERTY LINE. TOTAL TREES TO BE PLANTED BASED ON 350 TREES PER
	NrV3-	ACRE FOR 1 GALLON CONTAINER STOCK; 0.0146 X 350 = 5.1 TREE REQUIRED. 7. THIS PROJECT WILL REMOVE 0.00 ACRES OF EXISTING FOREST FROM WITHIN THE
SPECIMEN TREES		7. THIS PROJECT WILL REMOVE 0.00 ACRES OF EXISTING FOREST FROM WITHIN THE NET TRACT AREA.
	× , , ; #	8. DNR FOREST SERVICE MUST BE CONTACTED AT 410-836-4568 FOR A
		PRE-CONSTRUCTION MEETING AFTER THE FOREST PROTECTION DEVICES HAVE BEEN
	78	INSTALLED.
CRITICAL ROOT ZONE (CRZ)		
STRUCTURAL ROOT ZONE (SRZ)	The set	
	J	

Unique Tract 1

Priority Funding Area

USE THE GRAPHIC SCALES.

1"=60'-0"

0

30 60

120


Variables


Site Information

A. Growth Management Area

B. Land Use Type	Institutional
C. Unique Tract Area	524,224
D. Universal Deductions (Critical Area or 100-Yr Floodplain)	421,833
E. Impervious Surface Deductions for Targeted Growth and Priority Funding Areas	37,513
F. Existing Forest Cover within Unique Net Tract Area	8,889
G. Proposed Forest Clearing within Unique Net Tract Area	0
H. Unique Net ract Area = (C)-(D)-(E)	64,878
Is Total Net Tract Area less than or equal to 5 Acres?	Yes
Key for lookup table	Priority Funding AreaInstitutionalYes
I. Conservation Threshold	20%
J. Afforestation Threshold	15%
Forest Conservation	
K. Conservation Threshold Area = (H) X (I)	12,976
L. Area of Forest Above Conservation Threshold = (F) - (K)	0
<i>M. Breakeven Point (Amount of forest that must be retained so that no mitigation is required.)</i>	8,889
If the Area of Forest Above Conservation Threshold (L) is greater than 0, then $M = ((0.3333) \times (L)) + (K)$. If the Area of Forest Above Conservation Threshold is equal to 0, then $M = (F)$.	
N. Forest Clearing Permitted without Mitigation = (F) - (M)	0
O. Proposed Forest Retention = (F) - (G)	8,889
P. Reforestation for Retention Above the Threshold	0
If Proposed Forest Clearing (G) is > Area of Forest Above Conservation Threshold (L), then (P) = (L) X (0.5). If not, then (P) = (G) X (0.5).	
Q. Credit for Retention Above the Threshold	0
If Proposed Forest Clearing (G) is > Area of Forest Above Conservation Threshold (L), then (R) = 0. If not, then (R) = (L) - (G).	
R. Reforestation for Retention Below the Threshold	0
If Proposed Forest Clearing (G) < Area of Forest Above Conservation Threshold (L), then (R) = 0. If not, then (R) = ((G) - (L)) X 2	
S. Total Reforestation Required = (P) + (R) - (Q)	0
T. Afforestation Threshold Area = (H) X (J)	9,732
U. Total Afforestation Required	843
If Existing Forest Cover (F) < Afforestation Threshold Area (T), then (U) = (T) - (F). If not, then (U) = 0.	
	843

	SPECIMAN TREE
TREE NO.	SPECIES
ST #1	Green Ash / Fraxinus pennsylvanica
ST #2	Red Oak / Quercus rubrum
ST #3	Red Oak / Quercus rubrum
ST #4	Red Oak / Quercus rubrum
ST #5	Red Oak / Quercus rubrum
ST #6	Black Walnut / Juglans nigra
ST #7	Loblolly Pine / Pinus taeda
ST #8	Black Cherry / Prunus serotina
ST #9	Sweetgum / Liquidambar styraciflua

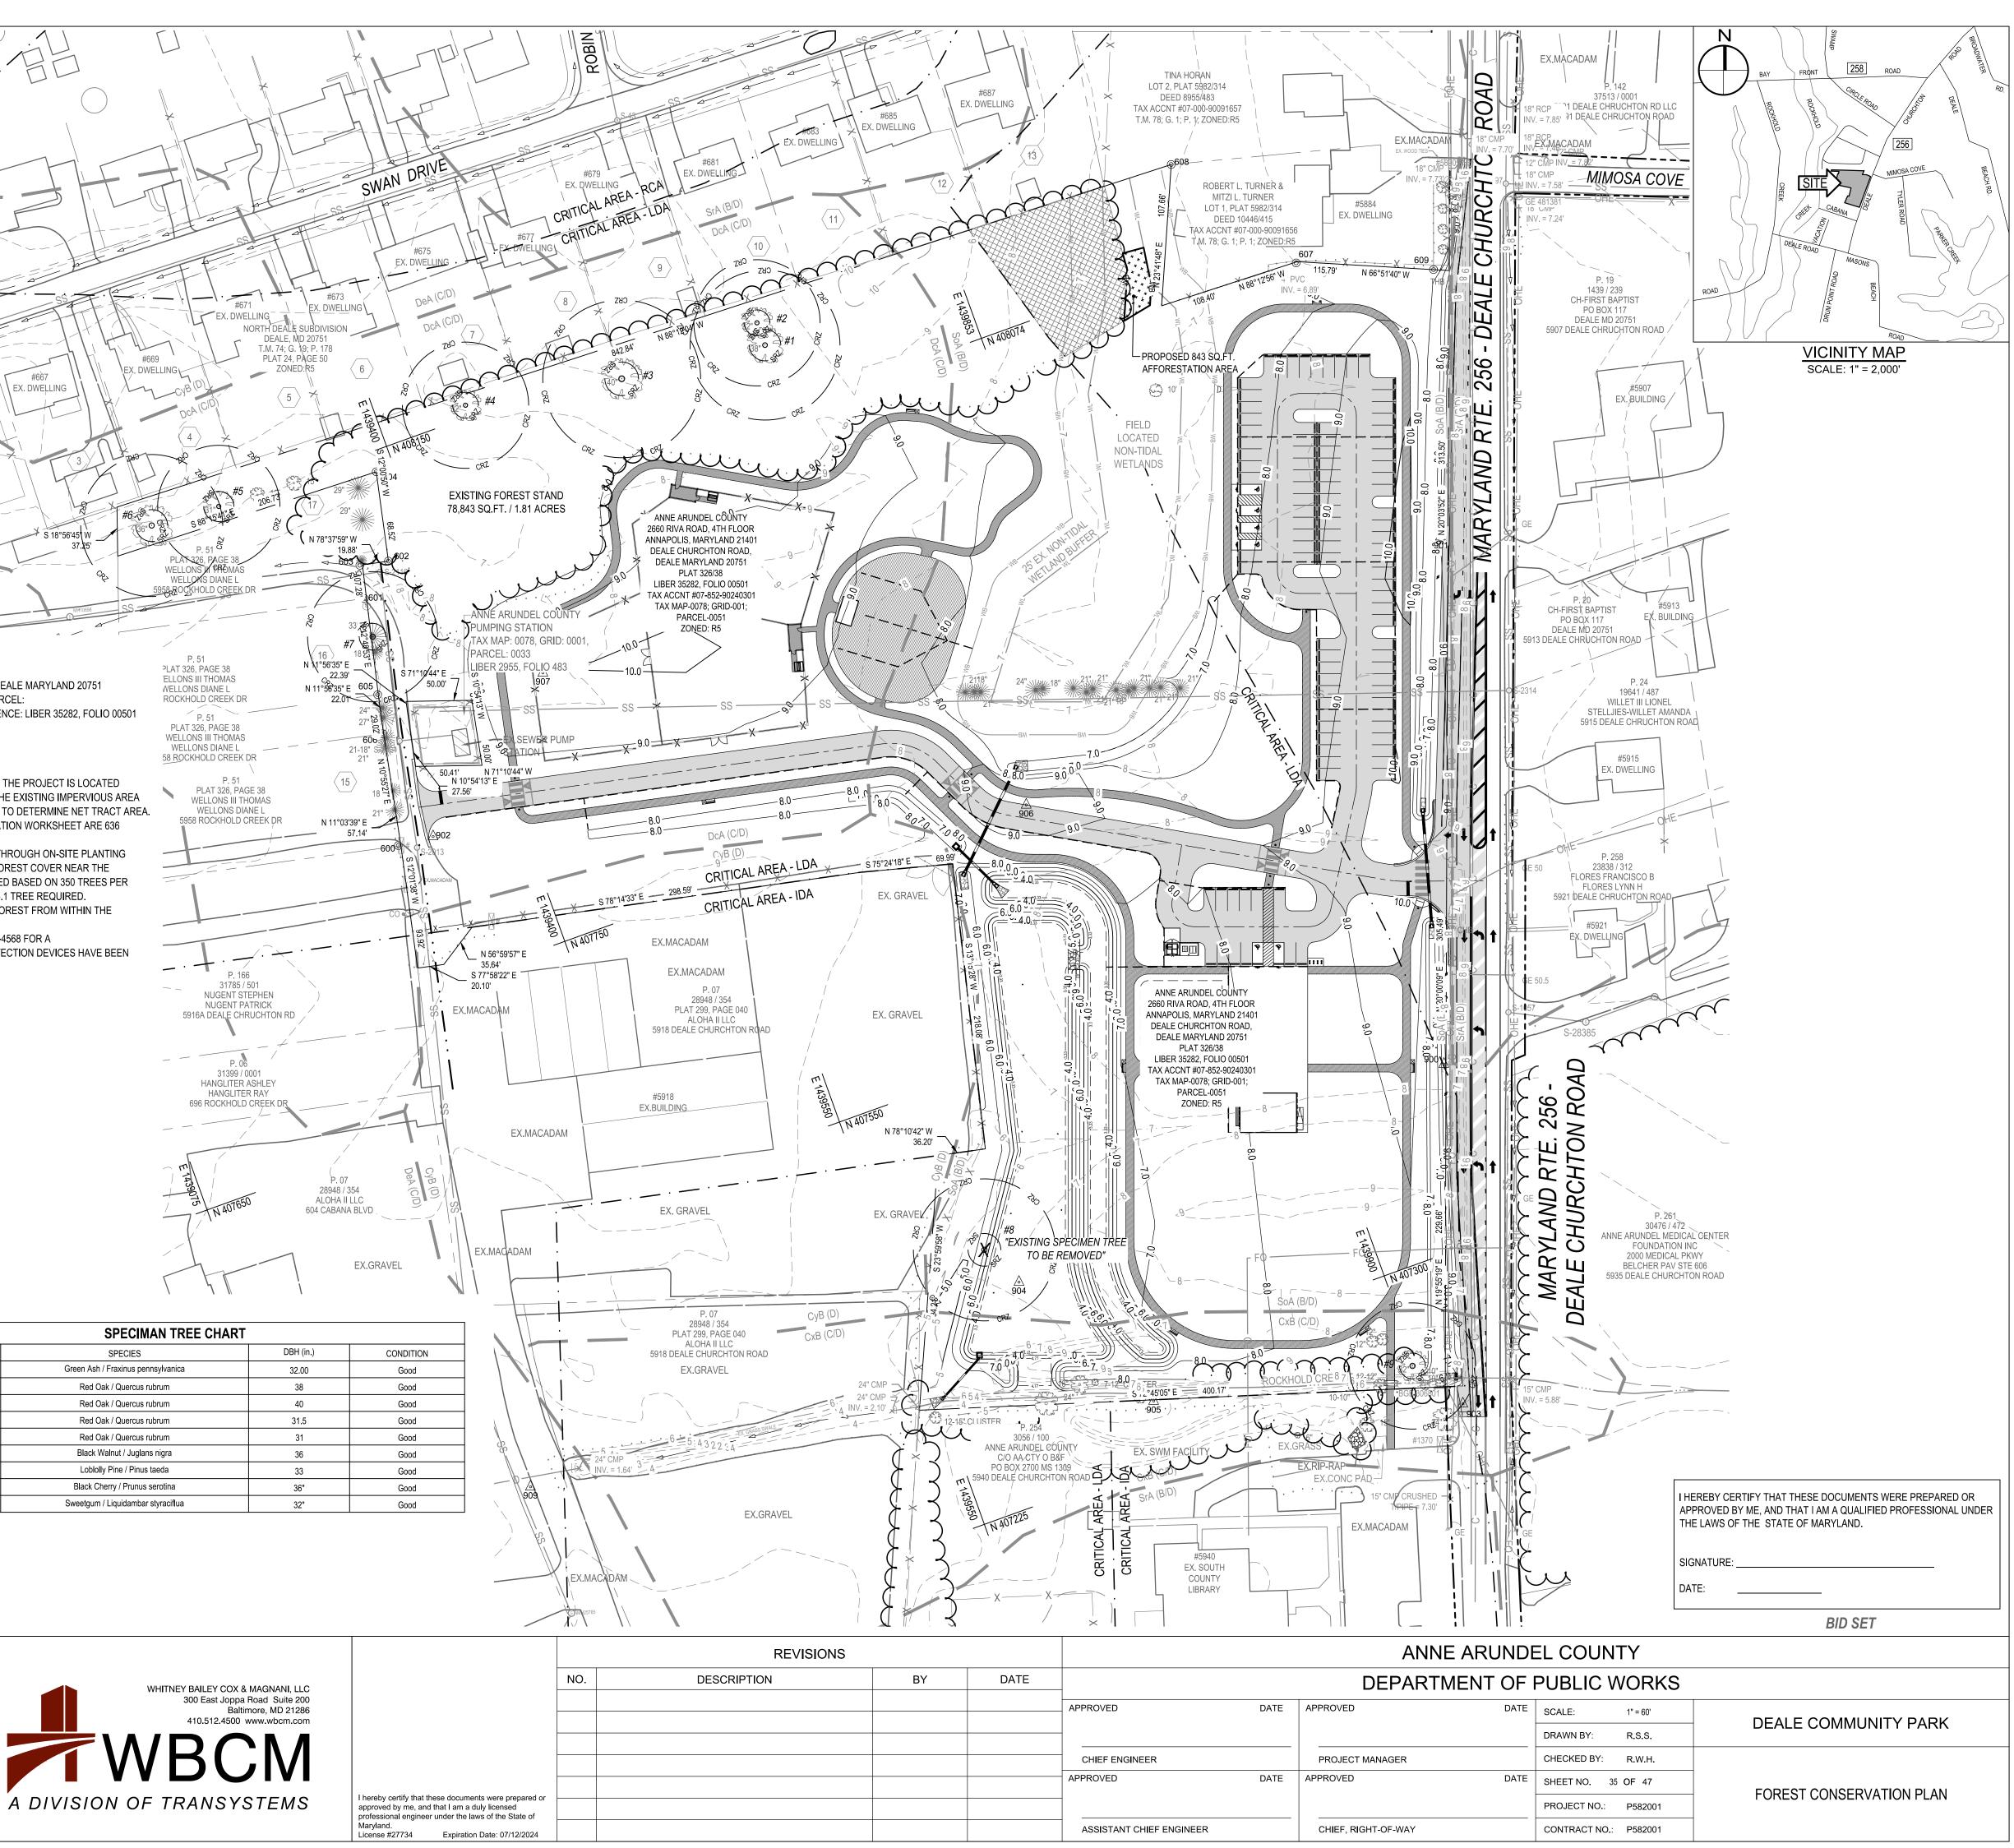

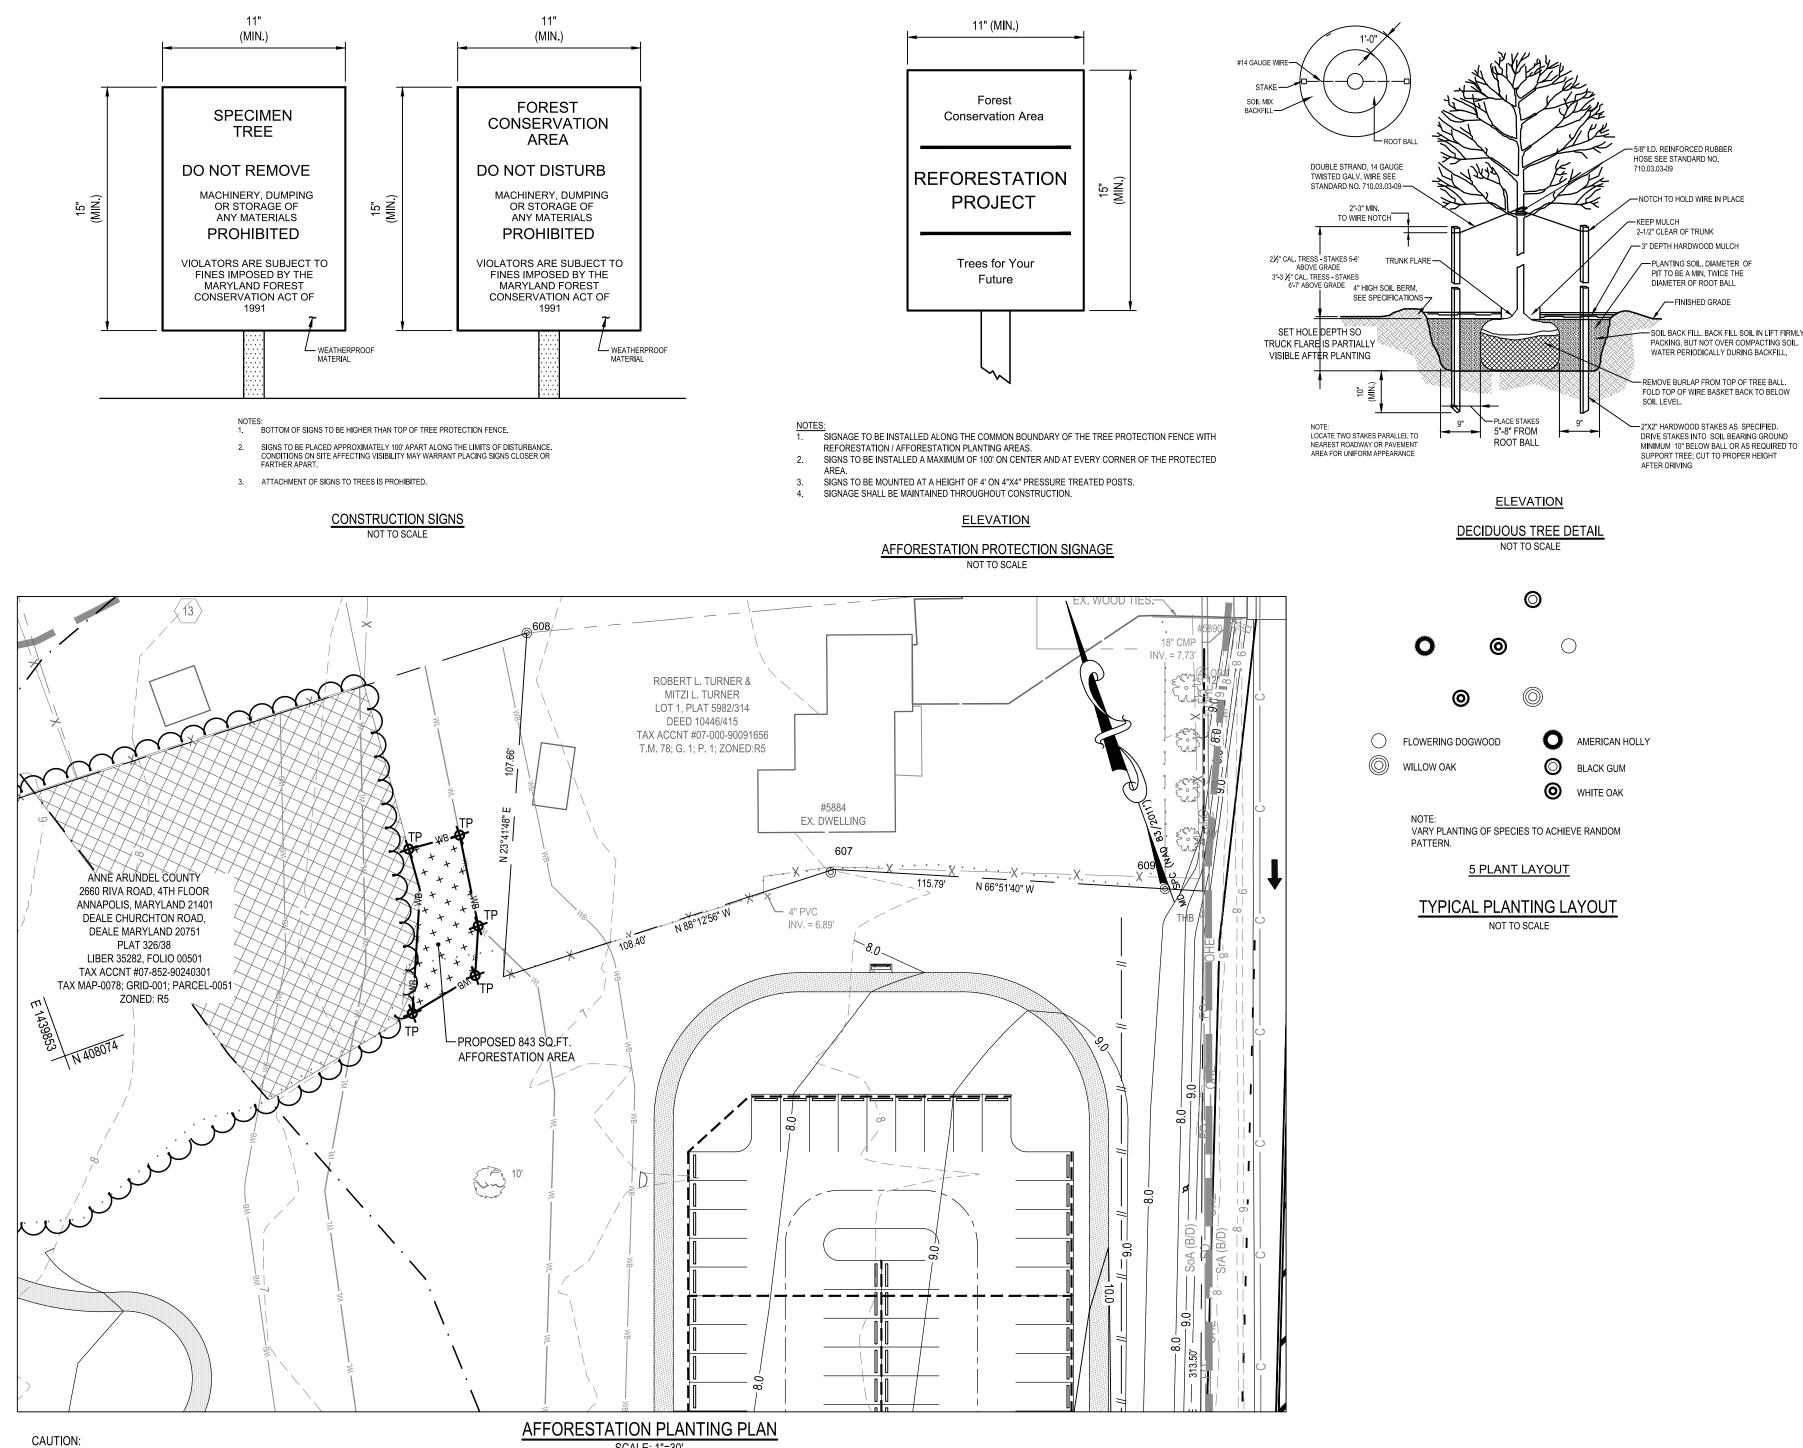

IF THIS DRAWING IS A REDUCTION,





SCALE: 1"=30'

Afforestation Plant Schedule							
	QTY	BOTANICAL NAME	COMMON NAME	SIZE(MIN.)	ROOT	REMARKS	
	1	Cornus florida	Flowering Dogwood	3'-4' Hgt., 1 gal.	Cont.	12' O.C Spacing	
	1	llex opaca	American Holly	3'-4' Hgt., 1 gal.	Cont.	12' O.C Spacing	
	1	Nyssa sylvatica	Black Gum	3'-4' Hgt., 1 gal.	Cont.	12' O.C Spacing	
	2	Quercus alba	White Oak	3'-4' Hgt., 1 gal.	Cont.	12' O.C Spacing	
1 Quercus phello		Quercus phellos	Willow Oak	3'-4' Hgt., 1 gal.	Cont.	12' O.C Spacing	
	6 TOTAL						
* CONTAINER GROWN - 1,2.& 3 Gallon sizes							
*ALL NU	*ALL NURSERY STOCK SHOULD CONFORM TO THE AMERICAN STANDARD FOR NURSERY STOCK (ANSI-#Z60.1-2004).						

ALL PLANT MATERIALS SHALL BE NURSERY GROWN AND SHALL CONFORM TO AMERICAN NURSERY & LANDSCAPE ASSOCIATION (ANLA) STANDARDS. ALL PLANTS SHALL BE IDENTIFIED IN ACCORDANCE WITH THE LATEST EDITION OF HORTUS THIRD. BY L.H. BAILEY

ALL PLANTS SHALL BE GUARANTEED BY THE CONTRACTOR FOR ONE YEAR FOLLOWING THE INSTALLATION COMPLETION.

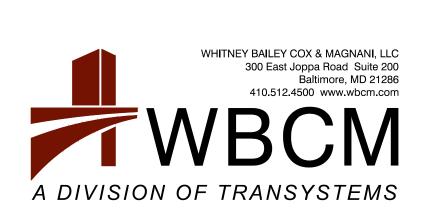

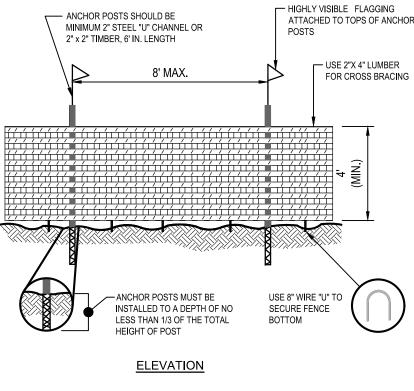

- BLAZE ORANGE OR BLUE PLASTIC MESH FENCE FOR FOREST PROTECTION DEVICE ONLY. BOUNDARIES OF RETENTION AREA WILL BE ESTABLISHED AS PART OF THE FOREST CONSERVATION PLAN
- **REVIEW PROCESS** BOUNDARIES OF RETENTION AREA SHALL BE STAKED AND FLAGGED PRIOR TO INSTALLING DEVICE. AVOID DAMAGE TO CRITICAL ROOT ZONE. DO NOT DAMAGE OR SEVER LARGE ROOTS WHEN INSTALLING
- POSTS. PROTECTION SIGNS ARE REQUIRED 6. DEVICE SHOULD BE MAINTAINED THROUGHOUT CONSTRUCTION.
 - PLASTIC MESH TREE PROTECTION FENCE NOT TO SCALE

AFFORESTATION OR REFORESTATION MAINTENANCE AND **REPLACEMENT REQUIREMENTS**

A TWO YEAR MAINTENANCE AND REPLACEMENT WARRANTY PERIOD IS REQUIRED FOR ALL NEWLY PLANTED MATERIALS. THE MAINTENANCE AND REPLACEMENT WARRANTY E PRO PERIOD SHALL COMMENCE UPON THE DATE OF THE WRITTEN ACCEPTANCE BY THE OWNER OF THE PLANTED AREAS. A WRITTEN WARRANTY WILL BE DELIVERED TO THE OWNER UPON ACCEPTANCE OF THE PLANTED AREAS. THE CONTRACTOR RESPONSIBLE FOR THE INITIAL PLANTING OPERATIONS AND RELATED WORK SHALL PROVIDE MAINTENANCE AND REPLACEMENT. ALL LANDSCAPE PLANT MATERIAL INCLUDED AS FOREST CONSERVATION CREDITS SHALL BE COVERED UNDER THE MAINTENANCE AND REPLACEMENT WARRANTY PERIOD.

MAINTENANC

THE CONTRACTOR SHALL FIELD CHECK THE NEWLY PLANTED AREA(S) AND SHALL PROVIDE THE FOLLOWING MAINTENANCE ITEMS IN ACCORDANCE WITH THE FOLLOWING SCHEDULE WHICH SHALL BEGIN AFTER THE COMPLETION AND ACCEPTANCE OF THE INITIAL AFFORESTATION OR REFORESTATION PLANTING.

- 1. WATERING: WATERING OF ALL NEWLY PLANTED MATERIALS ONCE PER WEEK AS WEATHER PERMITS DURING THE ENTIRE INITIAL GROWING SEASON. FOLLOWING THE INITIAL GROWING SEASON, WATERING SHALL BE DONE ON AN "AS NEEDED" BASIS DEPENDING ON THE FREQUENCY OF NATURAL RAINFALL. DURING THE MONTHS OF JULY AND AUGUST AND PERIODS OF SEVERE DROUGHT, ALL NEWLY PLANTED MATERIALS SHALL BE WATERED THOROUGHLY ONCE EVERY WEEK. WATERING SHALL BE DONE DEEPLY AND SLOWLY USING AN OPEN END HOSE OR WATERING PROBE, AT LOW PRESSURE ALLOWING THE WATER TO BE ABSORBED INTO THE SOIL UNTIL THOROUGHLY SATURATED. THE WATERED AREA SHALL INCLUDE THE WHOLE ROOT ZONE AS THE TREE BECOMES MORE ESTABLISHED.
- 2. FERTILIZING: FERTILIZING SHALL BE APPLIED ONLY AFTER THE SOIL HAS BEEN TESTED TO DETERMINE ITS NEEDS. ORGANIC FERTILIZER SHOULD BE APPLIED IN ACCORDANCE WITH THE AMOUNTS RECOMMENDED IN THE SOIL ANALYSIS REPORT. NO FERTILIZING OF NEW PLANTED TREES SHALL BE DONE WITHIN THE FIRST GROWING SEASON AFTER INITIAL PLANTING. FOLLOWING THE FIRST GROWING SEASON, APPLY FERTILIZER AS RECOMMENDED EITHER IN LATE FALL OR EARLY SPRING.
- 3. SUPPLEMENTAL MULCH: TO CONTROL UNDESIRABLE VEGETATION ADJACENT TO THE NEWLY PLANTED MATERIALS AND TO PREVENT TREE ROOTS FROM DRYING OUT, ADDITIONAL MULCH SHALL BE PLACED OVER THE EXISTING MULCH FIELD WHERE REQUIRED. CAREFULLY REMOVE ANY INVASIVE PLANTS, INCLUDING THE ROOT SYSTEM WITHIN THE MULCH FIELDS. DO NOT DAMAGE TREES IN ANY WAY DURING REMOVAL OF INVASIVE PLANTS OR MULCHING OPERATIONS.
- 4. PRUNING: REMOVE DEAD, DISEASED, DYING, AND BROKEN BRANCHES FROM ALL PLANT MATERIALS. PRUNING SHALL BE DONE CLEANLY, LEAVING NO RAGGED EDGES.

REPLACEMENT OF DEAD OR DYING MATERIALS

- 1. SURVIVAL REQUIREMENT: AREAS AT THE END OF THE SECOND GROWING SEASON SHALL MEET THE FOLLOWING MINIMUM PERCENTAGES OF TOTAL PLANTS SPECIFIED BY THE APPROVED PLAN.
- A. BARE ROOT SEEDLINGS OR WHIPS- 55% B. CONTAINER-GROWN SEEDLING TUBES OR WHIPS WITH TREE SHELTERS- 65%
- C. CONTAINER-GROWN 1-,2-, AND 3- GALLON- 75% D. CONTAINER-GROWN 5- AND 7- GALLON OF 1" CAL) B&B- 85%
- E. 2" CAL. B&B- 100%.
- 2. INSPECTION: CONTRACTOR SHALL SCHEDULE AN INSPECTION OF THE AFFORESTATION OR REFORESTATION AREA(S) BY A QUALIFIED REPRESENTATIVE OF THE DPZ AND BY THE QUALIFIED PROFESSIONAL WHO PREPARED THE PLAN, AT THE BEGINNING AND AT THE END OF THE GROWING SEASON TO OBSERVE ANY PROBLEMS, MONITOR SURVIVAL RATE AND SPECIFY NECESSARY REMEDIAL ACTIONS NEEDED TO CORRECT EXISTING PROBLEMS. THE INSPECTION SHOULD FOCUS ON THE
- FOLLOWING ITEMS WHEN DETERMINING SURVIVAL POTENTIAL: A. VIGOR AND THREAT OF COMPETING VEGETATION **B. PLANT STRUCTURE**
- C. GROWTH RATE D. CROWN DEVELOPMENT
- E. TRUNK CONDITIONS AND HEALTH.
- 3. PLANT CONDITION-CHECK SHEETS: THE CONTRACTOR SHALL MAINTAIN ACCURATE RECORDS ON APPROPRIATE FIELD DATA CHECK SHEETS WHICH SHALL INCLUDE ALL CONDITIONS OBSERVED RELATIVE TO THE HEALTH AND POTENTIAL SURVIVAL OF THE PLANT MATERIALS. SUCH CHECK SHEETS SHALL BE COMPLETED DURING EACH SCHEDULED MAINTENANCE SESSION DURING THE 24-MONTH MANAGEMENT AND MAINTENANCE PROGRAM. ONE COPY OF THE CHECK SHEETS SHALL BE SENT TO THE CLIENT, ONE COPY TO WBCM, AND ONE COPY SHALL BE SENT TO THE ANNE ARUNDEL COUNTY DEPARTMENT OF PLANNING AND ZONING.
- 4. REPLACEMENT: ANY PLANT MATERIALS WHICH ARE 25% DEAD OR MORE SHALL BE REPLACED DURING THE APPROPRIATE SPRING OR FALL PLANTING SEASONS IN ACCORDANCE WITH THE METHODS INDICATED IN THE PLANTING DETAILS. A TREE SHALL BE CONSIDERED DEAD WHEN THE MAIN LEADER HAS DIED BACK. ALL REPLACEMENTS SHALL BE PLANTS OF THE SAME GENUS, SPECIES, AND SIZE AS SPECIFIED ON THE PLANT LIST.
- 5. INSPECTION/CERTIFICATION SCHEDULE: THE CONTRACTOR SHALL SUBMIT WITH HIS BID A SCHEDULE FOR THE WORK WHICH SHALL INCLUDE INSPECTIONS BY WBCM AT THE CONCLUSION OF INSTALLATION AND AT THE START AND CONCLUSION OF EACH GROWING SEASON DURING THE TWO-YEAR WARRANTY PFRIOD
- 6. PENALTY FOR VIOLATION: A SITE INSPECTION BY THE CONTRACTOR, AND A REPRESENTATIVE OF WBCM SHALL TAKE PLACE AT THE END OF THE 24-MONTH MANAGEMENT AND MAINTENANCE AGREEMENT PERIOD. THE CONTRACTOR SHALL CONTACT WBCM AT LEAST ONE (1) MONTH IN ADVANCE OF SUCH INSPECTION FOR COORDINATION. IF THE SURVIVAL RATE OF THE AFFORESTATION OR REFORESTATION AREA(S) FALLS BELOW THE ESTABLISHED SURVIVAL REQUIREMENTS BY THE END OF THE 24-MONTH MANAGEMENT AND MAINTENANCE AGREEMENT, THE REMAINING AMOUNT OF THE CASH BOND OR OTHER SURETY MAY BE SUBJECT TO FORFEITURE, OR OTHER PENALTIES MAY BE **IMPOSED**

		REVISIONS			
	NO.	DESCRIPTION	BY	DATE	
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ared or e of					_
2024					ASSISTANT CHIEF ENG

hereby certify that these documents were prep approved by me, and that I am a duly licensed professional engineer under the laws of the State Maryland. icense #27734 Expiration Date: 07/12/2







SEQUENCE OF OPERATIONS

PRE-CONSTRUCTION SITE PREPARATION

ALL CONSTRUCTION ACTIVITIES, PRACTICES, TECHNIQUES, ETC., SHALL BE IN CONFORMANCE WITH THE MARYLAND FOREST CONSERVATION PROGRAM, AS SPECIFIED IN THE STATE FOREST CONSERVATION TECHNICAL MANUAL. (THIS MANUAL SUPERCEDES ANY DISCREPANCIES BETWEEN IT AND THESE PLANS).

- INSTALL TREE PROTECTION FENCE AND IMPLEMENT TREE PROTECTION METHODS AS SHOWN. 2. MOW OR BRUSHHOG THE SITE WITHIN THE LIMITS OF THE PROPOSED REFORESTATION/AFFORESTATION AREA. DO NOT REMOVE OR DAMAGE ANY EXISTING TREES OR
- SAPLINGS UNLESS OTHERWISE INDICATED. 3. REMOVE OR TREAT WITH AN ACCEPTABLE METHOD. NOXIOUS PLANT MATERIAL SUCH AS MULTIFLORA ROSE, TEARTHUMB, AND JOHNSON GRASS BEFORE INSTALLING REFORESTATION/AFFORESTATION
- PLANTS. 4. INSTALL TREE PROTECTION SIGNAGE.
- 5. STABILIZE ANY DISTURBED AREAS USING THE SPECIFIED STABILIZATION MIXTURE THAT ALLOWS FOR NATURAL REVEGETATION OF FOREST COMMUNITIES.

FOREST RETENTION SEQUENCE OF OPERATIONS

ALL CONSTRUCTION ACTIVITIES, PRACTICES, TECHNIQUES, ETC., SHALL BE IN CONFORMANCE WITH THE MARYLAND FOREST CONSERVATION PROGRAM, AS SPECIFIED IN THE STATE FOREST CONSERVATION TECHNICAL MANUAL. (THIS MANUAL SUPERCEDES ANY DISCREPANCIES BETWEEN IT AND THESE PLANS).

- 1. PRIOR TO BEGINNING ANY GRADING OPERATIONS ON THIS SITE OR ON A RESPECTIVE LOT, THERE SHALL BE A PRECONSTRUCTION MEETING HELD AT THE SITE, WHICH IS TO INCLUDE THE CONTRACTOR AND REPRESENTATIVES FROM WHITNEY, BAILEY, COX & MAGNANI, LLC (WBCM). THE ANNE ARUNDEL COUNTY DEPARTMENT OF PLANNING AND ZONING (DPZ) AND THE OWNER WILL BE NOTIFIED BY THE CONTRACTOR AS TO THE TIME AND PLACE OF THE FIELD MEETING, SHOULD THEY WISH TO SEND A REPRESENTATIVE. THE PURPOSE OF THIS MEETING WILL BE TO REVIEW THE APPROVED FCP AND TO FIELD VERIFY THE CORRECT LIMITS OF DISTURBANCE (LOD).
- 2. THE LIMITS OF DISTURBANCE (LOD) PERTINENT TO THE PRESERVATION OF WOODED AREAS SHALL BE STAKED IN THE FIELD WITH FINAL ADJUSTMENTS BEING MADE AS NECESSARY TO ENSURE ADEQUATE PROTECTION OF THE CRITICAL ROOT ZONE OF TREES DESIGNATED FOR RETENTION. STAKES TO BE USED SHALL BE THOSE SPECIFIED FOR THE "TREE PROTECTION DEVICES" TO WHICH APPROVED PROTECTIVE MATERIAL WILL BE ATTACHED. ALTERNATE MEANS OF DEFINING THE LOD MAY BE USED IF APPROVED BY THE DPZ.
- 3. ALL FOREST RETENTION AREAS SHALL BE PROTECTED BY HIGHLY VISIBLE, WELL-ANCHORED, TEMPORARY PROTECTION DEVICES (SEE DETAIL), WHICH SHALL BE SECURELY IN PLACE PRIOR TO ANY CLEARING OR GRADING OPERATIONS.
- 4. GRADING OPERATIONS OR OTHER CONSTRUCTION OPERATIONS THAT COULD DISLODGE OR OTHERWISE DAMAGE THE PROTECTIVE DEVICES SHALL BE AVOIDED ALONG THE EDGES OF THE LOD LINES IF POSSIBLE. THE CONTRACTOR SHALL PROPERLY REPAIR ANY PROTECTIVE DEVICES, WHICH ARE DAMAGED DURING SITE CONSTRUCTION OPERATIONS, IMMEDIATELY.
- 5. AFTER SITE GRADING AND CONSTRUCTION HAVE BEEN COMPLETED, ALL EXISTING TREES ADJACENT TO THE LOD LINE SHALL BE INSPECTED FOR INDICATIONS OF CROWN DIE-BACK (SUMMER INDICATOR), DAMAGE WITHIN RESPECTIVE CRITICAL ROOT ZONES, ANY DEAD WOOD OR OTHER CONDITIONS WHICH MIGHT BE HAZARDOUS SUCH AS TO PEDESTRIANS, BUILDINGS, UTILITY LINES, VEHICULAR ACCESS WAYS, OR PARKED VEHICLES.
 - A. SHOULD THERE BE EVIDENCE OF ANY DAMAGE TO TREE TRUNKS, BRANCHES, OR OTHER CRITICAL ROOT ZONE OF TREES WITHIN THE PROTECTED AREAS, OR TO ISOLATED SPECIMEN TREES TO BE PRESERVED, THE DAMAGE SHALL BE EXAMINED WITHIN A PERIOD OF TWO (2) DAYS FROM THE DATE OF OBSERVANCE BY A LICENSED TREE CARE PROFESSIONAL. EXPOSED ROOTS SHOULD BE COVERED IMMEDIATELY TO A DEPTH OF 6-8 INCHES WITH SOIL, PREFERABLY MIXED WITH 50% PEAT MOSS OR LEAF MOLD.
 - B. THE CONTRACTOR SHALL REMOVE DAMAGED, DEAD, OR DYING TREES OR LIMBS ONLY IF THE TREES OR LIMBS POSE AN IMMEDIATE SAFETY HAZARD TO BUILDINGS, UTILITY LINES, VEHICLES, OR ACCESS AND EGRESS DRIVES OR PEDESTRIAN AREAS. TREES DESIGNATED FOR PRUNING OR REMOVAL SHALL BE PRUNED OR REMOVED USING EQUIPMENT AND METHODS WHICH WILL NOT DAMAGE OR DESTROY ADJACENT LARGE TREES OR UNDERSTORY TREES OR SHRUBS DESIGNATED FOR RETENTION.
- 6. ALL TEMPORARY FOREST PROTECTION DEVICES WILL BE CAREFULLY REMOVED AFTER ALL GENERAL CONSTRUCTION, NECESSARY TREE SURGERY, REMOVAL OF DEBRIS, REGRADING AND RESEEDING OF SEDIMENT AND EROSION CONTROL DISTURBANCE HAVE BEEN COMPLETED AND ACCEPTANCE AND APPROVAL OF THE WORK AND SITE CONDITIONS HAVE BEEN GIVEN BY THE DPZ.

AFFORESTATION/REFORESTATION PLANTING SEQUENCE OF OPERATIONS

ALL CONSTRUCTION ACTIVITIES, PRACTICES, TECHNIQUES, ETC., SHALL BE IN CONFORMANCE WITH THE MARYLAND FOREST CONSERVATION PROGRAM, AS SPECIFIED IN THE STATE FOREST CONSERVATION TECHNICAL MANUAL. (THIS MANUAL SUPERCEDES ANY DISCREPANCIES BETWEEN IT AND THESE PLANS.)

- 1. THE CONTRACTOR(S) SHALL INFORM THE ANNE ARUNDEL COUNTY DEPARTMENT OF PLANNING AND ZONING (DPZ) WHEN PLANTING OPERATIONS ARE TO BEGIN.
- 2. DETERMINE STORAGE AREAS FOR MATERIALS AND EQUIPMENT. OBTAIN APPROVAL OF LOCATION FROM OWNER AND THE DPZ.
- 3. PRIOR TO BEGINNING ANY PLANTING, THE SOILS WITHIN THE AREA(S) DESIGNATED FOR AFFORESTATION OR REFORESTATION SHALL BE ANALYZED REGARDING THE FOLLOWING FEATURES: NUTRIENT CONTENT, ORGANIC MATTER, STRUCTURE, PH AND CAUTION EXCHANGE CAPACITY. SOILS THAT HAVE BEEN ACTIVELY FORMED MAY REQUIRE EVALUATION FOR PESTICIDE OR HERBICIDE CONTAMINATION. THE LOCAL SOIL CONSERVATION SERVICE OR AGRICULTURAL EXTENSION SERVICE MAY PERFORM SUCH ANALYSIS. A MINIMUM OF THREE RANDOM SAMPLES SHOULD BE COLLECTED FOR THE ANALYSIS. AN ASSESSMENT OF SOIL MOISTURE SHOULD ALSO BE MADE AT THIS TIME. CORRECTIVE MEASURES SHALL BE MADE IN ACCORDANCE WITH ANALYSIS RESULTS AND RECOMMENDATIONS.
- 4. THE CONTRACTOR, ASSISTED BY A REPRESENTATIVE OF WHITNEY, BAILEY, COX & MAGNANI, LLC (WBCM) SHALL STAKE (OR WIRE-FLAG) PLANTING AREA LIMITS AND PLANT LOCATIONS IN ACCORDANCE WITH THE PLAN AND DETAILS.
- 5. PROVIDE AND PLANT ALL TREES OF THE SPECIES AND SIZES SPECIFIED AND IN ACCORDANCE WITH THE DETAIL(S) SHOWN ON THE FOREST CONSERVATION PLANS, UNLESS OTHERWISE DIRECTED BY THE ANNE ARUNDEL COUNTY DPZ. ANY SPECIES SUBSTITUTIONS SHALL BE APPROVED BY WBCM OR THE ANNE ARUNDEL COUNTY DPZ. THE CONTRACTOR IS URGED TO SEEK SUCH APPROVAL PRIOR TO ORDERING OR PLANTING.
- 6. AT THE COMPLETION OF PLANTING, REMOVE ALL EXCESS MATERIALS AND MISCELLANEOUS DEBRIS FROM THE RESPECTIVE AREA(S) OF WORK.
- 7. PROTECTION DEVICES: TO PREVENT DAMAGE WITHIN PLANTED AREAS, ALL REFORESTATION AND/OR AFFORESTATION SITES MUST BE POSTED WITH APPROPRIATE SIGNS AND THE AREA(S) DELINEATED WITH APPROPRIATE PROTECTIVE FENCING. NEITHER CONSTRUCTION EQUIPMENT NOR STORAGE OF MATERIALS SHALL BE PERMITTED WITHIN THE PLANTED AREAS. DETAILS ARE SHOWN ON THE FOREST CONSERVATION PLANS REGARDING TYPICAL SIGN SIZE AND WORDING. NO PEDESTRIAN TRAFFIC SHALL BE ALLOWED WITHIN THE PROTECTED AREAS.
- 8. ATTACHMENT OF SIGNS OR ANY OTHER OBJECTS TO TREES WITHIN THE PROTECTED AREAS IS PROHIBITED.

I HEREBY CERTIFY THAT THESE DOCUMENTS WERE PREPARED OR APPROVED BY ME, AND THAT I AM A QUALIFIED PROFESSIONAL UNDER THE LAWS OF THE STATE OF MARYLAND.

SIGNATURI DATE

BID SET


DEPARTMENT OF PUBLIC WORKS					
DATE	APPROVED DATE	SCALE: 1" = 60'	DEALE COMMUNITY PARK		
		DRAWN BY: R.S.S.			
	PROJECT MANAGER	CHECKED BY: R.W.H.			
DATE	APPROVED DATE	SHEET NO. 36 OF 47	FOREST CONSERVATION PLAN		
		PROJECT NO.: P582001	NOTES AND DETAILS		
GINEER	CHIEF, RIGHT-OF-WAY	CONTRACT NO.: P582001			


MD 104.02-01 AND MD 104.02-09 AS NECESSARY TO COMPLETE THE WORK.

- PROTECTION UTILIZING MDOT SHA STANDARDS MD 104.02-01 AND MD
- WHILE MAINTAINING ACCESS TO HIDDEN HARBOR MARINA AND THE RESIDENCES AT 5916 AND 5916A DEALE CHURCHTON ROAD AND 5958 ROCKHOLD DRIVE (DRIVEWAY CONNECTION IS TO DEALE CHURCHTON ROAD).

- MAINTAINING ACCESS TO HIDDEN HARBOR MARINA AND THE
- NECESSARY FOR CONSTRUCTION OF THE SITE.

- AS DETAILED IN THE SIGNING AND PAVEMENT MARKING PLANS.

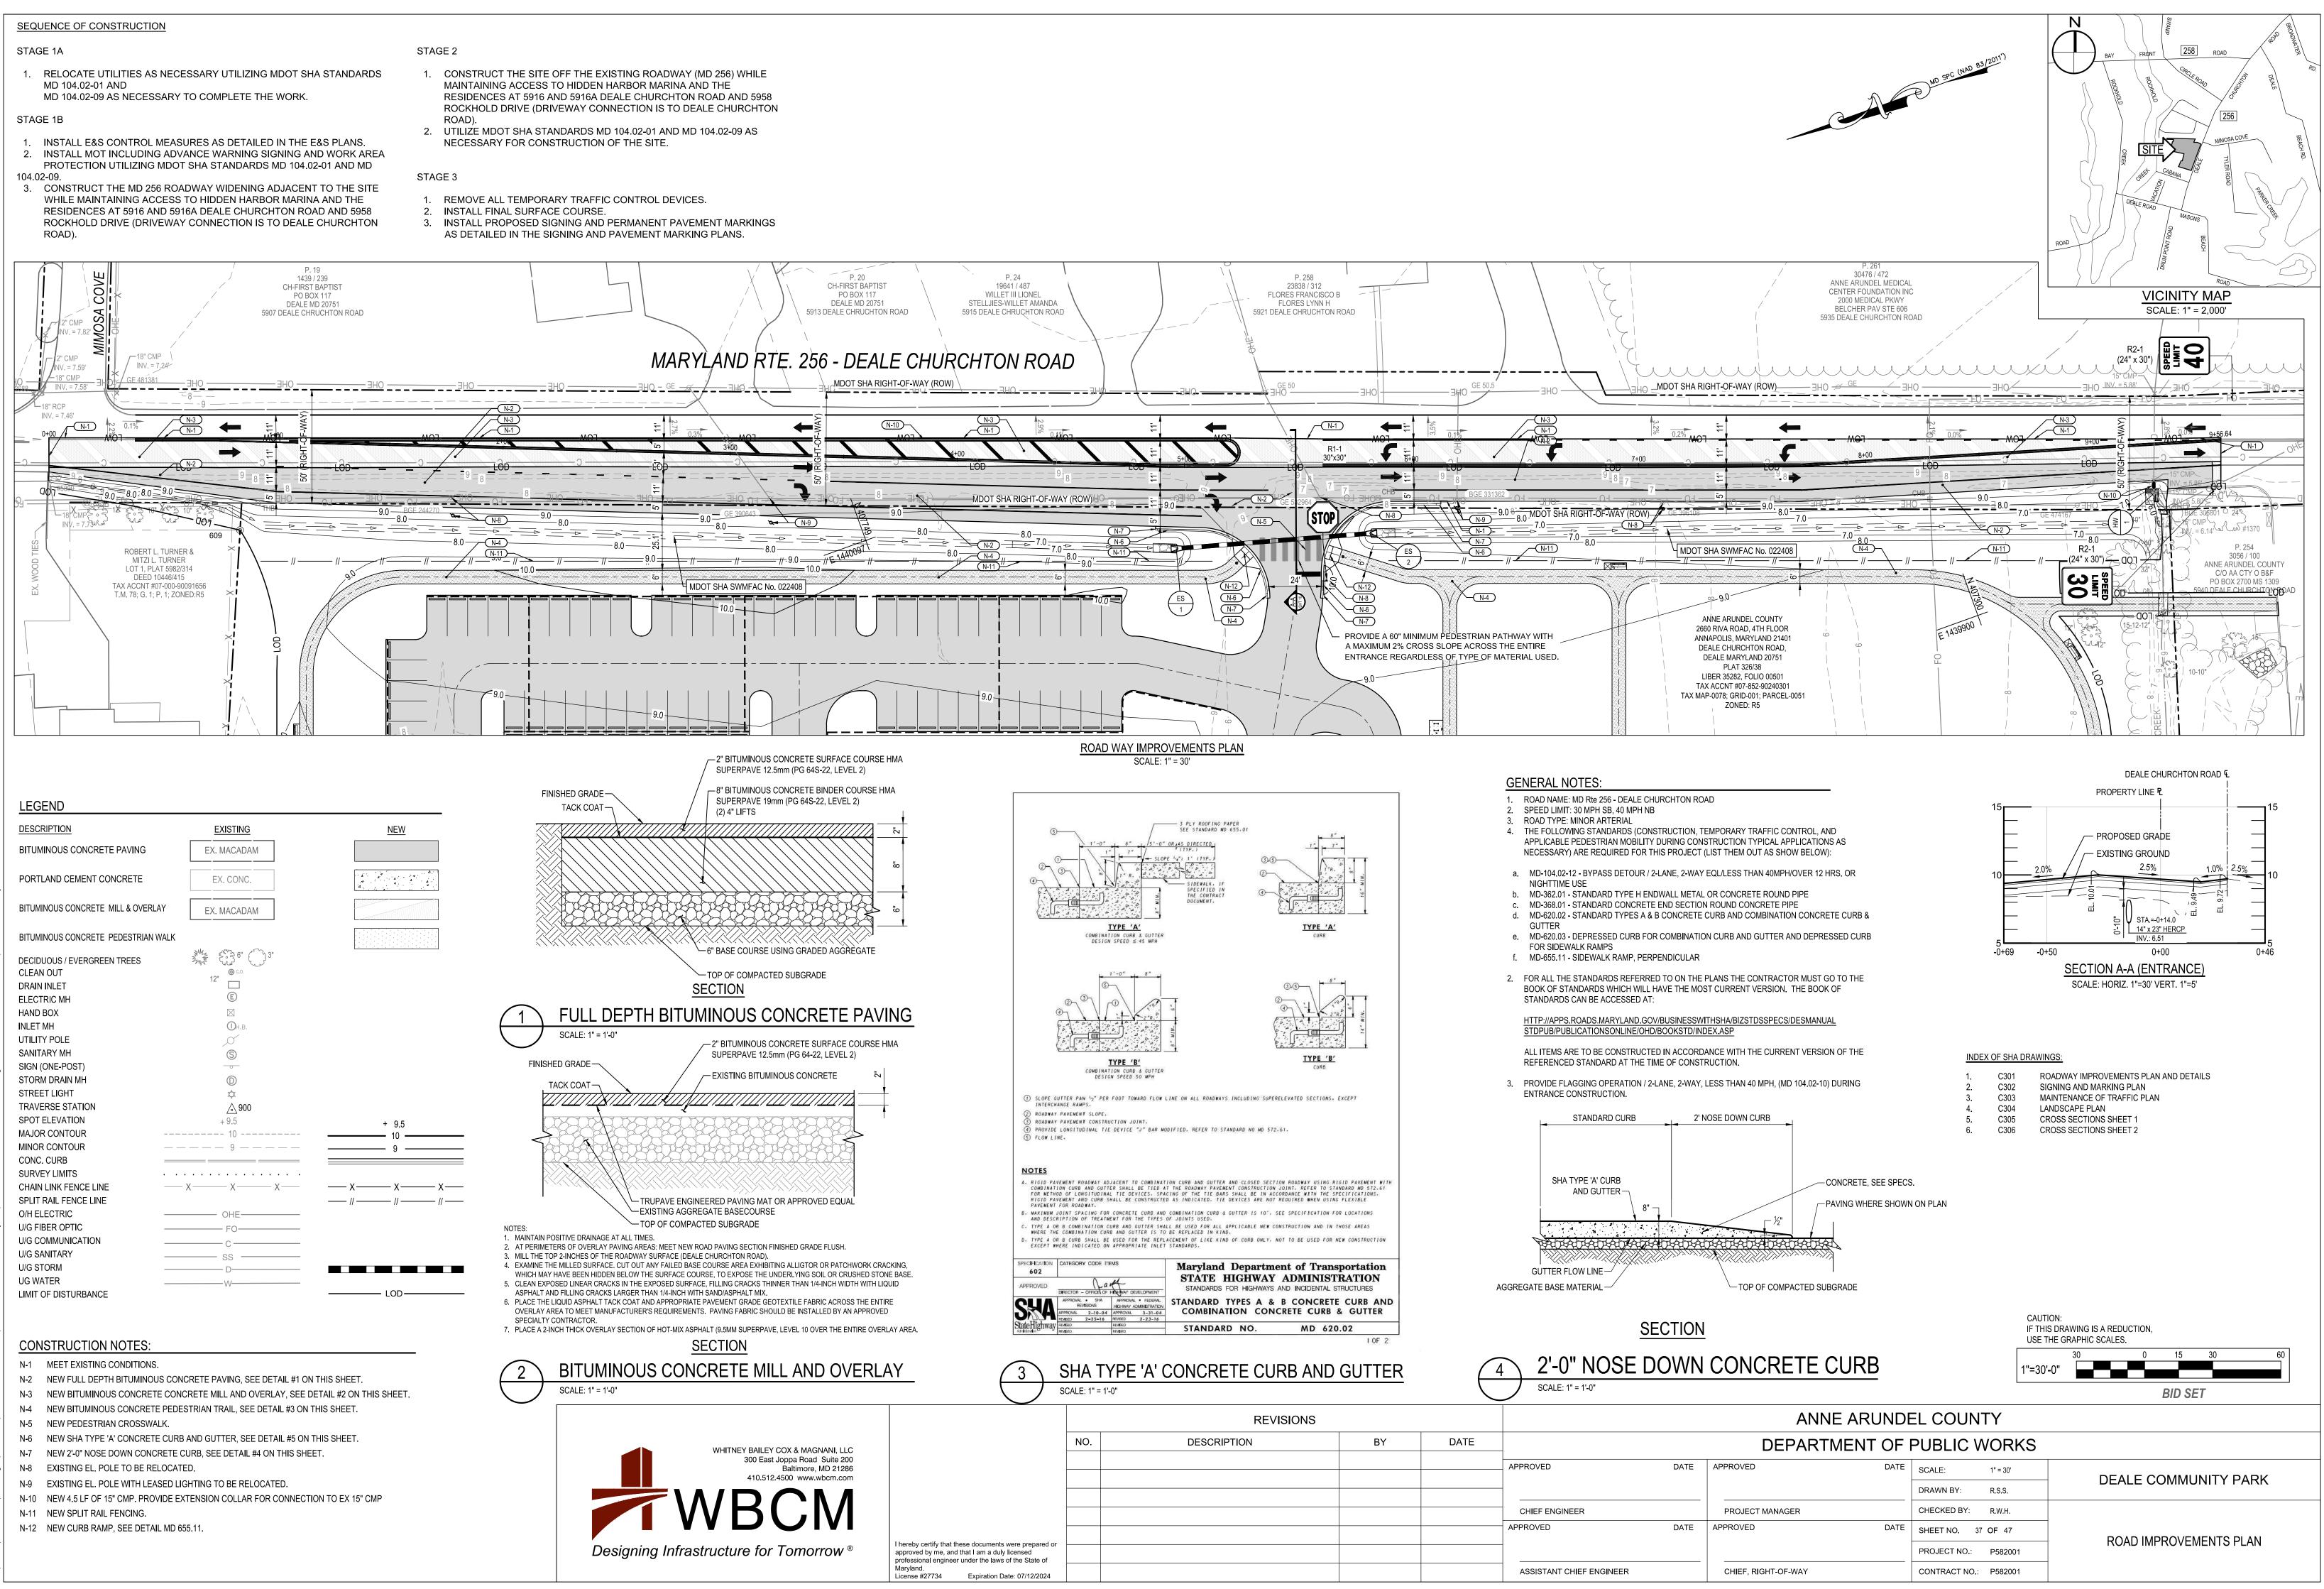

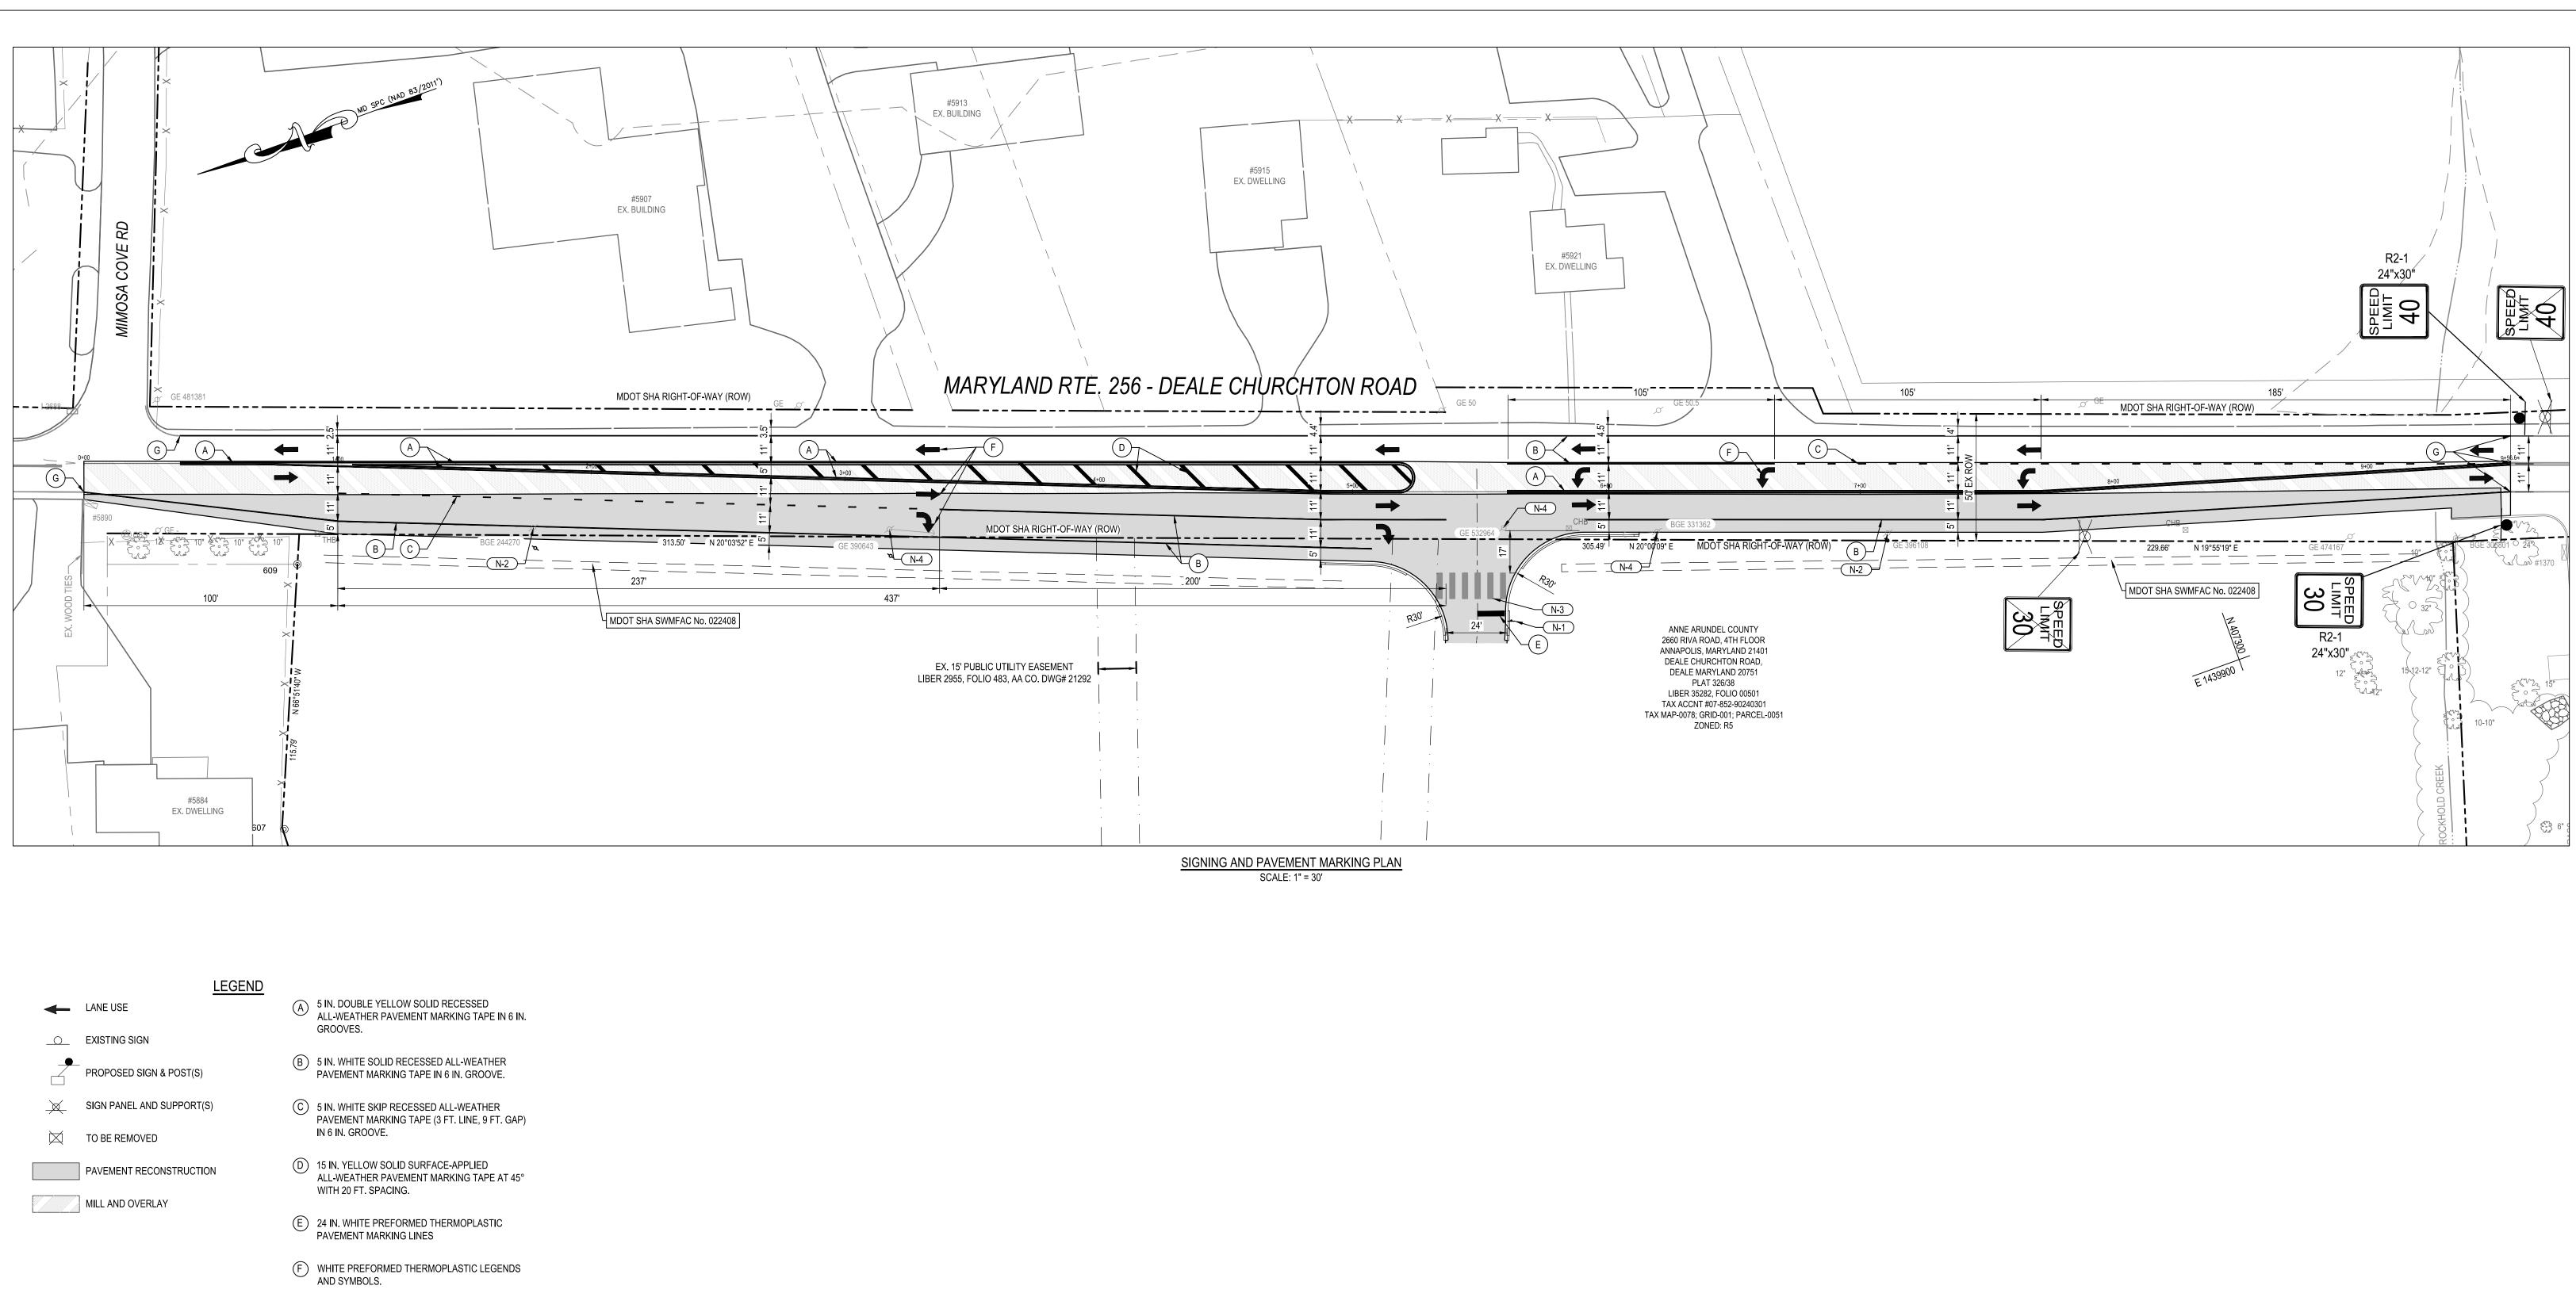

- G TIE TO EXISTING PAVEMENT MARKING


CONSTRUCTION NOTES:

- N-1 REFER TO C302 FOR SIGN
- N-2 EXISTING EL. POLE TO BE RELOCATED.
- N-3 REFER TO SHEET NO. 06 FOR CROSSWALK MARKINGS.
- N-4 EXISTING EL. POLE WITH LEASED LIGHTING TO BE RELOCATED.



AILEY COX { 0 East Joppa Balt 10.512.4500	a Road imore	d Suite 200 , MD 21286
8 (
NSY	S T	EMS


		REVISIONS			
	NO.	DESCRIPTION	BY	DATE	
					APPROVED
					CHIEF ENGINEER
I hereby certify that these documents were prepared or approved by me, and that I am a duly licensed professional engineer under the laws of the State of					APPROVED
Maryland. License #27734 Expiration Date: 07/12/2024					ASSISTANT CHIEF ENG

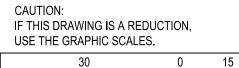


1"=30'-0"

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	DEPARTMENT OF PUBLIC WORKS					
DATE	APPROVED DATE	SCALE: 1" = 30'	DEALE COMMUNITY PARK			
		DRAWN BY: IJM				
	PROJECT MANAGER	CHECKED BY: JRS				
DATE	APPROVED DATE	SHEET NO. 38 OF 47	SIGNING AND PAVEMENT MARKING PLAN			
		PROJECT NO.: P582001				
NGINEER	CHIEF, RIGHT-OF-WAY	CONTRACT NO.: P582001				



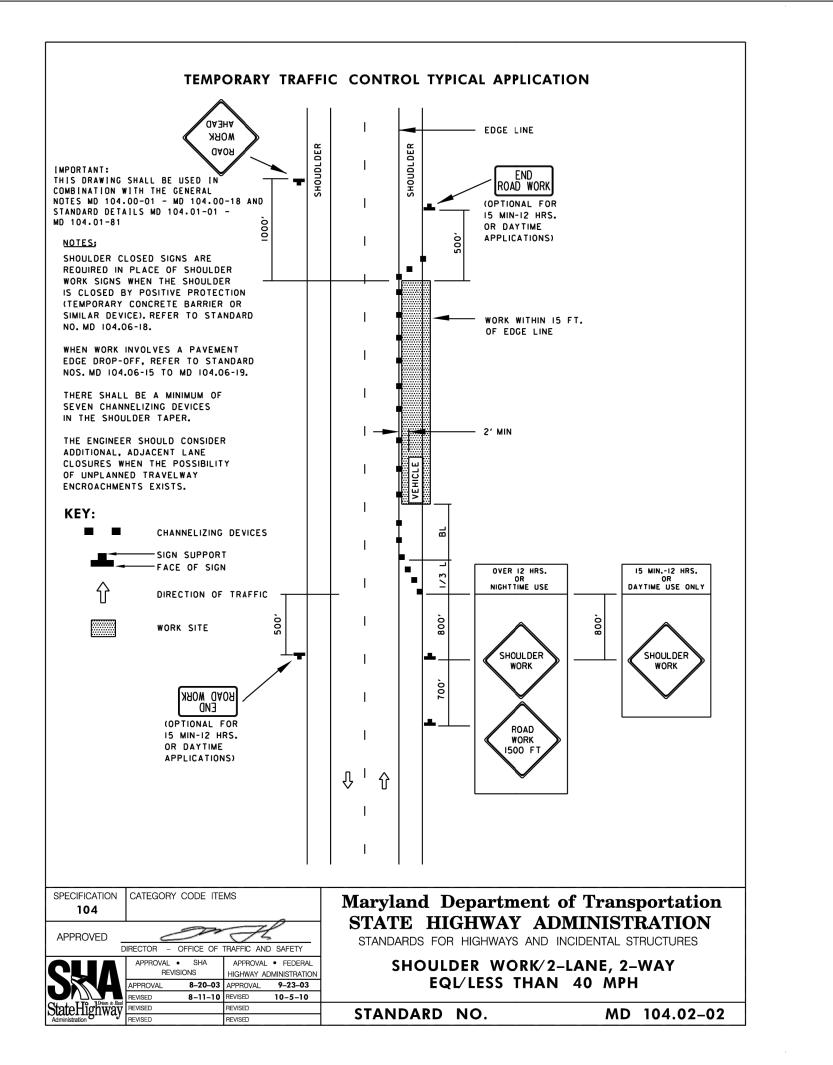

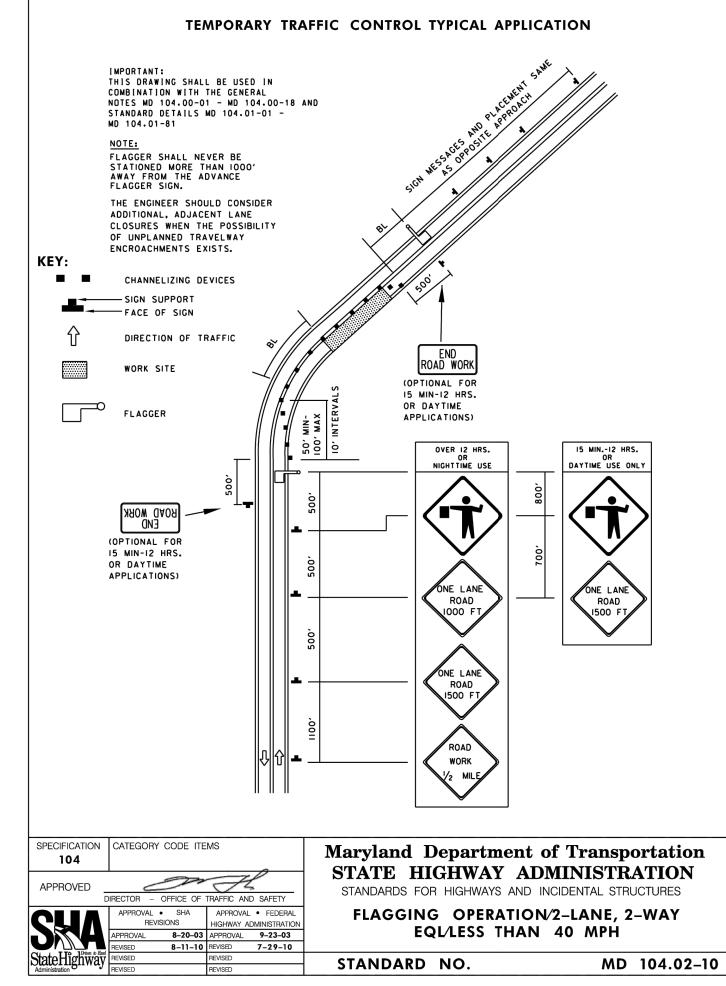

TRAFFIC CONTROL GENERAL NOTES

- 1. ALL STANDARD REGULATORY, WARNING AND CONSTRUCTION SIGNS USED FOR MAINTENANCE OF TRAFFIC SHALL BE IN ACCORDANCE WITH THE LATEST EDITION OF THE MARYLAND MANUAL ON UNIFORM TRAFFIC CONTROL DEVICES AND THE MARYLAND EDITION OF STANDARD HIGHWAY SIGNS.
- 2. TEMPORARY TRAFFIC SIGNS SHALL BE INSTALLED IN ACCORDANCE WITH THE MARYLAND DEPARTMENT OF TRANSPORTATION STATE HIGHWAY ADMINISTRATION (MDOT SHA) STANDARDS FOR HIGHWAYS AND INCIDENTAL STRUCTURES, SECTION 104.00-06 & 07, MARYLAND MANUAL ON UNIFORM TRAFFIC CONTROL DEVICES, ANNE ARUNDEL COUNTY DEPARTMENT OF PUBLIC WORKS STANDARD SPECIFICATIONS FOR CONSTRUCTION, AND AS APPROVED BY THE ENGINEER.
- 3. CONTRACTOR SHALL FIELD LOCATE ALL TEMPORARY SIGNS TO BE INSTALLED ON WOOD SUPPORTS A MINIMUM OF 7 CALENDAR DAYS PRIOR TO INITIATING WORK. CONTRACTOR MUST RECEIVE WRITTEN APPROVAL OF THE SIGN LOCATIONS AND MOUNTINGS FROM THE ENGINEER PRIOR TO INSTALLATION.
- 4. ALL TEMPORARY TRAFFIC SIGN LOCATIONS MAY BE ADJUSTED TO FIT FIELD CONDITIONS AS APPROVED BY THE ENGINEER.
- 5. ALL TEMPORARY TRAFFIC SIGNS SHALL BE PLACED SO THAT THEY DO NOT OBSTRUCT EXISTING TRAFFIC CONTROL DEVICES OR CREATE SIGHT DISTANCE OBSTRUCTIONS FROM CROSS STREETS OR DRIVEWAYS.
- 6. BUSINESS AND RESIDENCE ACCESS MUST BE MAINTAINED DURING CONSTRUCTION OPERATIONS.
- 7. CONTRACTOR IS RESPONSIBLE FOR MAINTAINING ALL TRAFFIC CONTROL DEVICES.
- 8. ALL SIGNS SHALL CONFORM TO CURRENT MDOT SHA MATERIAL AND REFLECTIVITY REQUIREMENTS.
- 9. ALL CONFLICTING EXISTING SIGNING SHALL BE COVERED/MODIFIED.
- 10. TRUCK CROSSING SIGNS (W11-10(1)) SHALL BE INSTALLED IN ADVANCE OF CONSTRUCTION ACCESS POINTS PER MDOT SHA STANDARDS MD 104.00-08 AND MD 104.00-13.
- 11. THE SHOULDER CLOSURE FOR WORK ADJACENT TO THE ROADWAY SHALL BE IN CONFORMANCE WITH MDOT SHA STANDARD MD 104.02-01 UNLESS OTHERWISE NOTED.
- 12. REFER TO EROSION AND SEDIMENT CONTROL PLANS FOR FURTHER DETAILS REGARDING THE SEQUENCE OF CONSTRUCTION.
- 13. THE LUMP SUM PAY ITEM FOR MAINTENANCE OF TRAFFIC PROVIDES COMPENSATION FOR ALL MATERIALS, TOOLS, LABOR, AND INCIDENTALS NECESSARY TO MAINTAIN TRAFFIC THROUGH THE WORK ZONE WHICH ARE NOT INCLUDED IN OTHER CONTRACT PAY ITEMS.

AILEY COX & MAGNANI, LLC 0 East Joppa Road Suite 200	
Baltimore, MD 21286 10.512.4500 www.wbcm.com	
BCM	
ANSYSTEMS	

	NO.	DESCRIPTION	BY	DATE	
					APPROVED
					CHIEF ENGINEER
					APPROVED
hereby certify that these documents were prepared or approved by me, and that I am a duly licensed professional engineer under the laws of the State of					
Maryland. License #27734 Expiration Date: 07/12/2024					ASSISTANT CHIEF EN


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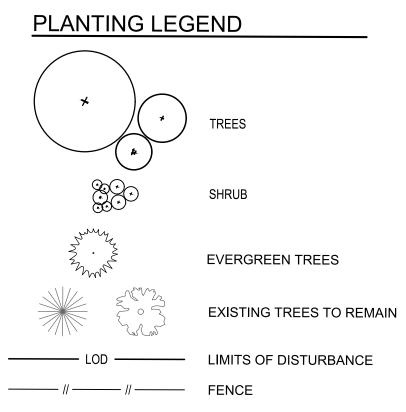
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ANNE ARUNDEL COUNTY

DEPARTMENT OF PUBLIC WORKS

		/				
DATE	APPROVED DA	ATE	SCALE:	N.T.S.	DEALE COMMUNITY PARK	
			DRAWN BY:	I.J.M.		
	PROJECT MANAGER		CHECKED BY:	J.R.S.		
DATE	APPROVED DA	ATE	SHEET NO. 39	OF 47		
			PROJECT NO.:	P582001	MAINTENANCE OF TRAFFIC PLAN	
NGINEER	CHIEF, RIGHT-OF-WAY		CONTRACT NO.:	P582001		
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			REVISIONS	6		
EY COX & MAGNANI, LLC		NO.	DESCRIPTION	BY	DATE	
ast Joppa Road Suite 200 Baltimore, MD 21286 512.4500 www.wbcm.com						APPROVED
						_
CM						CHIEF ENGINEER
						APPROVED
ISYSTEMS	I hereby certify that these documents were prepared or approved by me, and that I am a duly licensed professional engineer under the laws of the State of					_
	Maryland. License #27734 Expiration Date: 07/12/2024					ASSISTANT CHIEF END




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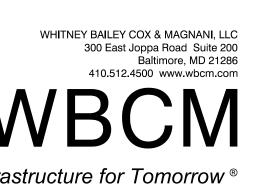
1"=30'-0" BID SET

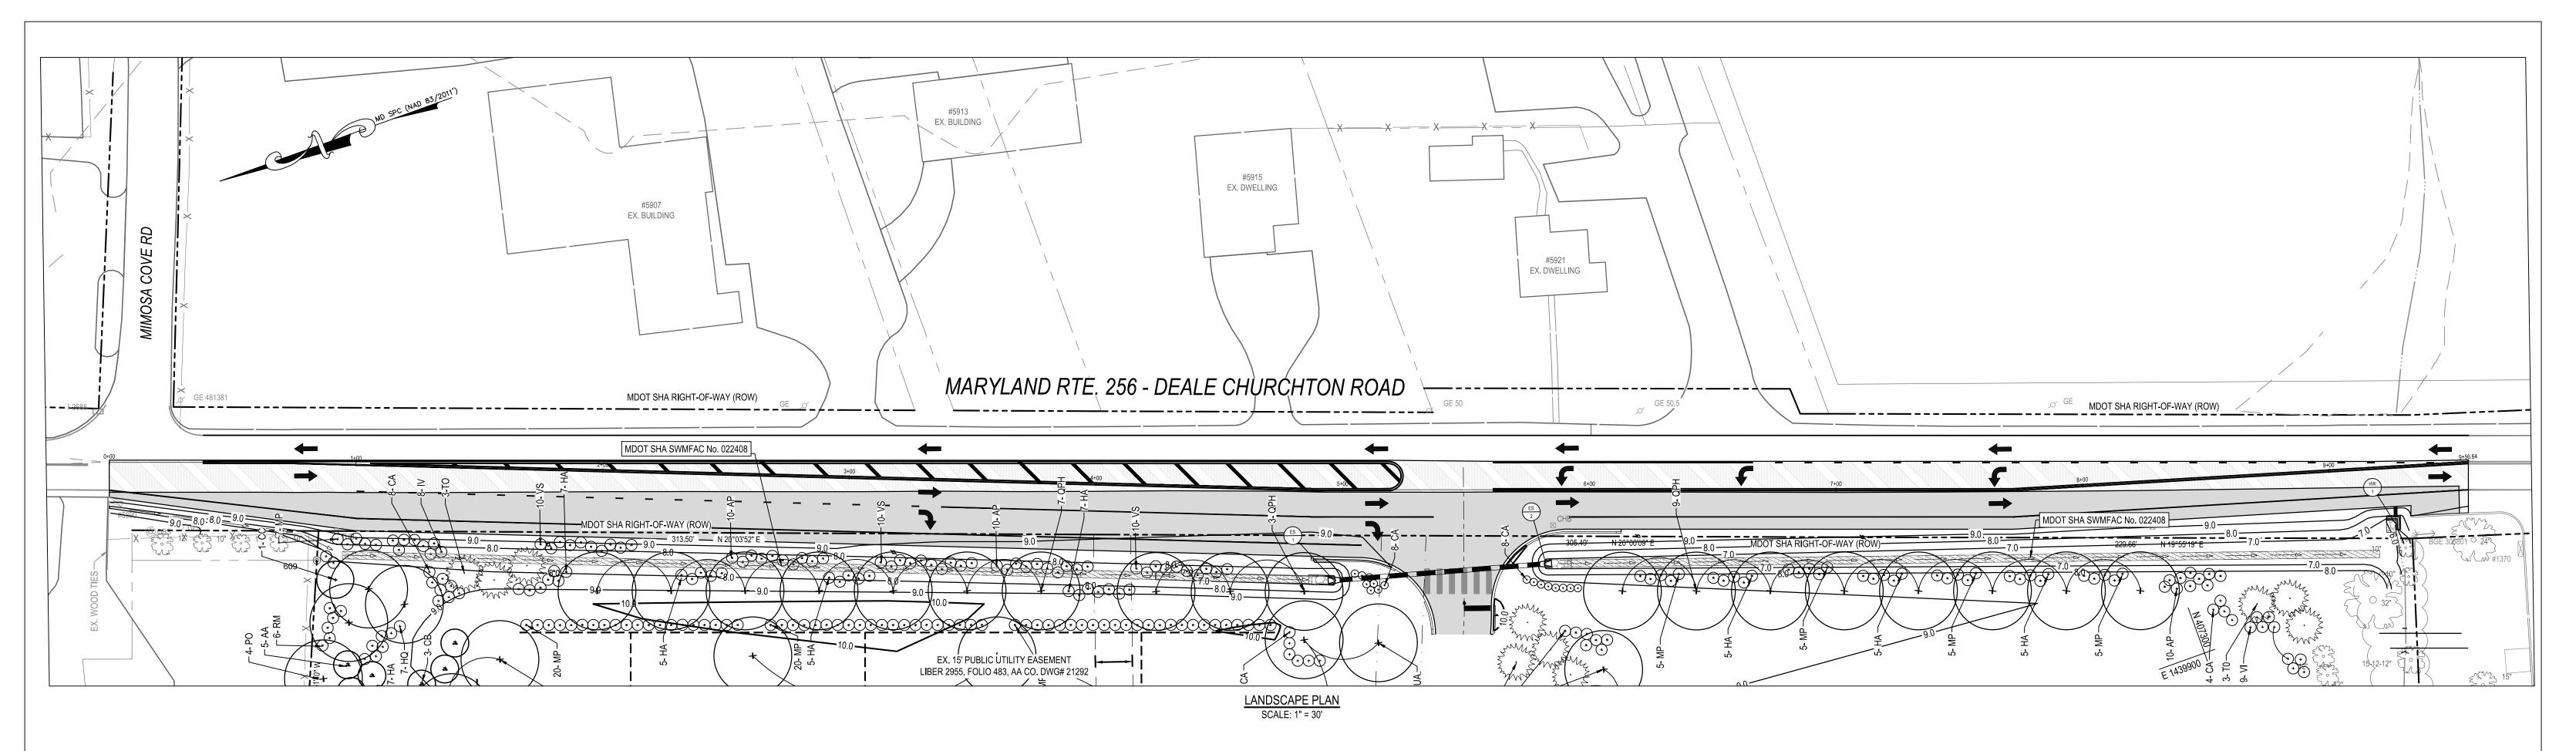ANNE ARUNDEL COUNTY

DEPARTMENT OF PUBLIC WORKS DATE SCALE: 1" = 30' DATE APPROVED DEALE COMMUNITY PARK DRAWN BY: IJM PROJECT MANAGER CHECKED BY: JRS DATE APPROVED DATE SHEET NO. 40 OF 47 LANDSCAPE PLAN PROJECT NO.: P582001 CHIEF, RIGHT-OF-WAY IGINEER CONTRACT NO.: P582001

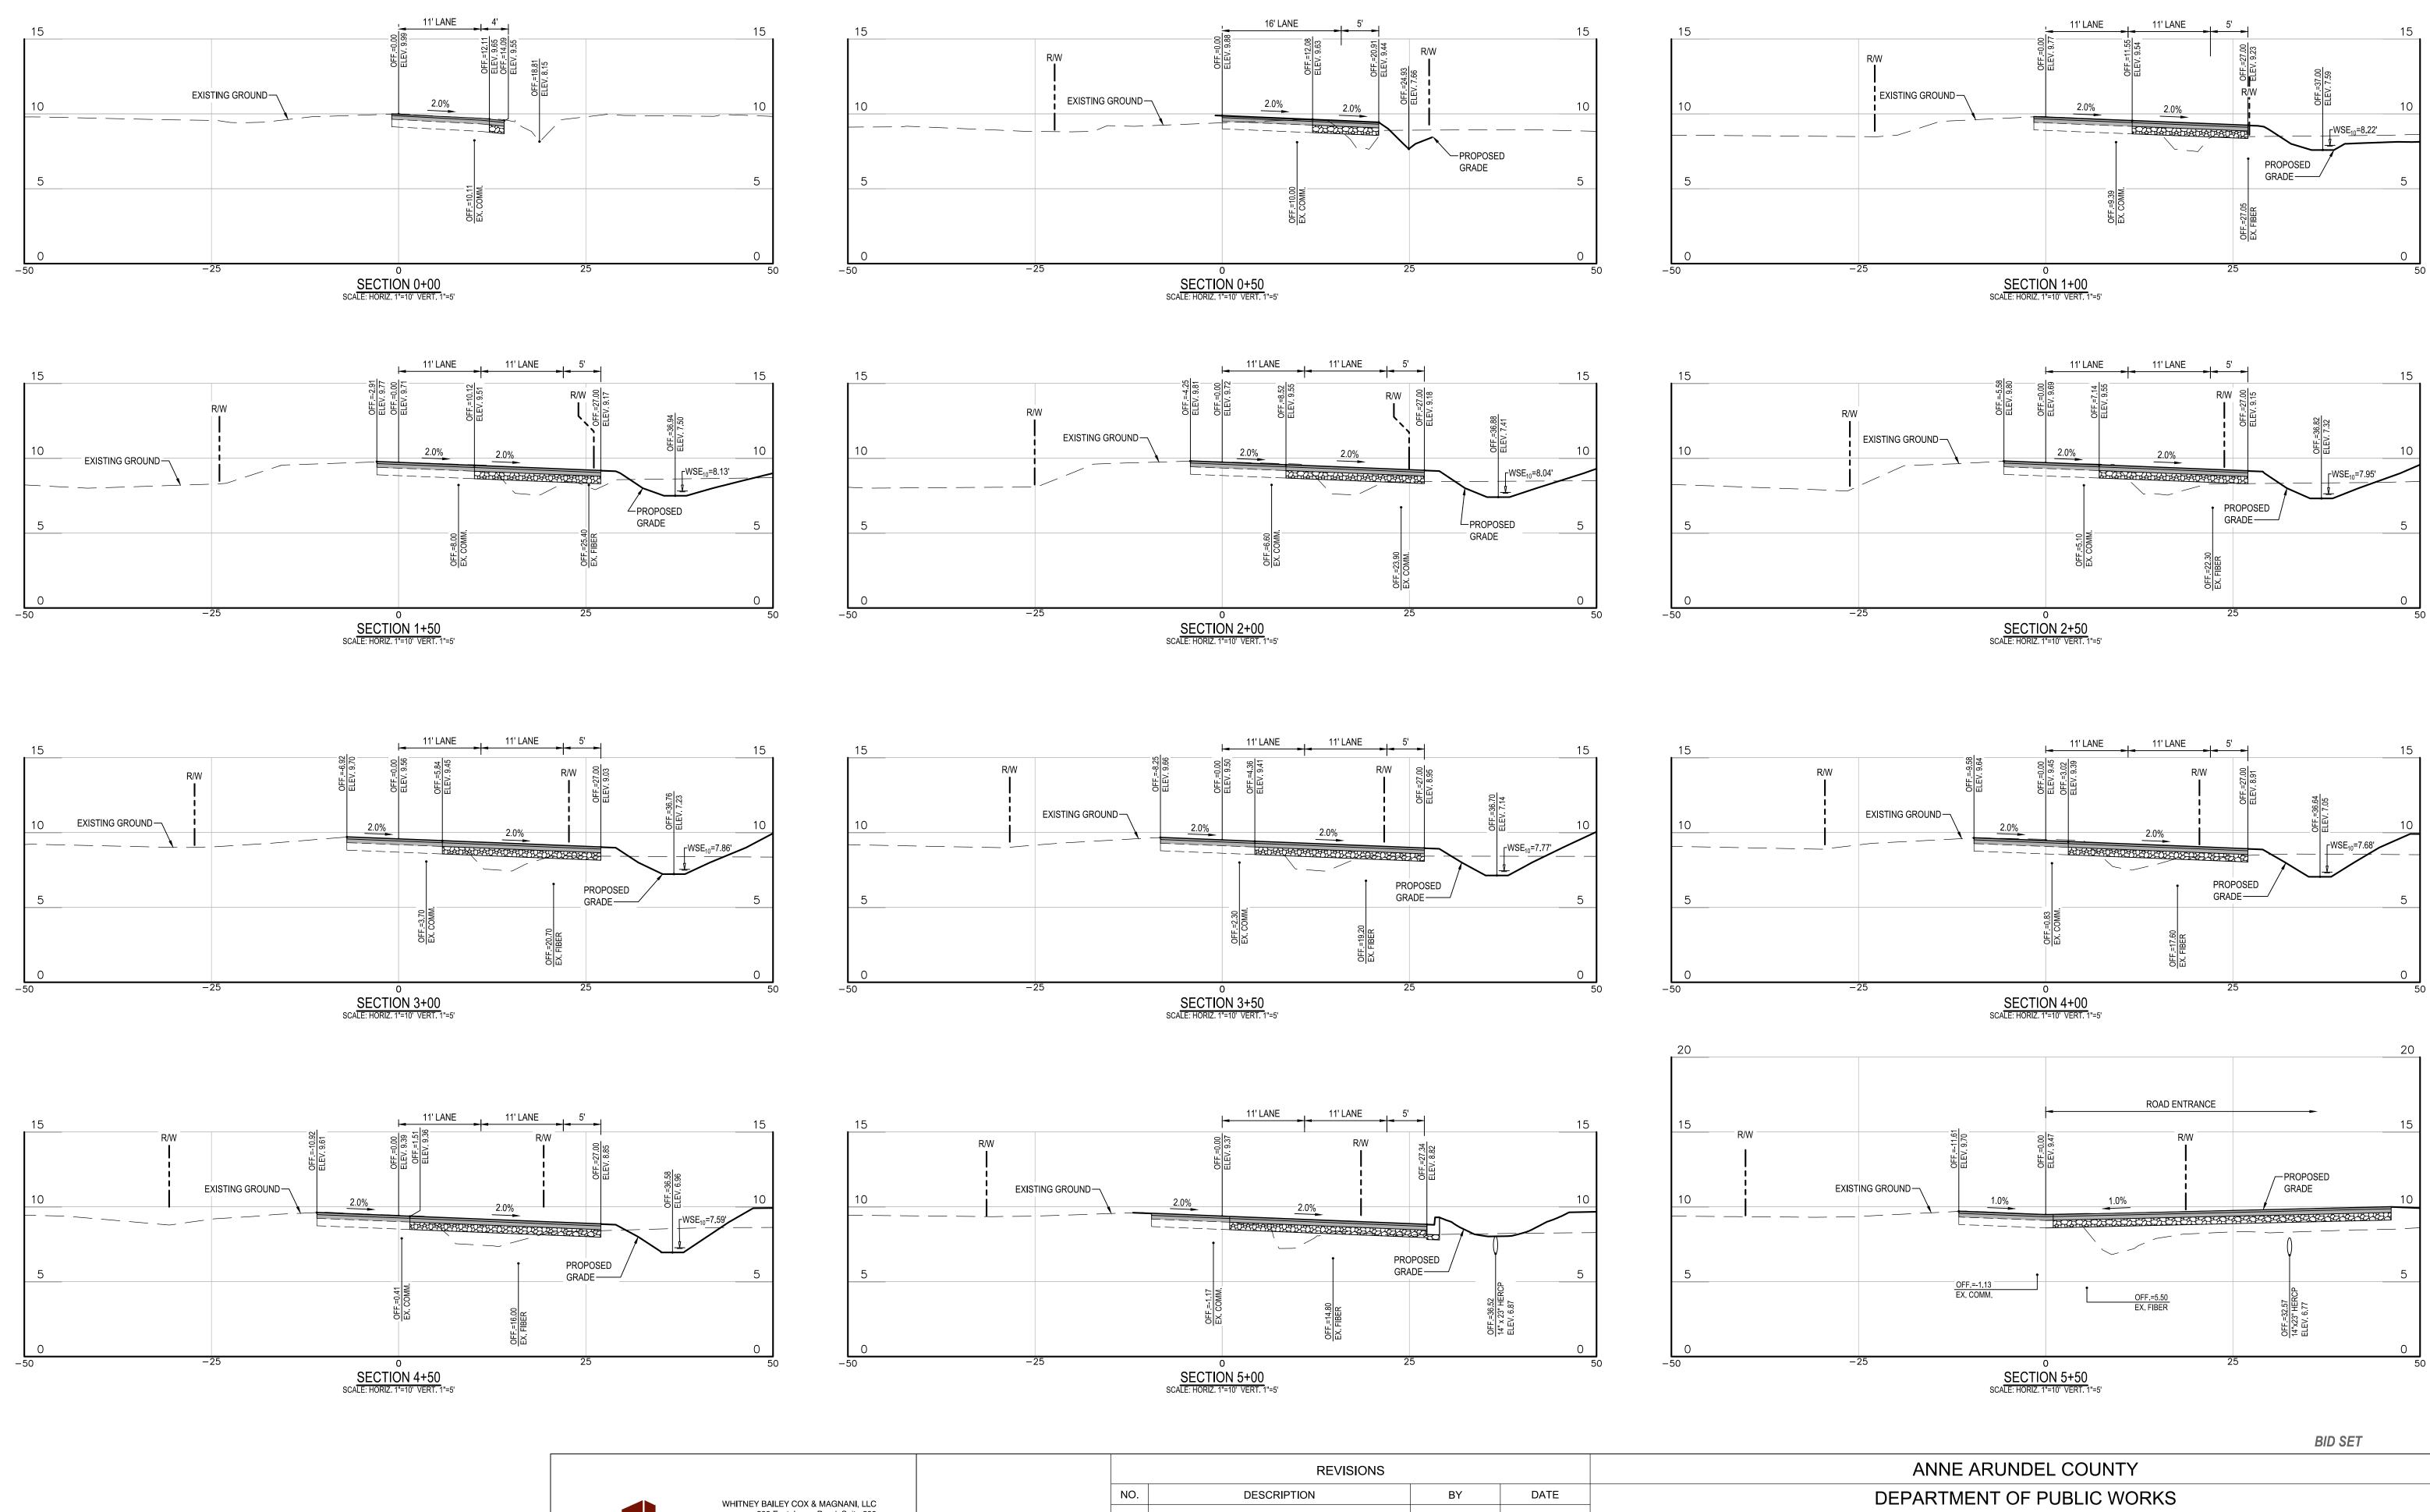


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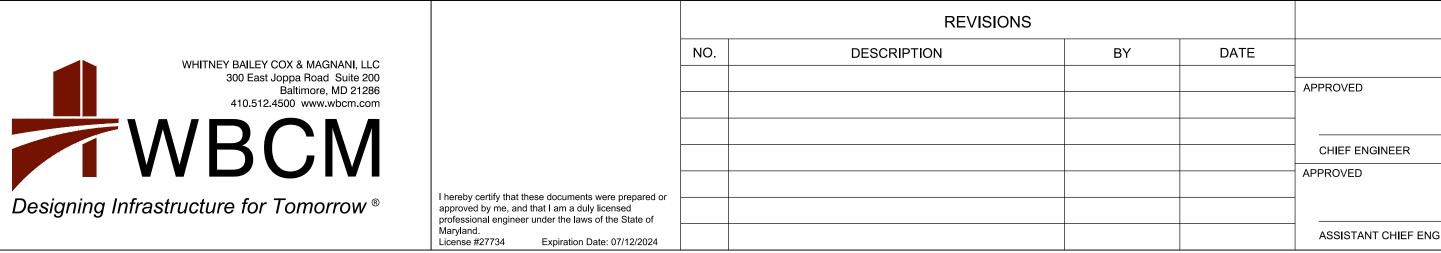



		REVISIONS	6		
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					ASSISTANT CHIEF EN


I hereby certify that approved by me, an professional engined Maryland. License #27734 Expiration Date: 07/12/2024

	DEPARTMENT OF PUBLIC WORKS						
DATE	APPROVED	DATE	SCALE: 1" = 10'	DEALE COMMUNITY PARK			
			DRAWN BY: R.S.S.				
	PROJECT MANAGER		CHECKED BY: R.W.H.				
DATE	APPROVED	DATE	SHEET NO. 41 OF 47	ROAD CROSS SECTIONS			
			PROJECT NO.: P582001	RUAD URUSS SEUTIONS			
GINEER	CHIEF, RIGHT-OF-WAY		CONTRACT NO.: P582001				



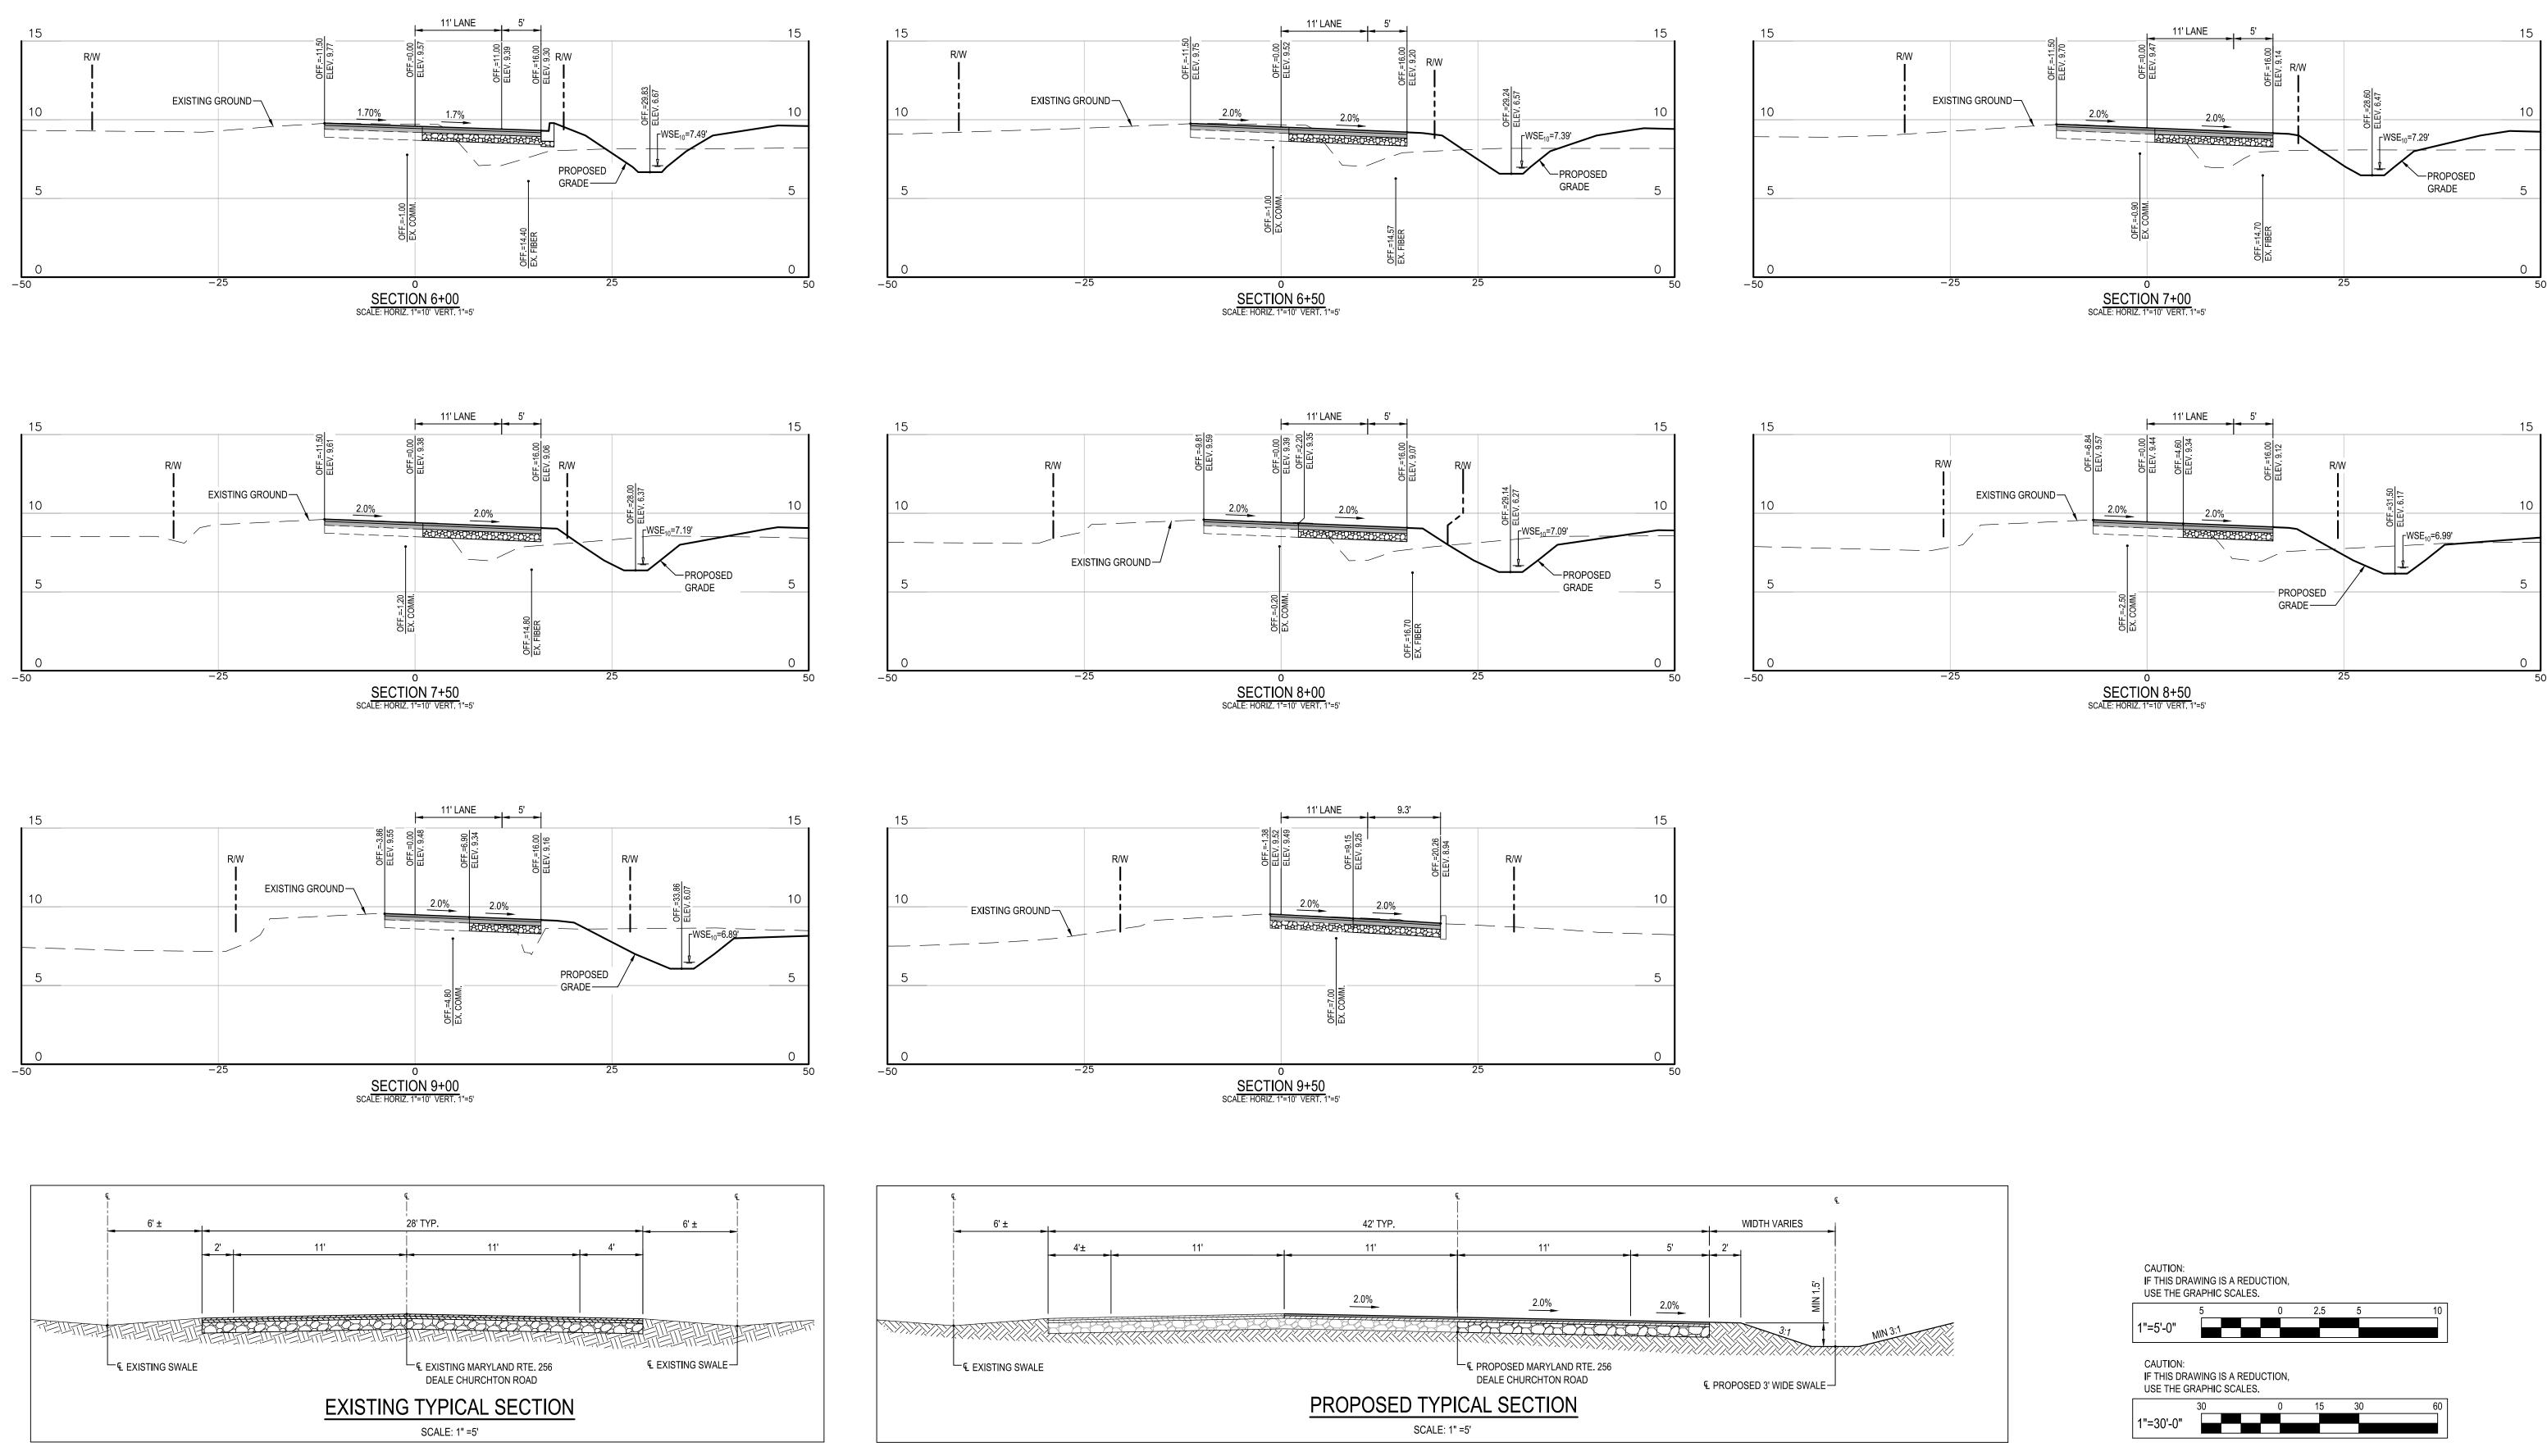

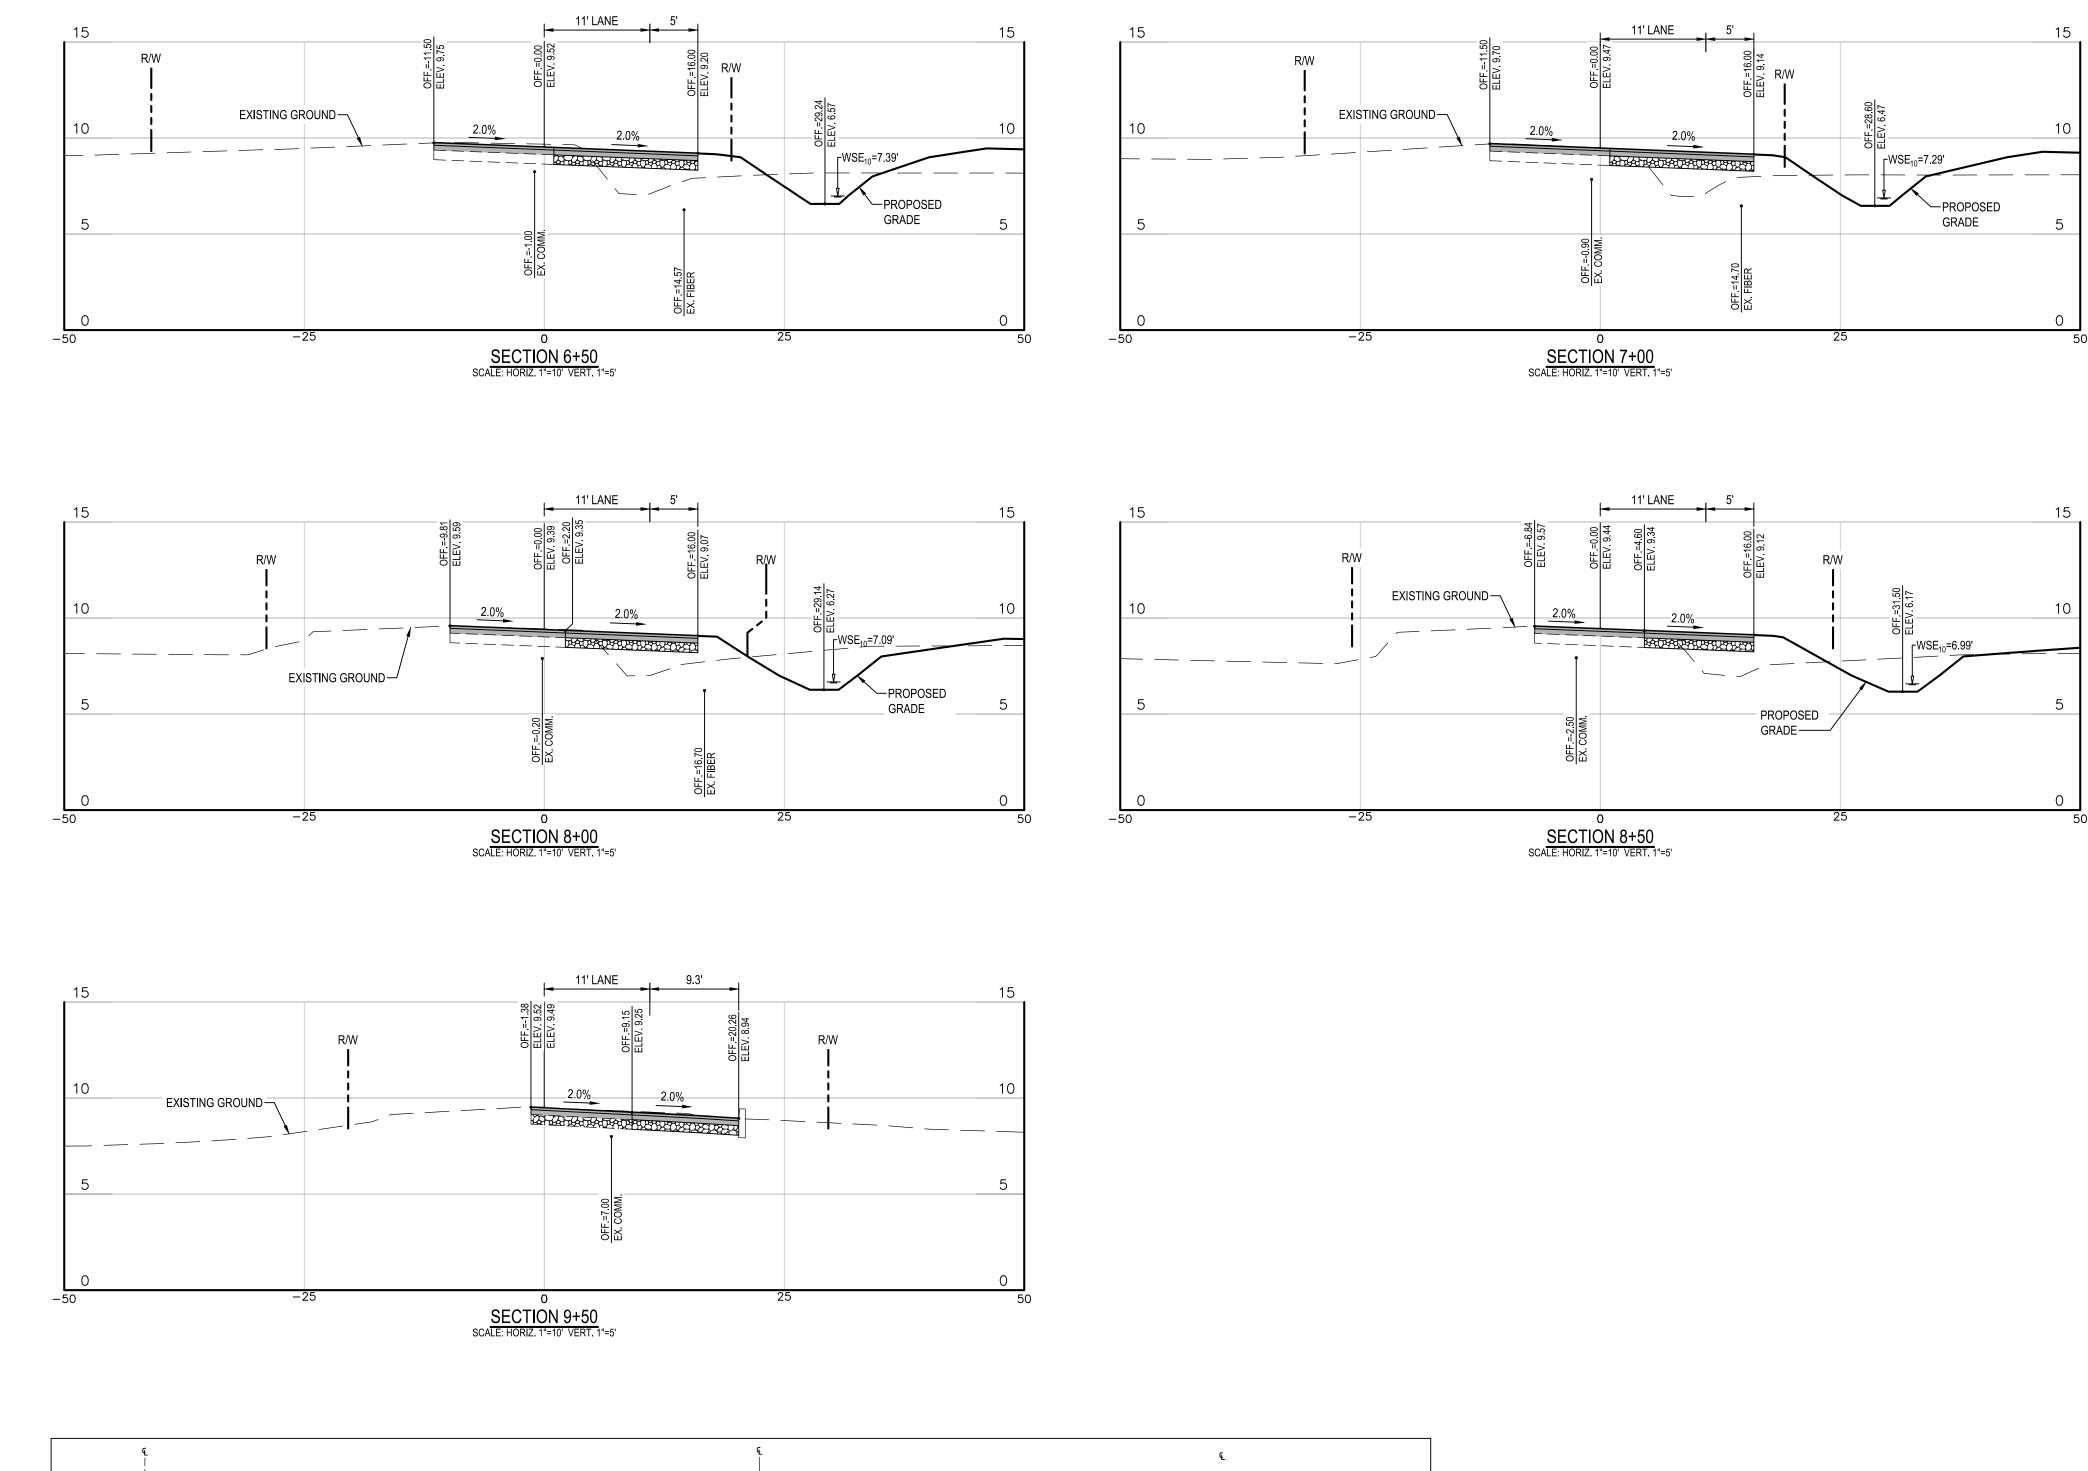

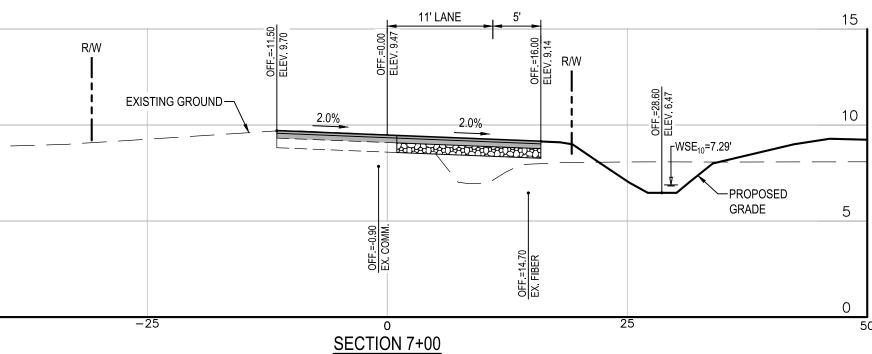

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	DEPARTMENT OF PUBLIC WORKS							
DATE	APPROVED DATE	SCALE: 1" = 10'	DEALE COMMUNITY PARK					
		DRAWN BY: R.S.S.						
	PROJECT MANAGER	CHECKED BY: R.W.H.						
DATE	APPROVED DATE	SHEET NO. 42 OF 47						
		PROJECT NO.: P582001	ROAD CROSS SECTIONS					
NGINEER	CHIEF, RIGHT-OF-WAY	CONTRACT NO.: P582001						


	GENERAL NOTES
۱.	CODE ALL CONSTRUCTION SHALL CONFORM TO 2018 INTERNATIONAL BUILDING CODE, AND ANNE ARUNDEL COUNTY LOCAL AMENDMENTS. DESIGN LOADING THE DESIGN DEAD LOAD FOR THE ROOF FRAMING IS:
5.	20 PSF TOTAL 12 PSF DEAD LOAD USED IN LOAD COMBINATIONS WHICH INCLUDE WIND. TOTAL DEAD LOAD = 10 PSF THE FOLLOWING LIVE LOADS WERE USED IN DESIGN: IBC 1603.1.2 - ROOF LIVE LOAD = 30 PSF
	IBC 1603.1.3 - ROOF SNOW LOAD
	GROUND SNOW LOAD (P_G) = 20 PSF FLAT SNOW LOAD (P_F) = 17 PSF SNOW EXPOSURE FACTOR (C_F) = 1.0 SNOW LOAD IMPORTANCE FACTOR (I) = 1.0 THERMAL FACTOR (C_T) = 1.2 SLOPE FACTOR (CS) = 1.0 SLOPED SNOW LOAD (PS) = 17 PSF
	IBC 1603,1.4 - WIND LOAD ULTIMATE DESIGN WIND SPEED (V _{ULT}) = 115 MPH NOMINAL DESIGN WIND SPEED (V _{ASD}) = 89 MPH RISK CATEGORY = II WIND EXPOSURE = C INTERNAL PRESSURE COEFFICIENT = ±0.18
	IBC 1603.1.5 - EARTHQUAKE DESIGN DATA RISK CATEGORY = II SEISMIC IMPORTANCE FACTOR (I _E) = 1.0 MAPPED SPECTRAL RESPONSE ACCELERATION PARAMETERS;
	S _S = 0.123 G S ₁ = 0.042 G SITE CLASS = D DESIGN SPECTRAL RESPONSE ACCELERATION PARAMETERS; S = -0.131 G
	S _{DS} = 0.131 G S _{D1} = 0.067 G SEISMIC DESIGN CATEGORY = A
	ALL STRUCTURAL COMPONENTS HAVE BEEN DESIGNED FOR THE DEAD LOADS SHOWN ON THE PLANS AND THE LIVE LOADS SHOWN ABOVE. IT IS THE CONTRACTOR'S RESPONSIBILITY TO DETERMINE OWABLE CONSTRUCTION LOADS AND TO PROVIDE PROPER DESIGN AND CONSTRUCTION OF THOSE ITEMS NECESSARY TO FACILITATE CONSTRUCTION INCLUDING BUT NOT LIMITED TO FALSEWORK, FORMA AGING, BRACING, SHEETING AND SHORING, ETC.
). PR(THE STABILITY OF THE STRUCTURE IS DEPENDENT UPON THE DIAPHRAGM ACTION OF THE ROOFS. THE CONTRACTOR IS COMPLETELY RESPONSIBLE FOR THE METHODS OF CONSTRUCTIONS AND SHA DVIDE ALL GUYS, BRACING AND SHORING REQUIRED TO ACCOMMODATE ALL INTERIM LOADING CONDITIONS THROUGHOUT THE CONSTRUCTION PHASE.
l. \.	GENERAL THE CONTRACTOR SHALL FIELD CHECK AND VERIFY ALL DIMENSIONS AND ELEVATIONS OF EXISTING WORK PRIOR TO FABRICATION OF ANY NEW MATERIALS.
1.)O(THE CONTRACTOR IS ADVISED THAT ALL PLANS, DIMENSIONS, AND DETAILS DEPICT FIELD CONDITION AS SHOWN. MINOR VARIATIONS ARE TO BE EXPECTED AND ANY DEVIATIONS FROM THE CONTRAC CUMENTS SHALL BE APPROVED BY THE ARCHITECT IN WRITING PRIOR TO PROCEEDING.
;)Al	IT IS THE CONTRACTOR'S RESPONSIBILITY TO SATISFY HIMSELF AS TO THE LOCATION OF ANY UTILITIES IN THE IMMEDIATE VICINITY OF CONSTRUCTION SO AS TO PREVENT DAMAGE TO THEM. SHOULD MAGE TO SUCH UTILITIES OCCUR THE CONTRACTOR SHALL BE REQUIRED TO REPAIR SUCH DAMAGE AT HIS OWN EXPENSE AND TO THE SATISFACTION OF THE OWNER.
). DEF	CONSULT THE ARCHITECTURAL, MECHANICAL AND ELECTRICAL DRAWINGS FOR VERIFICATION OF LOCATION AND DIMENSION OF CHASES, INSERTS, OPENINGS, SLEEVES, WASHERS, DRIPS, REVEALS, PRESSIONS AND OTHER PROJECT REQUIREMENTS.
1A`	ALL WORK SPECIFIED HEREIN SHALL BE INSPECTED IN ACCORDANCE WITH THE BUILDING CODE AND ALL LOCAL ORDINANCES. THE OWNER OR CONTRACTOR (SEE SPECIFICATIONS) SHALL HIRE AN PERIENCED, QUALIFIED INSPECTOR TO PERFORM ALL THE REQUIRED INSPECTION WORK. THE ENGINEER WILL NOT PERFORM THE REQUIRED INSPECTION AS A PART OF THEIR DESIGN SERVICES. THE ENGIN Y VISIT THE SITE TO ASCERTAIN GENERAL CONFORMANCE WITH THE CONTRACT DOCUMENTS. SUCH SITE VISITS ARE NOT TO BE CONSTRUED AS MEETING ANY INSPECTION REQUIREMENTS UNLESS THE EN- ECIFICALLY SO STATES IN WRITING.
)E]	ANY REVIEW OF STRUCTURAL ITEM SHOP DRAWINGS BY (THE STRUCTURAL ENGINEER) IS FOR GENERAL CONFORMANCE WITH THE DESIGN CONCEPT AS PRESENTED BY THE CONTRACT DOCUMENTS. TAILED CHECK OF QUANTITIES OR DIMENSIONS WILL BE MADE.
E\	AT THE TIME OF SHOP DRAWING SUBMISSION, THE GENERAL CONTRACTOR SHALL STATE IN WRITING ANY DEVIATION OR OMISSIONS FROM THE CONTRACT DOCUMENTS. THE GENERAL CONTRACTOR /IEW ALL SHOP DRAWINGS BEFORE SUBMISSION AND MAKE ALL CORRECTIONS AS HE DEEMS NECESSARY.
I. Of	SUBMIT SHOP DRAWINGS FOR SPECIFIC AREAS IN THEIR ENTIRETY. THAT IS, IN A GIVEN AREA OF THE BUILDING INCLUDE ALL COLUMNS, BASE PLATES, BEAMS AND CONNECTION DETAILS. SHOP DRAW R SIMILAR FLOORS SHALL BE SUBMITTED IN THE SAME PACKAGE.
	THE STRUCTURAL CONTRACT DOCUMENTS ARE NOT TO BE REPRODUCED FOR USE AS SHOP DRAWINGS.
NR/	SHOP DRAWINGS FOR ALL STRUCTURAL ELEMENTS SHOWN ON THE CONTRACT DOCUMENTS MUST BE SUBMITTED BY THE GENERAL CONTRACTOR. IF A CONTRACTOR OR OWNER FAILS TO SUBMIT TH AWINGS, THE ENGINEER WILL NOT BE RESPONSIBLE FOR THE STRUCTURAL CERTIFICATION OR FOR THE DESIGN OF THE PROJECT.
/.	FOUNDATIONS
١.	SPREAD FOOTING FOUNDATIONS
•	BOTTOM OF ALL EXTERIOR FOOTINGS SHALL BE A MINIMUM OF 2'-6" BELOW FINISH GRADE OR 1'-0" BELOW EXISTING GRADE, WHICHEVER IS GREATER, UNLESS NOTED OTHERWISE ON THE DRAWINGS. SEE PLANS FOR EXISTING AND FINISHED GRADES.
•	ALL FOOTINGS HAVE BEEN DESIGNED FOR AN ASSUMED NET SOIL BEARING PRESSURE OF 2000 PSF PER THE GEOTECHNICAL REPORT BY SCHNABEL ENGINEERING DATED OCTOBER 19, 2022. IT SHALL BE T CONTRACTOR'S RESPONSIBILITY TO SECURE THE SERVICES OF A GEOTECHNICAL ENGINEER FOR FIELD VERIFICATION OF THE SOIL BEARING PRESSURES. SHOULD THE SOIL BEARING PRESSURE BE FOUN LESS THAN THIS VALUE THE CONTRACTOR SHALL IMMEDIATELY NOTIFY THE ENGINEER. IN THIS CASE, THE FOOTINGS WILL EITHER HAVE TO BE LOWERED OR RE-DESIGNED. CONTRACTOR SHALL RECEIVE T APPROVAL OF THE TESTING AGENCY PRIOR TO POURING ALL FOUNDATIONS.
•	ALL FILL UNDER FOOTINGS AND SLABS SHALL BE COMPACTED TO AT LEAST 95 PERCENT OF MAXIMUM DRY DENSITY PER ASTM D-1577, MODIFIED PROCTOR.


- OPERATIONS.
- V. CAST-IN-PLACE CONCRETE
- A. GENERAL CONSTRUCTION
- 1. ALL CONCRETE WORK SHALL CONFORM TO THE LATEST APPROVED (BY LOCAL GOVERNMENT) EDITIONS OF THE FOLLOWING A.C.I. AND A.S.T.M. DOCUMENTS:

	·
ACI-302,1R	FLOOR AND SLAB CONSTRUCTION
ACI-318	BUILDING CODE REQUIREMENTS FOR REINFORCED
	CONCRETE
ACI-214	COMPRESSION TESTS
ACI-306	COLD WEATHER
ACI-315	DETAILING
ACI-347	FORMWORK
ACI-305	HOT WEATHER
ACI-211	PROPORTIONS OF CONCRETE
ACI-304	PLACING CONCRETE
ASTM C94	READY-MIX CONCRETE

2. ALL FIELD AND LAB TESTING OF CONCRETE SHALL CONFORM TO THE LATEST APPROVED (BY LOCAL GOVERNMENT) EDITIONS OF ASTM:

ASTM C31	FIELD CYLINDER SPECIMENS
ASTM C143	SLUMP TEST
ASTM C231	AIR CONTENT (WHEN REQUIRED)
ASTM C39	LAB TESTING CYLINDERS
ASTM C172	SAMPLING FRESH CONCRETE
ASTM C42	HARDENED CORES (WHEN REQUIRED)

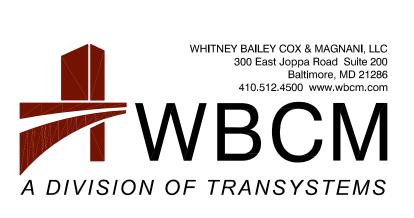

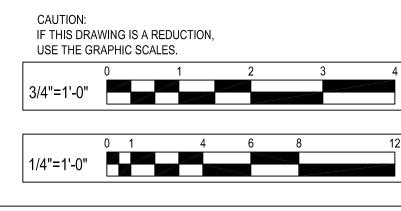

NNE ARUNDEL COUNTY LOCAL AMENDMENTS.

- 3. THE CONTRACTOR IS CAUTIONED THAT THE SCHEDULED CONSTRUCTION SEQUENCE FOR THE CONCRETE WORK MAY REQUIRE HIGHER CONCRETE STRENGTHS FOR SUPPORT OF CONSTRUCTION LOADINGS. CONCRETE MEMBERS CANNOT CARRY THEIR DESIGN LOADING UNTIL THE SPECIFIED 28-DAY COMPRESSIVE STRENGTHS ARE OBTAINED. CONTRACTOR SHALL INCREASE CONCRETE STRENGTHS AS REQUIRED.
- 4. ALL CONCRETE SHALL BE STONE AGGREGATE CONCRETE HAVING A MINIMUM COMPRESSIVE STRENGTH OF 4000 PSI AT 28 DAYS. ALL CONCRETE EXPOSED TO WEATHER SHALL HAVE AN AIR ENTRAINMENT OF 5%±1%. NO ADMIXTURES CONTAINING CALCIUM CHLORIDE SHALL BE PERMITTED. MAXIMUM AGGREGATE SIZE FOR CONCRETE SHALL BE 1", AND MAXIMUM SLUMP SHALL BE 4", AND 3" FOR SLABS ON GRADE. ALL CONCRETE, EXCEPT FOOTINGS, SHALL CONTAIN A WATER REDUCING ADMIXTURE.
- 5. ALL CONCRETE MIX DESIGNS AND ADMIXTURES SHALL BE APPROVED BY THE ENGINEER 30 DAYS PRIOR TO INITIATION OF FIRST POUR.
- 6. ALL REINFORCING BARS SHALL CONFORM TO ASTM A-615 GRADE 60. WELDED WIRE FABRIC SHALL CONFORM TO ASTM A-185.
- 7. ALL CONCRETE SHALL BE SAMPLED AND TESTED BY AN AGENCY RETAINED BY THE CONTRACTOR. THE CONTRACTOR SHALL NOTIFY THE TESTING AGENCY 48 HOURS PRIOR TO THE POURING OF ANY CONCRETE.
- 8. TESTING FREQUENCY: OBTAIN ONE CONCRETE SAMPLE FOR EACH DAY'S POUR OF EACH CONCRETE MIXTURE EXCEEDING 5 CU. YD. BUT LESS THAN 25 CU. YD. PLUS ONE SET FOR EACH ADDITIONAL 50 CU. YD. OR
- FRACTION THEREOF. a. CAST AND LABORATORY CURE TWO SETS OF TWO STANDARD CYLINDER
- b. CAST AND FIELD CURE TWO SETS OF TWO STANDARD CYLINDER
- a. TEST ONE SET OF TWO FIELD-CURED SPECIMENS AT 7 DAYS AND ONE SET OF TWO SPECIMENS AT 28 DAYS.
- b. A COMPRESSIVE-STRENGTH TEST SHALL BE THE AVERAGE COMPRESSIVE STRENGTH FROM A SET OF TWO SPECIMENS OBTAINED FROM SAME COMPOSITE SAMPLE AND TESTED AT AGE INDICATED.
- 10. CONCRETE EXPOSED TO PUBLIC VIEW SHALL MEET THE REQUIREMENTS FOR ARCHITECTURAL CONCRETE OF ACI 301. VI. PRE-ENGINEER TIMBER PAVILION
- A. THE TIMBER PAVILION BUILDING SHALL BE DESIGNED, FABRICATED AND ERECTED IN ACCORDANCE WITH THE LATEST EDITION OF THE "TIMBER CONSTRUCTION MANUAL" AS PUBLISHED BY THE AMERICAN INSTITUTE OF TIMBER CONSTRUCTION.
- B. SHOP DRAWINGS AND CALCULATIONS FOR ALL TIMBER PAVILION

ON THE PLANS AND THE LIVE LOADS SHOWN ABOVE. IT IS THE CONTRACTOR'S RESPONSIBILITY TO DETERMINE THOSE ITEMS NECESSARY TO FACILITATE CONSTRUCTION INCLUDING BUT NOT LIMITED TO FALSEWORK, FORMWORK,

FANY UTILITIES IN THE IMMEDIATE VICINITY OF CONSTRUCTION SO AS TO PREVENT DAMAGE TO THEM. SHOULD ANY DAMAGE AT HIS OWN EXPENSE AND TO THE SATISFACTION OF THE OWNER.

IE ENGINEER WILL NOT PERFORM THE REQUIRED INSPECTION AS A PART OF THEIR DESIGN SERVICES. THE ENGINEER S. SUCH SITE VISITS ARE NOT TO BE CONSTRUED AS MEETING ANY INSPECTION REQUIREMENTS UNLESS THE ENGINEER

TE IN WRITING ANY DEVIATION OR OMISSIONS FROM THE CONTRACT DOCUMENTS. THE GENERAL CONTRACTOR SHALL

N AREA OF THE BUILDING INCLUDE ALL COLUMNS, BASE PLATES, BEAMS AND CONNECTION DETAILS. SHOP DRAWINGS

IENTS MUST BE SUBMITTED BY THE GENERAL CONTRACTOR. IF A CONTRACTOR OR OWNER FAILS TO SUBMIT THE SHOP OR FOR THE DESIGN OF THE PROJECT.


DR 1'-0" BELOW EXISTING GRADE, WHICHEVER IS GREATER, UNLESS NOTED OTHERWISE ON THE DRAWINGS. SEE SITE

2000 PSF PER THE GEOTECHNICAL REPORT BY SCHNABEL ENGINEERING DATED OCTOBER 19, 2022. IT SHALL BE THE R FOR FIELD VERIFICATION OF THE SOIL BEARING PRESSURES. SHOULD THE SOIL BEARING PRESSURE BE FOUND TO BE THIS CASE, THE FOOTINGS WILL EITHER HAVE TO BE LOWERED OR RE-DESIGNED. CONTRACTOR SHALL RECEIVE THE

4. ALL EXCAVATION, BACKFILLING, AND FILLING OPERATIONS BENEATH THE BUILDING SLAB AND FOUNDATIONS, AND ALL COMPACTION TESTS AND INSPECTION, SHALL BE DONE UNDER THE DIRECTION AND SUPERVISION OF A REGISTERED PROFESSIONAL SOILS ENGINEER RETAINED BY THE OWNER. ALL SOIL, EQUIPMENT AND PROCEDURES SHALL BE APPROVED BY THE SOILS ENGINEER PRIOR TO ALL EARTHWORK


	NO.	DESCRIPTION	BY	DATE	
					APPROVED
					CHIEF ENGINEER
					APPROVED
I hereby certify that these documents were prepared or approved by me, and that I am a duly licensed professional engineer under the laws of the State of					
Maryland. License #200461 Expiration Date: 09/02/2024					ASSISTANT CHIEF ENGIN
•				·	•

9. COMPRESSIVE STRENGTH TESTS: ASTM C39/C 39M; TEST ONE SET OF TWO LABORATORY CURED SPECIMENS AT 7 DAYS AND ONE SET OF TWO SPECIMENS AT 28 DAYS.

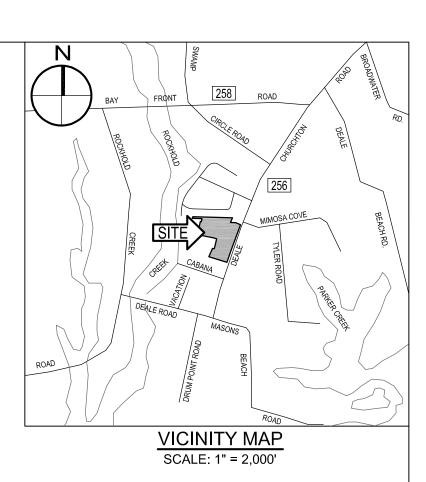



BID SET

DEPARTMENT OF PUBLIC WORKS									
DATE	APPROVED DATE	SCALE: AS SHOWN	DEALE COMMUNITY PARK						
		DRAWN BY: R.S.S.							
	PROJECT MANAGER	CHECKED BY: M.W.S.							
DATE	APPROVED DATE	SHEET NO. 43 OF 47	GENERAL NOTES						
		PROJECT NO.: P582001	GENERAL NUTES						
GINEER	CHIEF, RIGHT-OF-WAY	CONTRACT NO.: P582001							
IGINEER	CHIEF, RIGHT-OF-WAY	CONTRACT NO.: P582001							

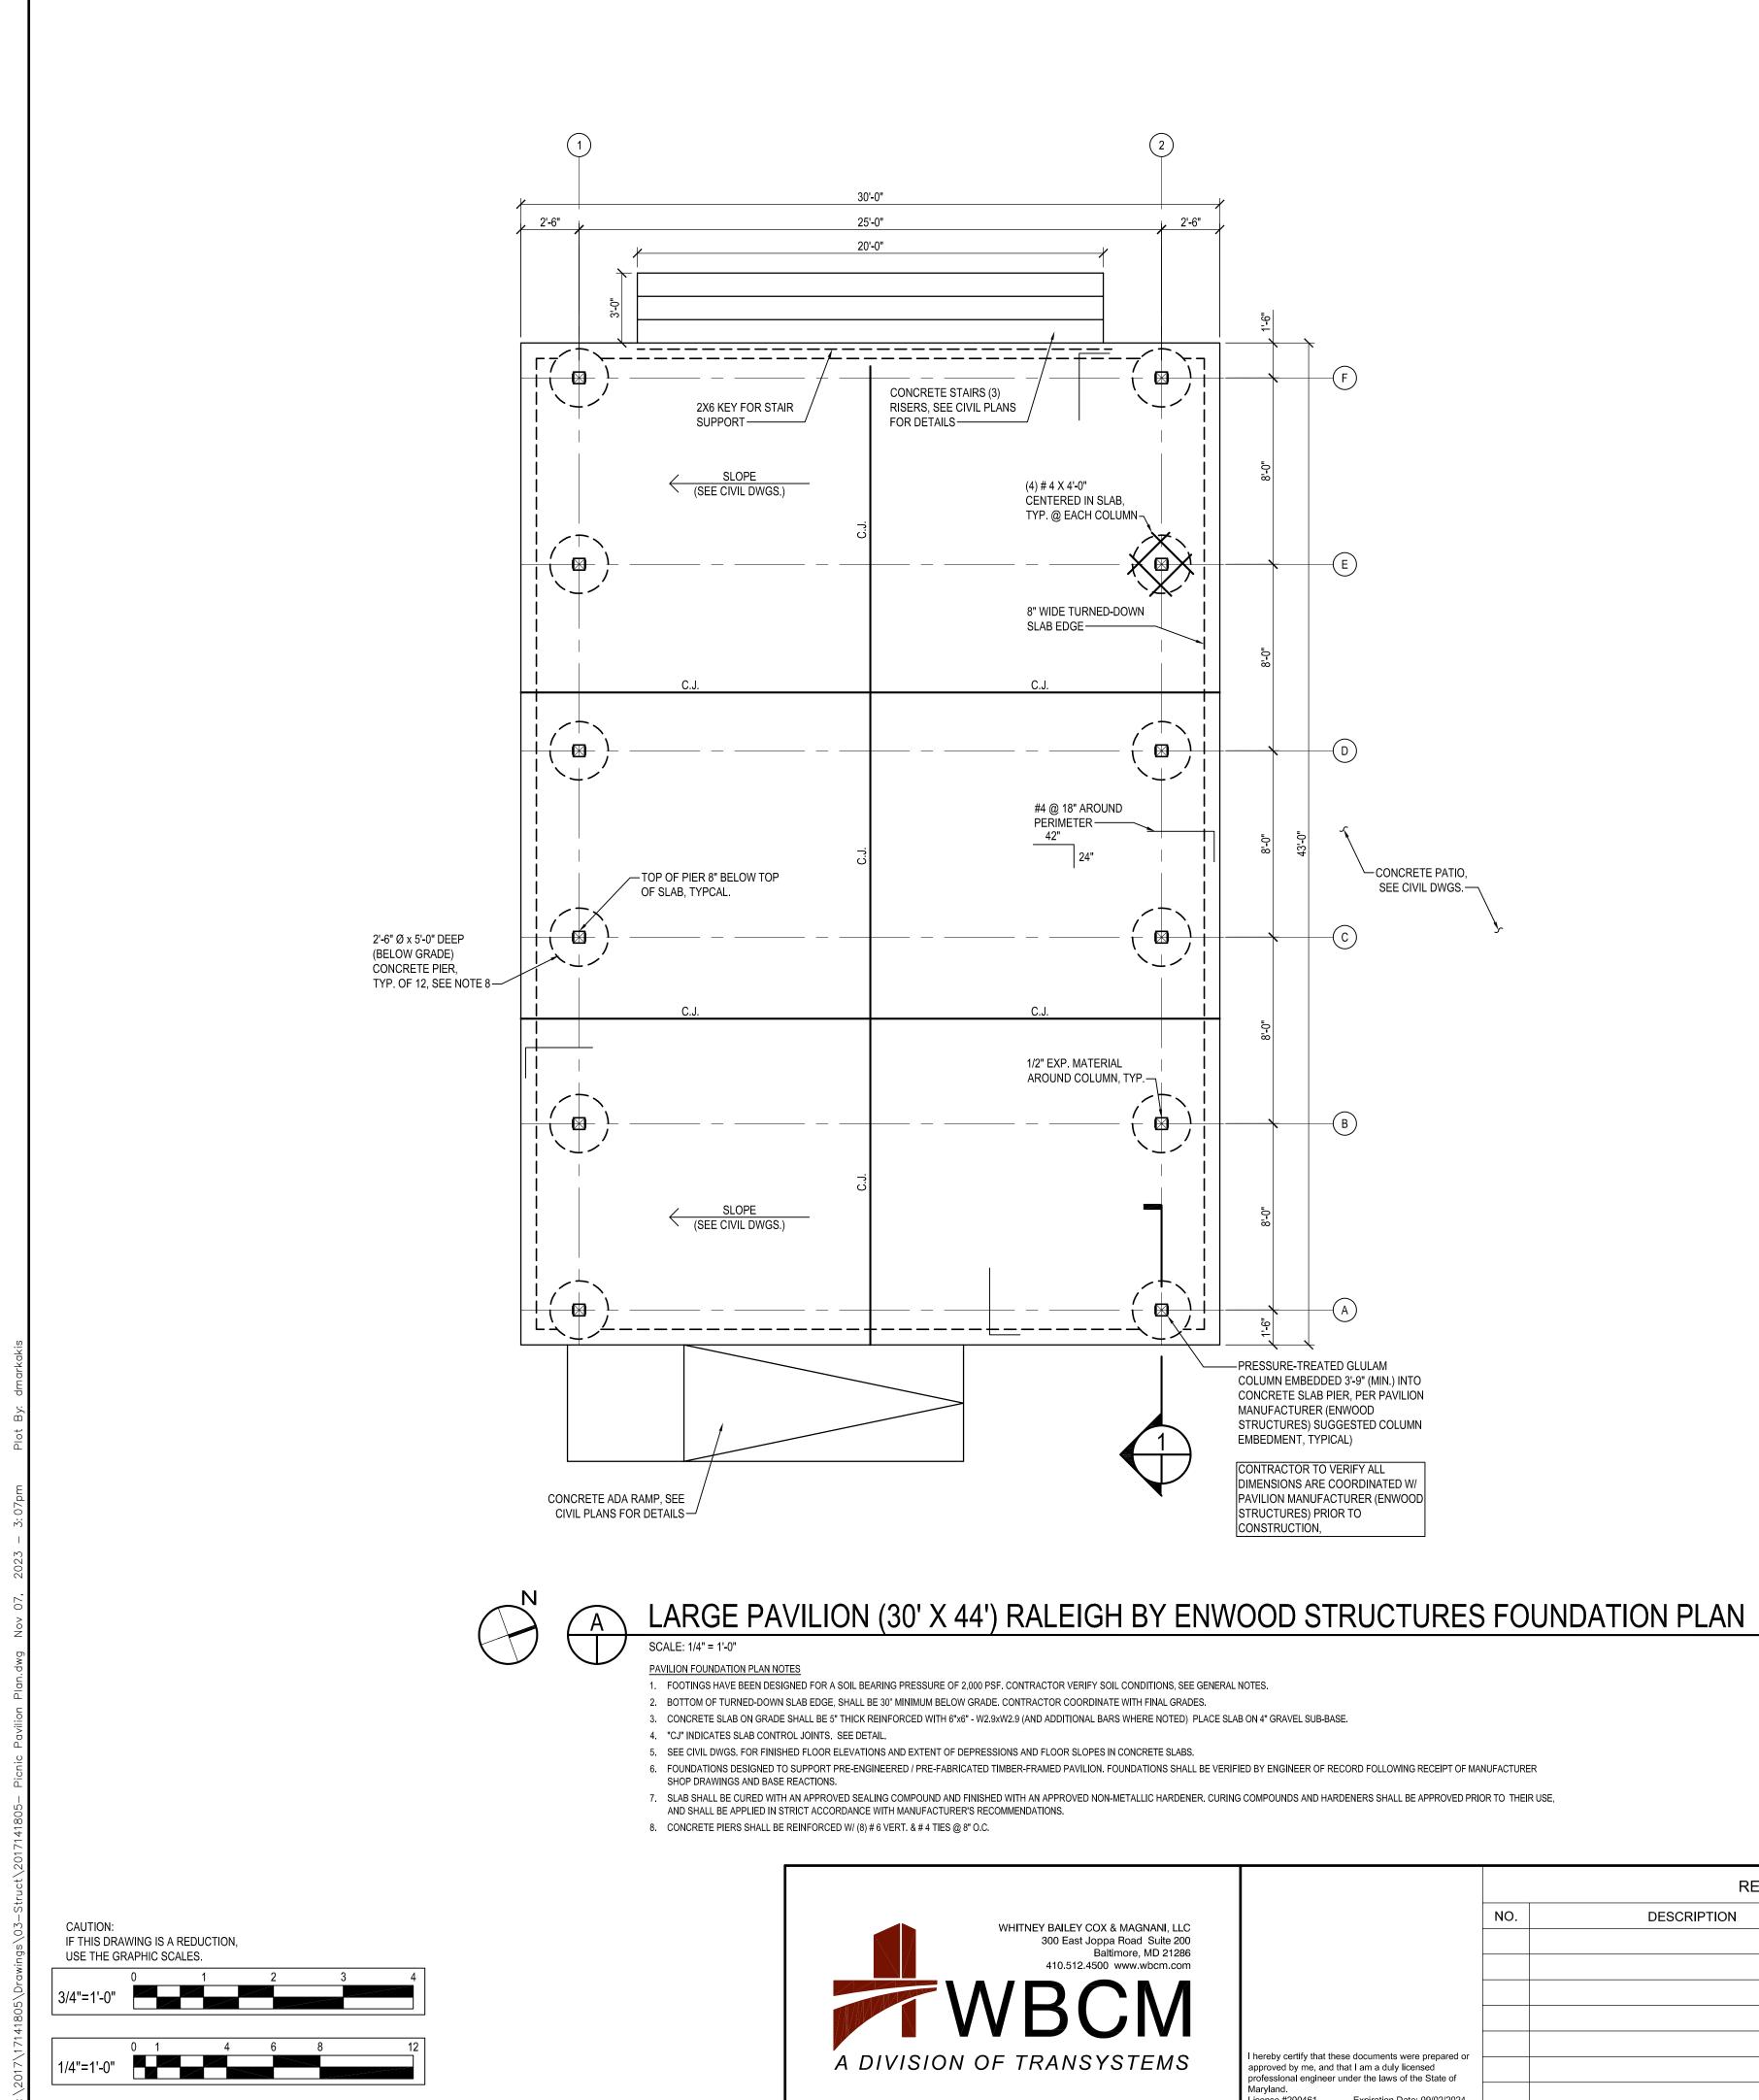

			REVISION	S				ANNE	ARUNDI	EL COUN	ΤY	
AILEY COX & MAGNANI, LLC		NO.	DESCRIPTION	BY	DATE			DEPARTM	ENT OF	PUBLIC V	VORKS	
0 East Joppa Road Suite 200 Baltimore, MD 21286 10.512.4500 www.wbcm.com						APPROVED	DATE	APPROVED	DATE	SCALE: AS SH	OWN	
										DRAWN BY:	R.S.S.	DEALE COMMUNITY PAF
BCM						CHIEF ENGINEER		PROJECT MANAGER		CHECKED BY:	M.W.S.	
						APPROVED	DATE	APPROVED	DATE	SHEET NO. 44	OF 47	PAVILION
NSYSTEMS	I hereby certify that these documents were prepared or approved by me, and that I am a duly licensed professional engineer under the laws of the State of									PROJECT NO .:	P582001	FOUNDATION PLAN
	Maryland. License #200461 Expiration Date: 09/02/2024					ASSISTANT CHIEF ENGINEER		CHIEF, RIGHT-OF-WAY		CONTRACT NO.:	P582001	

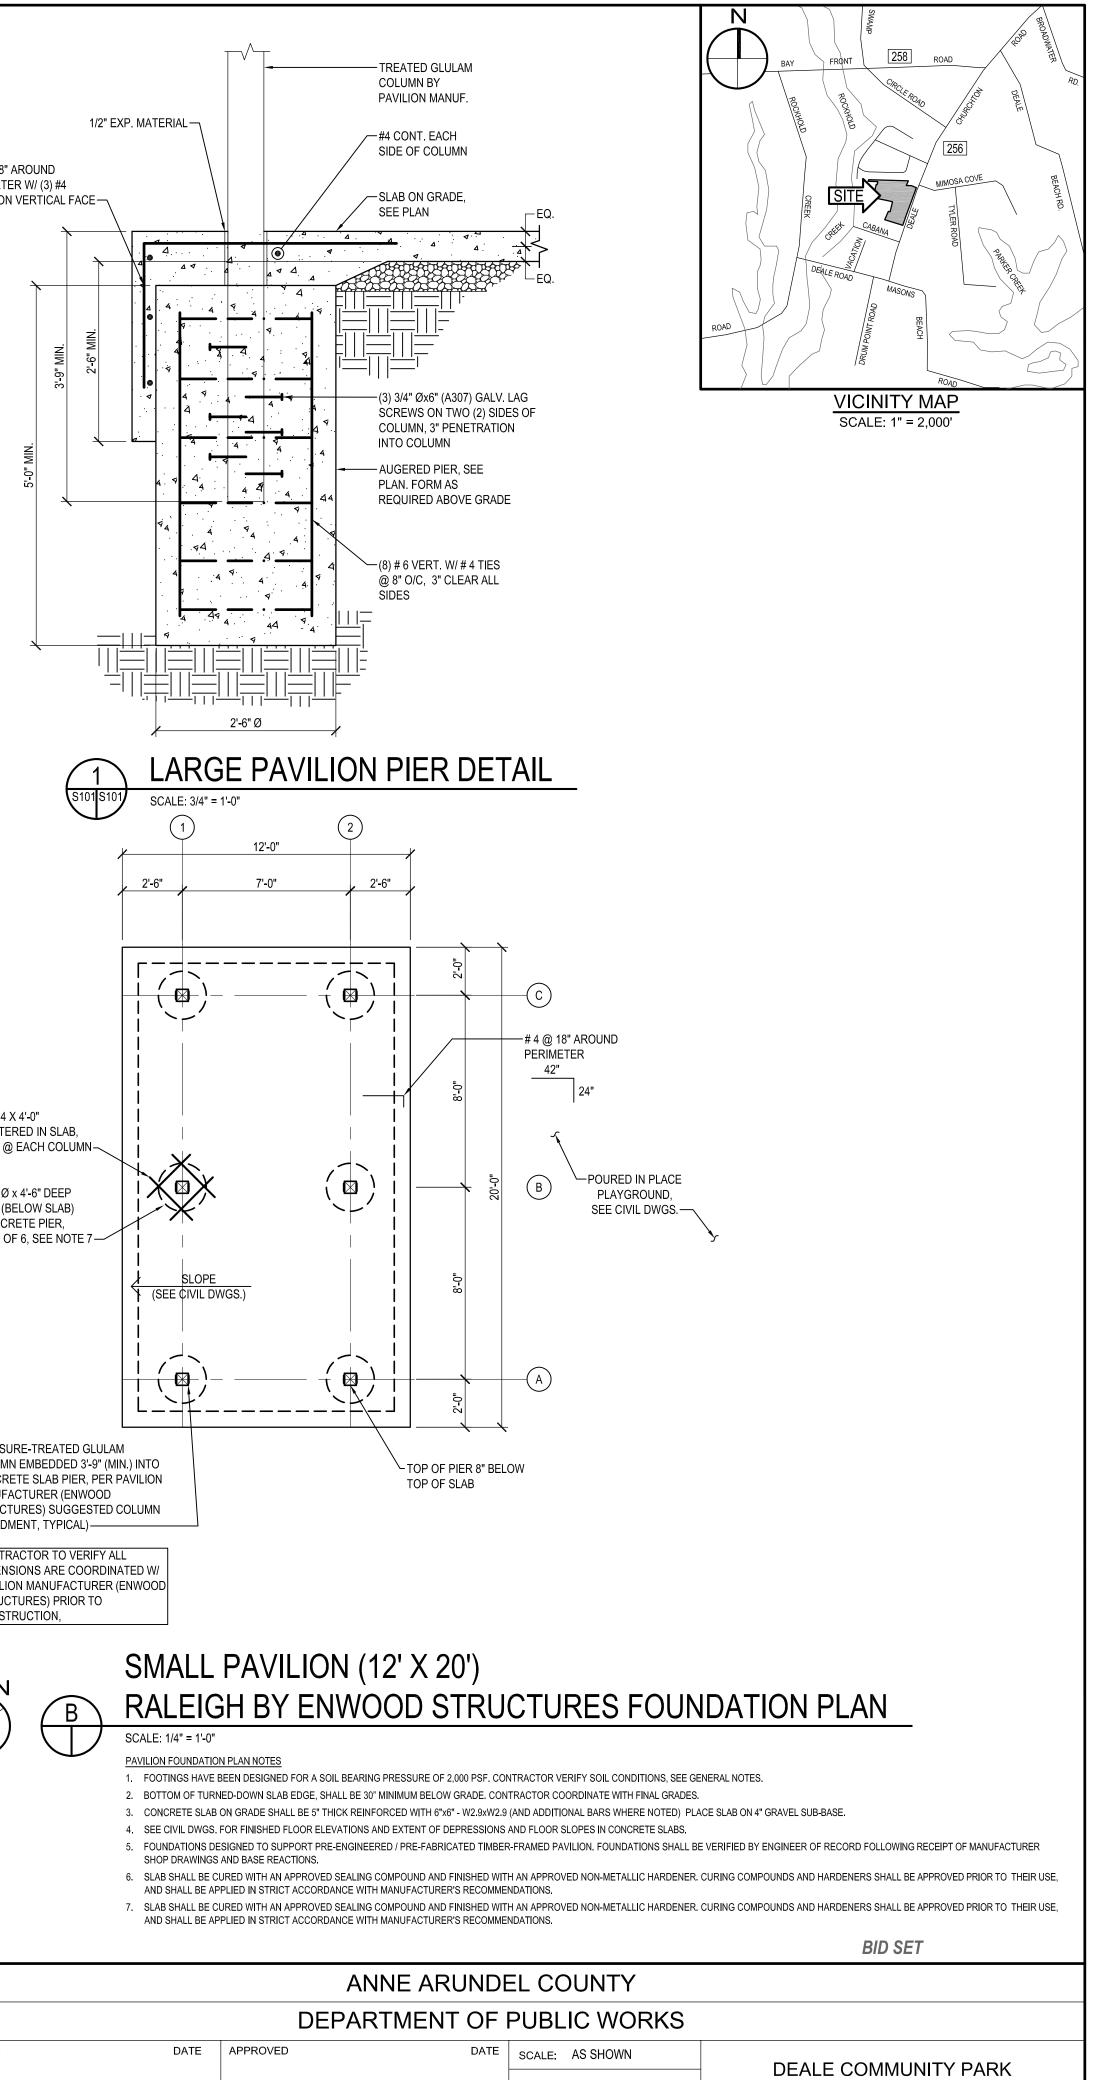

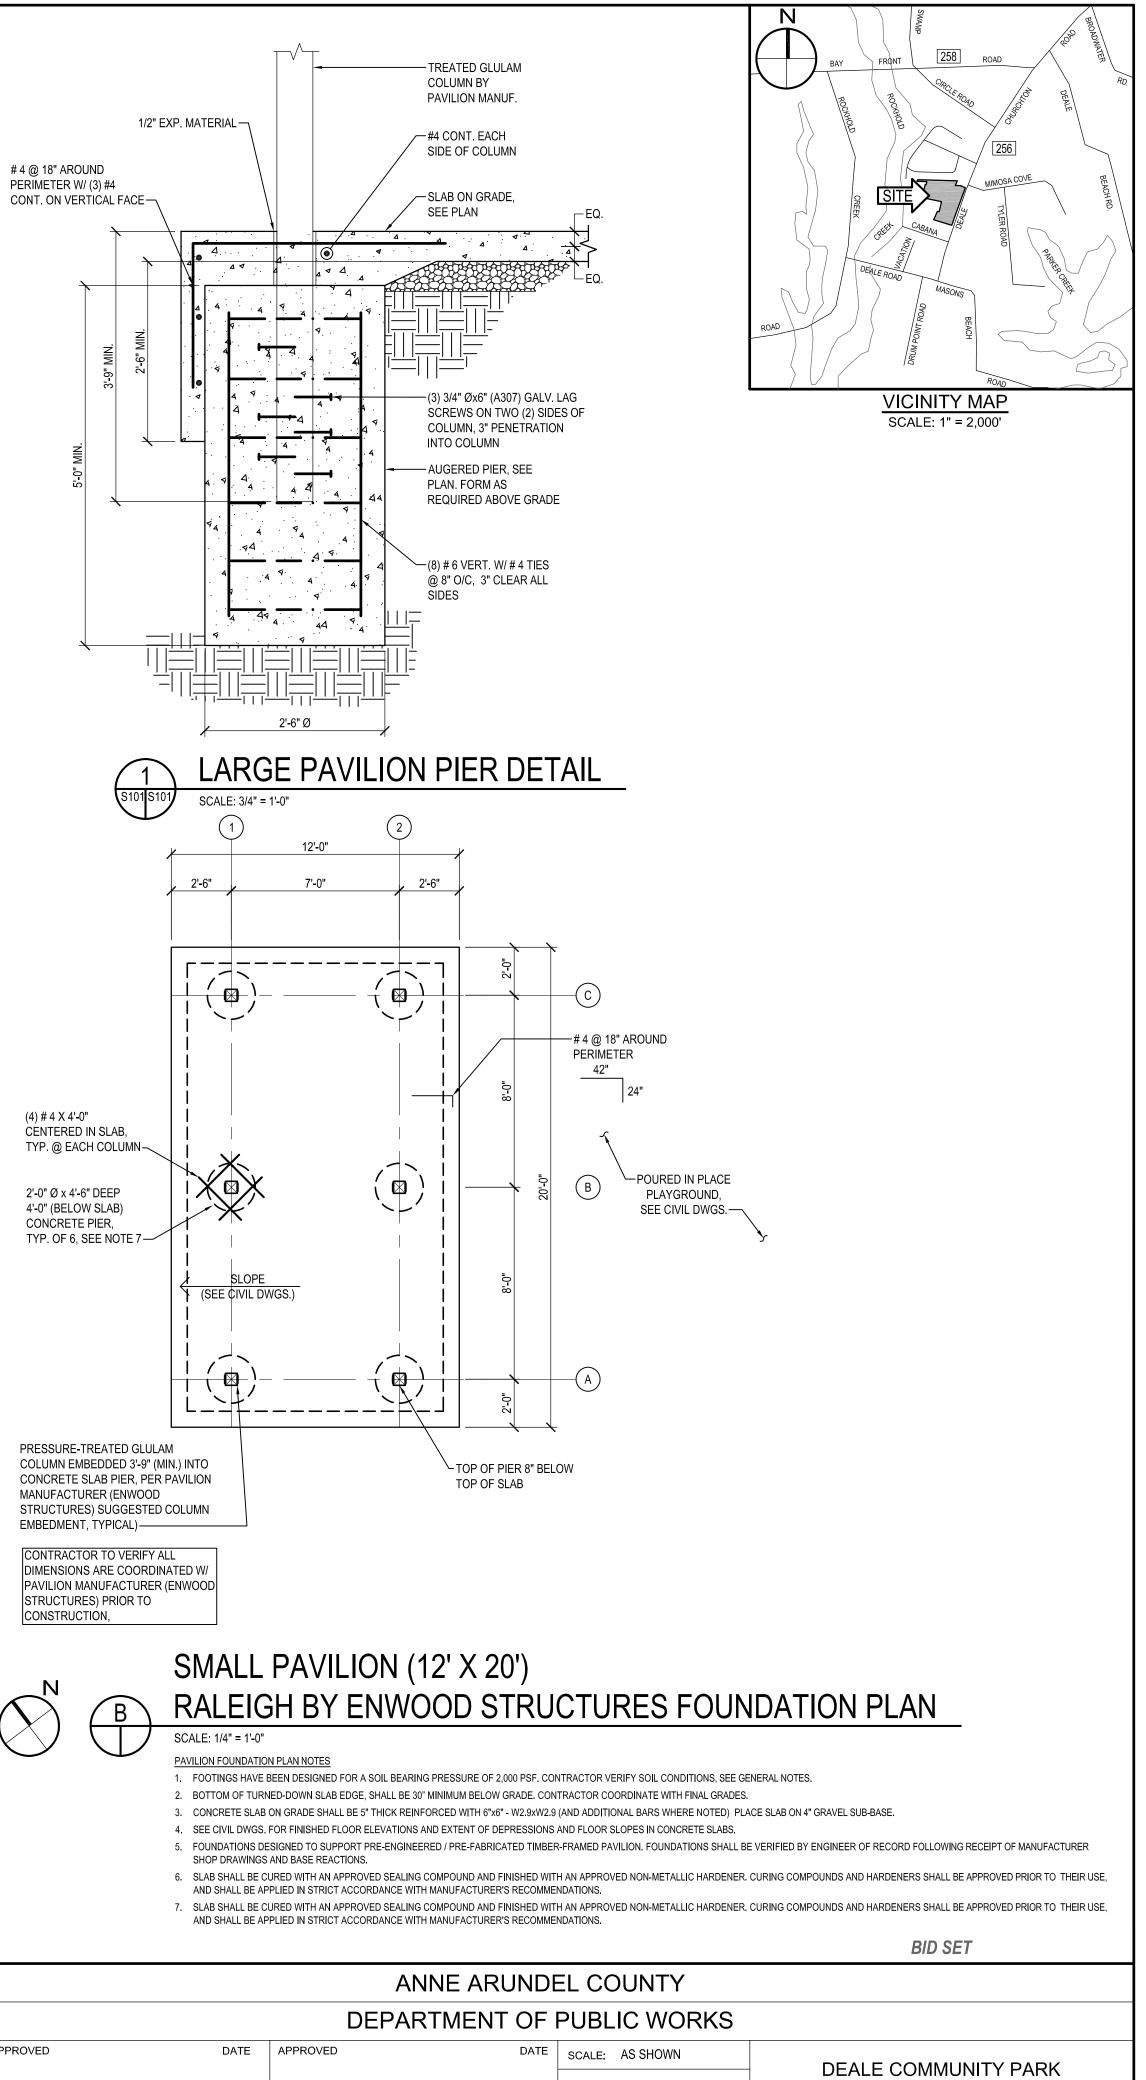

ELECTRICAL LEGEND

SITE

DIRECT BURIED CONDUIT UNDERGROUND CONCRETE ENCASED DUCTBANK - SIZE AS INDICATED ON DWGS. HANDHOLE

POLE MOUNTED SITE LIGHTING FIXTURE, TYPE AS NOTED

SWITCHES

WATERPROOF DIMMER SWITCH WITH 2 HOUR TIMER. MOUNT AT 4'-0" AFF TO TOP.

EXTERIOR PHOTOCELL - WALL MOUNTED 11'-0" AFF

CONTACTOR IN NEMA 3R ENCLOSURE UON. MOUNT 5'-6" AFF TO TOP, UON.

OUTLETS

 Φ

PS

C#

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•— ^{P2}

SURFACE MOUNTED DUPLEX RECEPTACLE; 2P, 3W, 20A, 125V, NEMA 5-20R; GROUND FAULT INTERRUPTING; WEATHERPROOF, WHILE IN USE. MOUNT 24" AFG, UON.

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(1)

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JUNCTION BOX - WALL MOUNTED

PANEL

POWER


TRANSFORMER

MISCELLANEOUS

CONDUIT

HOMERUN TO PANELBOARD; NUMBER OF ARROWHEADS INDICATE NUMBER OF CIRCUITS; REFER TO PANEL SCHEDULES FOR MINIMUM WIRE AND CONDUIT SIZES

MOUNTED WHERE NO CEILING EXISTS CONDUIT OR WIRE ROUTED BELOW GRADE.

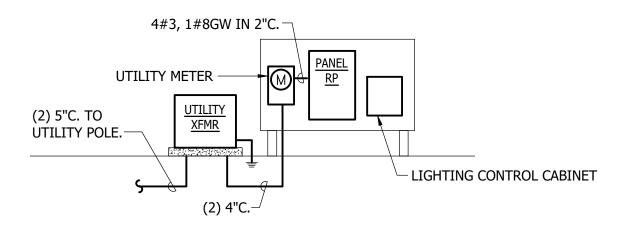

SCHEMATIC POWER RISER DIAGRAM


NOTES: 1. LIGHTING CONTROL CABINET SHALL BE IN LOCKABLE NEMA 3R ENCLOSURE.

REFER TO DETAIL 4/E7.1 FOR LIGHTING CONTROLS FOR PLAZA LIGHTS AND PAVILION LIGHTS. 2. 3. PROVIDE DIMMING SWITCH FOR PAVILION LIGHTS.

TYPE	DESCRIPTION	MANUFACTURER		CATALOG NO.	VOLTS	INPUT WATTS	LAMP	MOUNTING	REMARKS
	LED AREA LUMINAIRE WITH DIE CAST ALUMINUM	RAB	ALED-L-3T-N/480/\	WS2					
P3	HOUSING, INTEGRAL MOTION SENSOR,				240,1PH	80	LED 4000K, 10458 LUMENS	POLE MOUNTED	HI/LOW DIMMABLE
	20-FT SQUARE STRAIGHT ALUMINUM POLE FINISH TO MATCH								
		RAB	ALED-L-4T-N/480/\	NS2					
P4	P4PL - PLAZA LIGHTING FIXTURES NOT REQUIRED TO HAVE SENSO	R			240, 1PH	80	LED 4000K, 10616 LUMENS	POLE MOUNTED	HI/LOW DIMMABLE
	20-FT SQUARE STRAIGHT ALUMINUM POLE FINISH TO MATCH								
	SAME AS TYPE P5, EXCEPT TYPE V DISTRIBUTION.	RAB	ALED-L-5T-N/480/\	NS2					
P5					240, 1PH	80	LED 4000K, 11760 LUMENS	POLE MOUNTED	HI/LOW DIMMABLE
	20-FT SQUARE STRAIGHT ALUMINUM POLE FINISH TO MATCH								
	8' LED ENCLOSED AND GASKETED INDUSTRIAL FIXTURE WITH	LITHONIA		LPPFL-MD-MVOLT-GZ10-40K-					
А	FIBERGLASS HOUSING, NEMA 4X GASKET, POLYMERIC LATCHES,		80CRI-WLF		120	53.4	LED 4000K, 8080 LUMENS	TIGHT TO STRUCTURE	PROVID DIMMING
	POLYCARBONATE LENS, STAINLESS STEEL MOUNTING BRACKETS								SWITCH MOUNTED AT
	AND HARDWARE, ELECTRONIC DIMMABLE DRIVER;								PAVILLION AREA
	COLD WEATHER DRIVER								ONLY TO FUNCTION AT DUS
	NOTES:								
	 ALL LIGHTING FIXTURES SHALL BE DESIGN LIGHTS CONSORTIUM (DLC) QI REFER TO SPECIFICATIONS FOR ADDITIONAL LED AND DRIVER INFORMATION 		· ,						
	3. FIRST NAMED PRODUCT IS BASIS OF DESIGN. PROVIDE PRODUCTS WHI					MODEL NU	IBER OF THE BASIS OF DESIGN F	PRODUCT.	
	 FIRST NAMED PRODUCT IS BASIS OF DESIGN. PROVIDE PRODUCTS WHI FIXTURE SHALL BE PROVIDED WITH INTEGRAL PHOTOCELL AND MOTION 								

W.O.# 21059

Gipe Associates Inc. Consulting Engineers 1220 East Joppa Road, Suite 223 Towson, MD 21286 Baltimore, Maryland Easton, Maryland

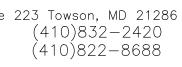



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PANELBOARD - SURFACE, RECESSED MOUNTED, M.H. 6'-6" AFF	
FANELDOARD - JURI ACL, RECEJED MOUNTED, MITLO O ATT	

DENOTES REFERENCE TO DRAWING NOTE

DETAIL REFERENCE: DETAIL NUMBER/DRAWING NUMBER

CONDUIT OR WIRE CONCEALED IN CEILING SPACE, WALL OR SURFACE

ALUMINUM

CONDUIT

DIAMETER

DRAWING

EXISTING

GROUND

KILOWATT

MOUNTED

ASSOCIATION

NUMBER

PHASE

PANEL

TYPICAL

UNDERGROUND VOLT, VOLTS

WEATHERPROOF

TRANSFORMER

WATTS, WIRE, WIRES

UNLESS OTHERWISE NOTED

ON CENTERS

POLE, POLES

NOT IN CONTRACT

POLYVINYL CHLORIDE

TAMPER RESISTANT

RIGID GALVANIZED STEEL REMOVE EXISTING

SURGE PROTECTION DEVICE

TELEPHONE TERMINATION BOARD

LOW

GROUND WIRE

HORSEPOWER

ISOLATED GROUND

KILOVOLT-AMPERES

EMERGENCY

AFG

AHJ

ATS

AWG

BGE

BF

CB

DIA

DWG

ECB

EPO

ETR

ΕX

FLA

GFI

GW

HP

IG

IMC

KCMIL

KVA

KW

MCA

MCB

MLO

MOCP

MTD

MH

NEC

NEMA

NF/SS

NIC

NO

OC

PNL

PVC

RGS

RX SPD

TR

ТТВ

TYP

UG

WP

W

XFMR

UON

AL

AMPERE, AMPERES

ABOVE FINISHED GRADE

AMERICAN WIRE GAUGE

BALTIMORE GAS & ELECTRIC

ENCLOSED CIRCUIT BREAKER

GROUND FAULT INTERRUPTING

INTERMEDIATE METAL CONDUIT

THOUSAND CIRCULAR MILS

MINIMUM CIRCUIT AMPERES

MOUNTING HEIGHT/MANHOLE

NATIONAL ELECTRICAL CODE

NONFUSED SAFETY SWITCH

MAXIMUM OVERCURRENT PROTECTION

NATIONAL ELECTRICAL MANUFACTURER'S

MAIN CIRCUIT BREAKER

MAIN LUGS ONLY

EMERGENCY POWER OFF

EXISTING TO REMAIN

FULL LOAD AMPERES

BALLAST FACTOR

CIRCUIT BREAKER

AUTHORITY HAVING JURISDICTION

AUTOMATIC TRANSFER SWITCH

GENERAL NOTES:

1.	THE ELECTRICAL CONTRACT
	PROJECT. ELECTRICAL OR S
	STRUCTURAL, KITCHEN AND
	PART OF THIS CONTRACT AN
	OWNER.

- TO ROUGH-IN OF SERVICE EQUIPMENT AND WIRING.
- DRAWINGS.

120 VOL	.T	277 VOL	MINIMUM		
WIRING LENGTH	WIRE SIZE	WIRING LENGTH	WIRE SIZE	CONDUIT SIZE	
0' - 60' #12		0' - 130'	#12	3/4"	
60' - 100'	#10	130' - 210'	#10	3/4"	
100' - 150' #8 150' - 240' #6		210' - 340'	#8	3/4"	
		340' - 540'	#6	3/4"	
OVER 240'	#4	OVER 540'	#4	1"	

WIRING AND CONDUIT SIZES INDICATED IN PANEL SCHEDULES ARE MINIMUM ONLY. CONTRACTOR SHALL BE RESPONSIBLE FOR DETERMINING EXACT WIRING AND CONDUIT SIZES. CONTRACTOR SHALL PROVIDE SPLICE BLOCKS AND REDUCING PINS AS REQUIRED TO TERMINATE WIRING AND MAKE FINAL CONNECTIONS.

WARRANTY

						-
	OF MARLE		REVISIONS			
EY COX & MAGNANI, LLC	VIC THE SCIENCE	NO.	DESCRIPTION	BY	DATE	
ast Joppa Road Suite 200 Baltimore, MD 21286 512.4500 www.wbcm.com	Ene Meschel					APPROVED
	2					
	SSIONAL E					CHIEF ENGINEER
						APPROVED
or Tomorrow [®]	I hereby certify that these documents were prepared or approved by me, and that I am a duly licensed professional engineer under the laws of the State of					
	Maryland. License #44837 Expiration Date: 12/22/2023					ASSISTANT CHIEF ENGINEER

TOR SHALL FAMILIARIZE HIMSELF WITH THE DRAWINGS OF ALL OTHER TRADES ON THE SYSTEMS CONNECTIONS INDICATED ON ARCHITECTURAL, MECHANICAL, CIVIL, ID ALL OTHER DRAWINGS WHICH ARE PART OF THIS PROJECT, SHALL BE CONSIDERED A AND SHALL BE PROVIDED BY THE ELECTRICAL CONTRACTOR AT NO EXTRA COST TO THE

2. THE ELECTRICAL DRAWINGS ARE DIAGRAMMATIC IN NATURE AND AS SUCH SHALL NOT BE SCALED. REFER TO THE ARCHITECTURAL DRAWINGS FOR EXACT LOCATIONS OF DEVICES AND EQUIPMENT AND DIMENSIONAL INFORMATION PRIOR TO ROUGH-IN. COORDINATE LOCATIONS OF MECHANICAL EQUIPMENT WITH MECHANICAL CONTRACTOR PRIOR

3. COORDINATE MOUNTING HEIGHTS OF ALL DEVICES WITH ARCHITECTURAL PLANS, SECTIONS, ELEVATIONS AND CASEWORK

4. THE CONTRACTOR SHALL BE RESPONSIBLE FOR DETERMINING THE EXACT ROUTING OF WIRING AND CONDUITS AND SHALL BE RESPONSIBLE FOR SIZING ALL BRANCH CIRCUIT WIRING TO LIMIT VOLTAGE DROP TO 3%%%. CONTRACTOR SHALL SIZE CONDUIT TO ACCOMMODATE WIRING PER NEC. 20 AMPERE CIRCUITS SHALL BE SIZED AS FOLLOWS:


DIMMED LIGHTING CIRCUITS SHALL HAVE DEDICATED NEUTRAL CONDUCTORS.


5. ALL WIRING IS TO BE ALUMINUM WIRING; ALL BOXES SHALL BE BURIED; THE INSPECTION PLATE SHOULD BE WELDED; 10-YEAR


BUS		60													
		00	A MO	СВ				100% RAT	ED NE	UTRAL	BUS			25,0	00 A.I.C
	BR	EAKER		CIRCL	JIT WIR	ING			BR	EAKER		CIRCL	JIT WIRI	NG	CONN
DESCRIPTION	Р	AMPS	NO	SIZE	GND	С	СКТ	DESCRIPTION	Р	AMPS	NO	SIZE	GND	С	KVA
PAVILLION LTG	1	20	2	8	10	2	2	PARKING LOT DRIVE	2	20	3	6	10	2	0.4
PAVILLION REC	1	20	2	8	10	2	4								0.4
CONTROLS	1	20	2	12	12	1	6	PARKING LOT SOUTH	2	20	3	6	10	2	0.4
SPARE	1	20					8								0.4
SPARE	1	20					10	PARKING LOT NORTH	2	20	3	6	10	2	0.6
SPARE	1	20					12								0.6
SPACE	1						14	SPACE	1						
SPACE	1						16	SPACE	1						
SPACE	1						18	SPACE	1						
SPACE	1						20	SPACE	1						1
	PAVILLION LTG PAVILLION REC CONTROLS SPARE SPARE SPARE SPACE SPACE SPACE	PAVILLION LTG1PAVILLION REC1CONTROLS1SPARE1SPARE1SPARE1SPACE1SPACE1SPACE1SPACE1SPACE1	PAVILLION LTG120PAVILLION REC120CONTROLS120SPARE120SPARE120SPARE120SPARE120SPARE120SPARE120SPARE120SPACE120SPACE120SPACE120	PAVILLION LTG 1 20 2 PAVILLION REC 1 20 2 CONTROLS 1 20 2 SPARE 1 20 2 SPACE 1 20 2 SPACE 1 20 2 SPACE 1 20 2	PAVILLION LTG 1 20 2 8 PAVILLION REC 1 20 2 8 CONTROLS 1 20 2 12 SPARE 1 20 2 2 SPACE 1 20 2 2 SPACE 1 20 2 2 SPACE 1 20 2 2	PAVILLION LTG 1 20 2 8 10 PAVILLION REC 1 20 2 8 10 CONTROLS 1 20 2 12 12 SPARE 1 20 2 2 12 12 SPARE 1 20 2 2 2 12 12 SPACE 1 20 2 2 2 2 12 12 SPACE 1 20 2 2 2 2 2 12 12 SPACE 1 <t< td=""><td>PAVILLION LTG 1 20 2 8 10 2 PAVILLION REC 1 20 2 8 10 2 CONTROLS 1 20 2 12 12 1 SPARE 1 20 2 2 12 1 SPARE 1 20 2 2 2 1 2 2 SPARE 1 20 2 2 2 2 2 2 2 2 1 2 1 2 2 3 2 3 3 3 3 3 3 3 3 3 3 3 3 3<</td><td>PAVILLION LTG 1 20 2 8 10 2 2 PAVILLION REC 1 20 2 8 10 2 4 CONTROLS 1 20 2 12 12 1 6 SPARE 1 20 2 12 12 1 6 SPARE 1 20 2 12 12 1 6 SPARE 1 20 2 12 12 1 10 SPARE 1 20 2 2 12 12 12 SPARE 1 20 2 2 12 12 12 12 SPARE 1 20 2 2 2 12 12 12 12 12 12 14 12 14 14 14 14 14 16 18 18 20 20 20 20 20 20 20 20 20 20 20 20 20 20 20 20 <t< td=""><td>PAVILLION LTG 1 20 2 8 10 2 2 PARKING LOT DRIVE PAVILLION REC 1 20 2 8 10 2 4 CONTROLS 1 20 2 12 12 1 6 PARKING LOT DRIVE SPARE 1 20 2 12 12 1 6 PARKING LOT SOUTH SPARE 1 20 2 12 12 1 8 SPARE 1 20 - - 10 PARKING LOT NORTH SPARE 1 20 - - 12 SPARE 1 20 - 14 SPACE SPARE 1 20 - 14 SPACE SPACE 1 - - 14 SPACE SPACE 1 - - 18 SPACE SPACE 1 - - 20 SPACE</td><td>PAVILLION LTG 1 20 2 8 10 2 2 PARKING LOT DRIVE 2 PAVILLION REC 1 20 2 8 10 2 4 </td><td>PAVILLION LTG 1 20 2 8 10 2 2 PARKING LOT DRIVE 2 20 PAVILLION REC 1 20 2 8 10 2 4 </td><td>PAVILLION LTG 1 20 2 8 10 2 2 PAKING LOT DRIVE 2 20 3 PAVILLION REC 1 20 2 8 10 2 4 </td><td>PAVILLION LTG 1 20 2 8 10 2 2 PARKING LOT DRIVE 2 20 3 6 PAVILLION REC 1 20 2 8 10 2 4 -</td><td>PAVILLION LTG 1 20 2 8 10 2 2 PARKING LOT DRIVE 2 20 3 6 10 PAVILLION REC 1 20 2 8 10 2 4 -</td><td>PAVILLION LTG 1 20 2 8 10 2 2 PARKING LOT DRIVE 2 20 3 6 10 2 PAVILLION REC 1 20 2 8 10 2 4 -</td></t<></td></t<>	PAVILLION LTG 1 20 2 8 10 2 PAVILLION REC 1 20 2 8 10 2 CONTROLS 1 20 2 12 12 1 SPARE 1 20 2 2 12 1 SPARE 1 20 2 2 2 1 2 2 SPARE 1 20 2 2 2 2 2 2 2 2 1 2 1 2 2 3 2 3 3 3 3 3 3 3 3 3 3 3 3 3<	PAVILLION LTG 1 20 2 8 10 2 2 PAVILLION REC 1 20 2 8 10 2 4 CONTROLS 1 20 2 12 12 1 6 SPARE 1 20 2 12 12 1 6 SPARE 1 20 2 12 12 1 6 SPARE 1 20 2 12 12 1 10 SPARE 1 20 2 2 12 12 12 SPARE 1 20 2 2 12 12 12 12 SPARE 1 20 2 2 2 12 12 12 12 12 12 14 12 14 14 14 14 14 16 18 18 20 20 20 20 20 20 20 20 20 20 20 20 20 20 20 20 <t< td=""><td>PAVILLION LTG 1 20 2 8 10 2 2 PARKING LOT DRIVE PAVILLION REC 1 20 2 8 10 2 4 CONTROLS 1 20 2 12 12 1 6 PARKING LOT DRIVE SPARE 1 20 2 12 12 1 6 PARKING LOT SOUTH SPARE 1 20 2 12 12 1 8 SPARE 1 20 - - 10 PARKING LOT NORTH SPARE 1 20 - - 12 SPARE 1 20 - 14 SPACE SPARE 1 20 - 14 SPACE SPACE 1 - - 14 SPACE SPACE 1 - - 18 SPACE SPACE 1 - - 20 SPACE</td><td>PAVILLION LTG 1 20 2 8 10 2 2 PARKING LOT DRIVE 2 PAVILLION REC 1 20 2 8 10 2 4 </td><td>PAVILLION LTG 1 20 2 8 10 2 2 PARKING LOT DRIVE 2 20 PAVILLION REC 1 20 2 8 10 2 4 </td><td>PAVILLION LTG 1 20 2 8 10 2 2 PAKING LOT DRIVE 2 20 3 PAVILLION REC 1 20 2 8 10 2 4 </td><td>PAVILLION LTG 1 20 2 8 10 2 2 PARKING LOT DRIVE 2 20 3 6 PAVILLION REC 1 20 2 8 10 2 4 -</td><td>PAVILLION LTG 1 20 2 8 10 2 2 PARKING LOT DRIVE 2 20 3 6 10 PAVILLION REC 1 20 2 8 10 2 4 -</td><td>PAVILLION LTG 1 20 2 8 10 2 2 PARKING LOT DRIVE 2 20 3 6 10 2 PAVILLION REC 1 20 2 8 10 2 4 -</td></t<>	PAVILLION LTG 1 20 2 8 10 2 2 PARKING LOT DRIVE PAVILLION REC 1 20 2 8 10 2 4 CONTROLS 1 20 2 12 12 1 6 PARKING LOT DRIVE SPARE 1 20 2 12 12 1 6 PARKING LOT SOUTH SPARE 1 20 2 12 12 1 8 SPARE 1 20 - - 10 PARKING LOT NORTH SPARE 1 20 - - 12 SPARE 1 20 - 14 SPACE SPARE 1 20 - 14 SPACE SPACE 1 - - 14 SPACE SPACE 1 - - 18 SPACE SPACE 1 - - 20 SPACE	PAVILLION LTG 1 20 2 8 10 2 2 PARKING LOT DRIVE 2 PAVILLION REC 1 20 2 8 10 2 4	PAVILLION LTG 1 20 2 8 10 2 2 PARKING LOT DRIVE 2 20 PAVILLION REC 1 20 2 8 10 2 4	PAVILLION LTG 1 20 2 8 10 2 2 PAKING LOT DRIVE 2 20 3 PAVILLION REC 1 20 2 8 10 2 4	PAVILLION LTG 1 20 2 8 10 2 2 PARKING LOT DRIVE 2 20 3 6 PAVILLION REC 1 20 2 8 10 2 4 -	PAVILLION LTG 1 20 2 8 10 2 2 PARKING LOT DRIVE 2 20 3 6 10 PAVILLION REC 1 20 2 8 10 2 4 -	PAVILLION LTG 1 20 2 8 10 2 2 PARKING LOT DRIVE 2 20 3 6 10 2 PAVILLION REC 1 20 2 8 10 2 4 -

BID DOCUMENTS11/08/2023

ANNE ARUNDEL COUNTY								
DEPARTMENT OF PUBLIC WORKS								
DATE	APPROVED DATE	SCALE: NONE	DEALE COMMUNITY PARK					
		DRAWN BY: J.L.P.						
	PROJECT MANAGER	CHECKED BY: E.M.P.						
DATE	APPROVED DATE	SHEET NO. 45 OF 47	ELECTRICAL LEGEND					
		PROJECT NO.: P582001						
2	CHIEF, RIGHT-OF-WAY	CONTRACT NO.: P582001						

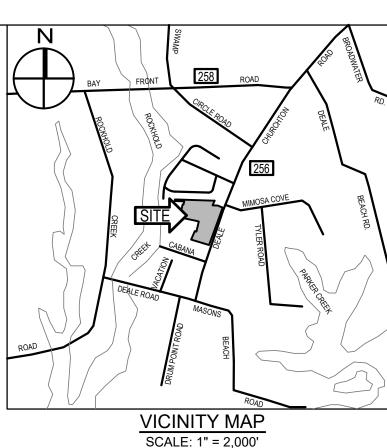

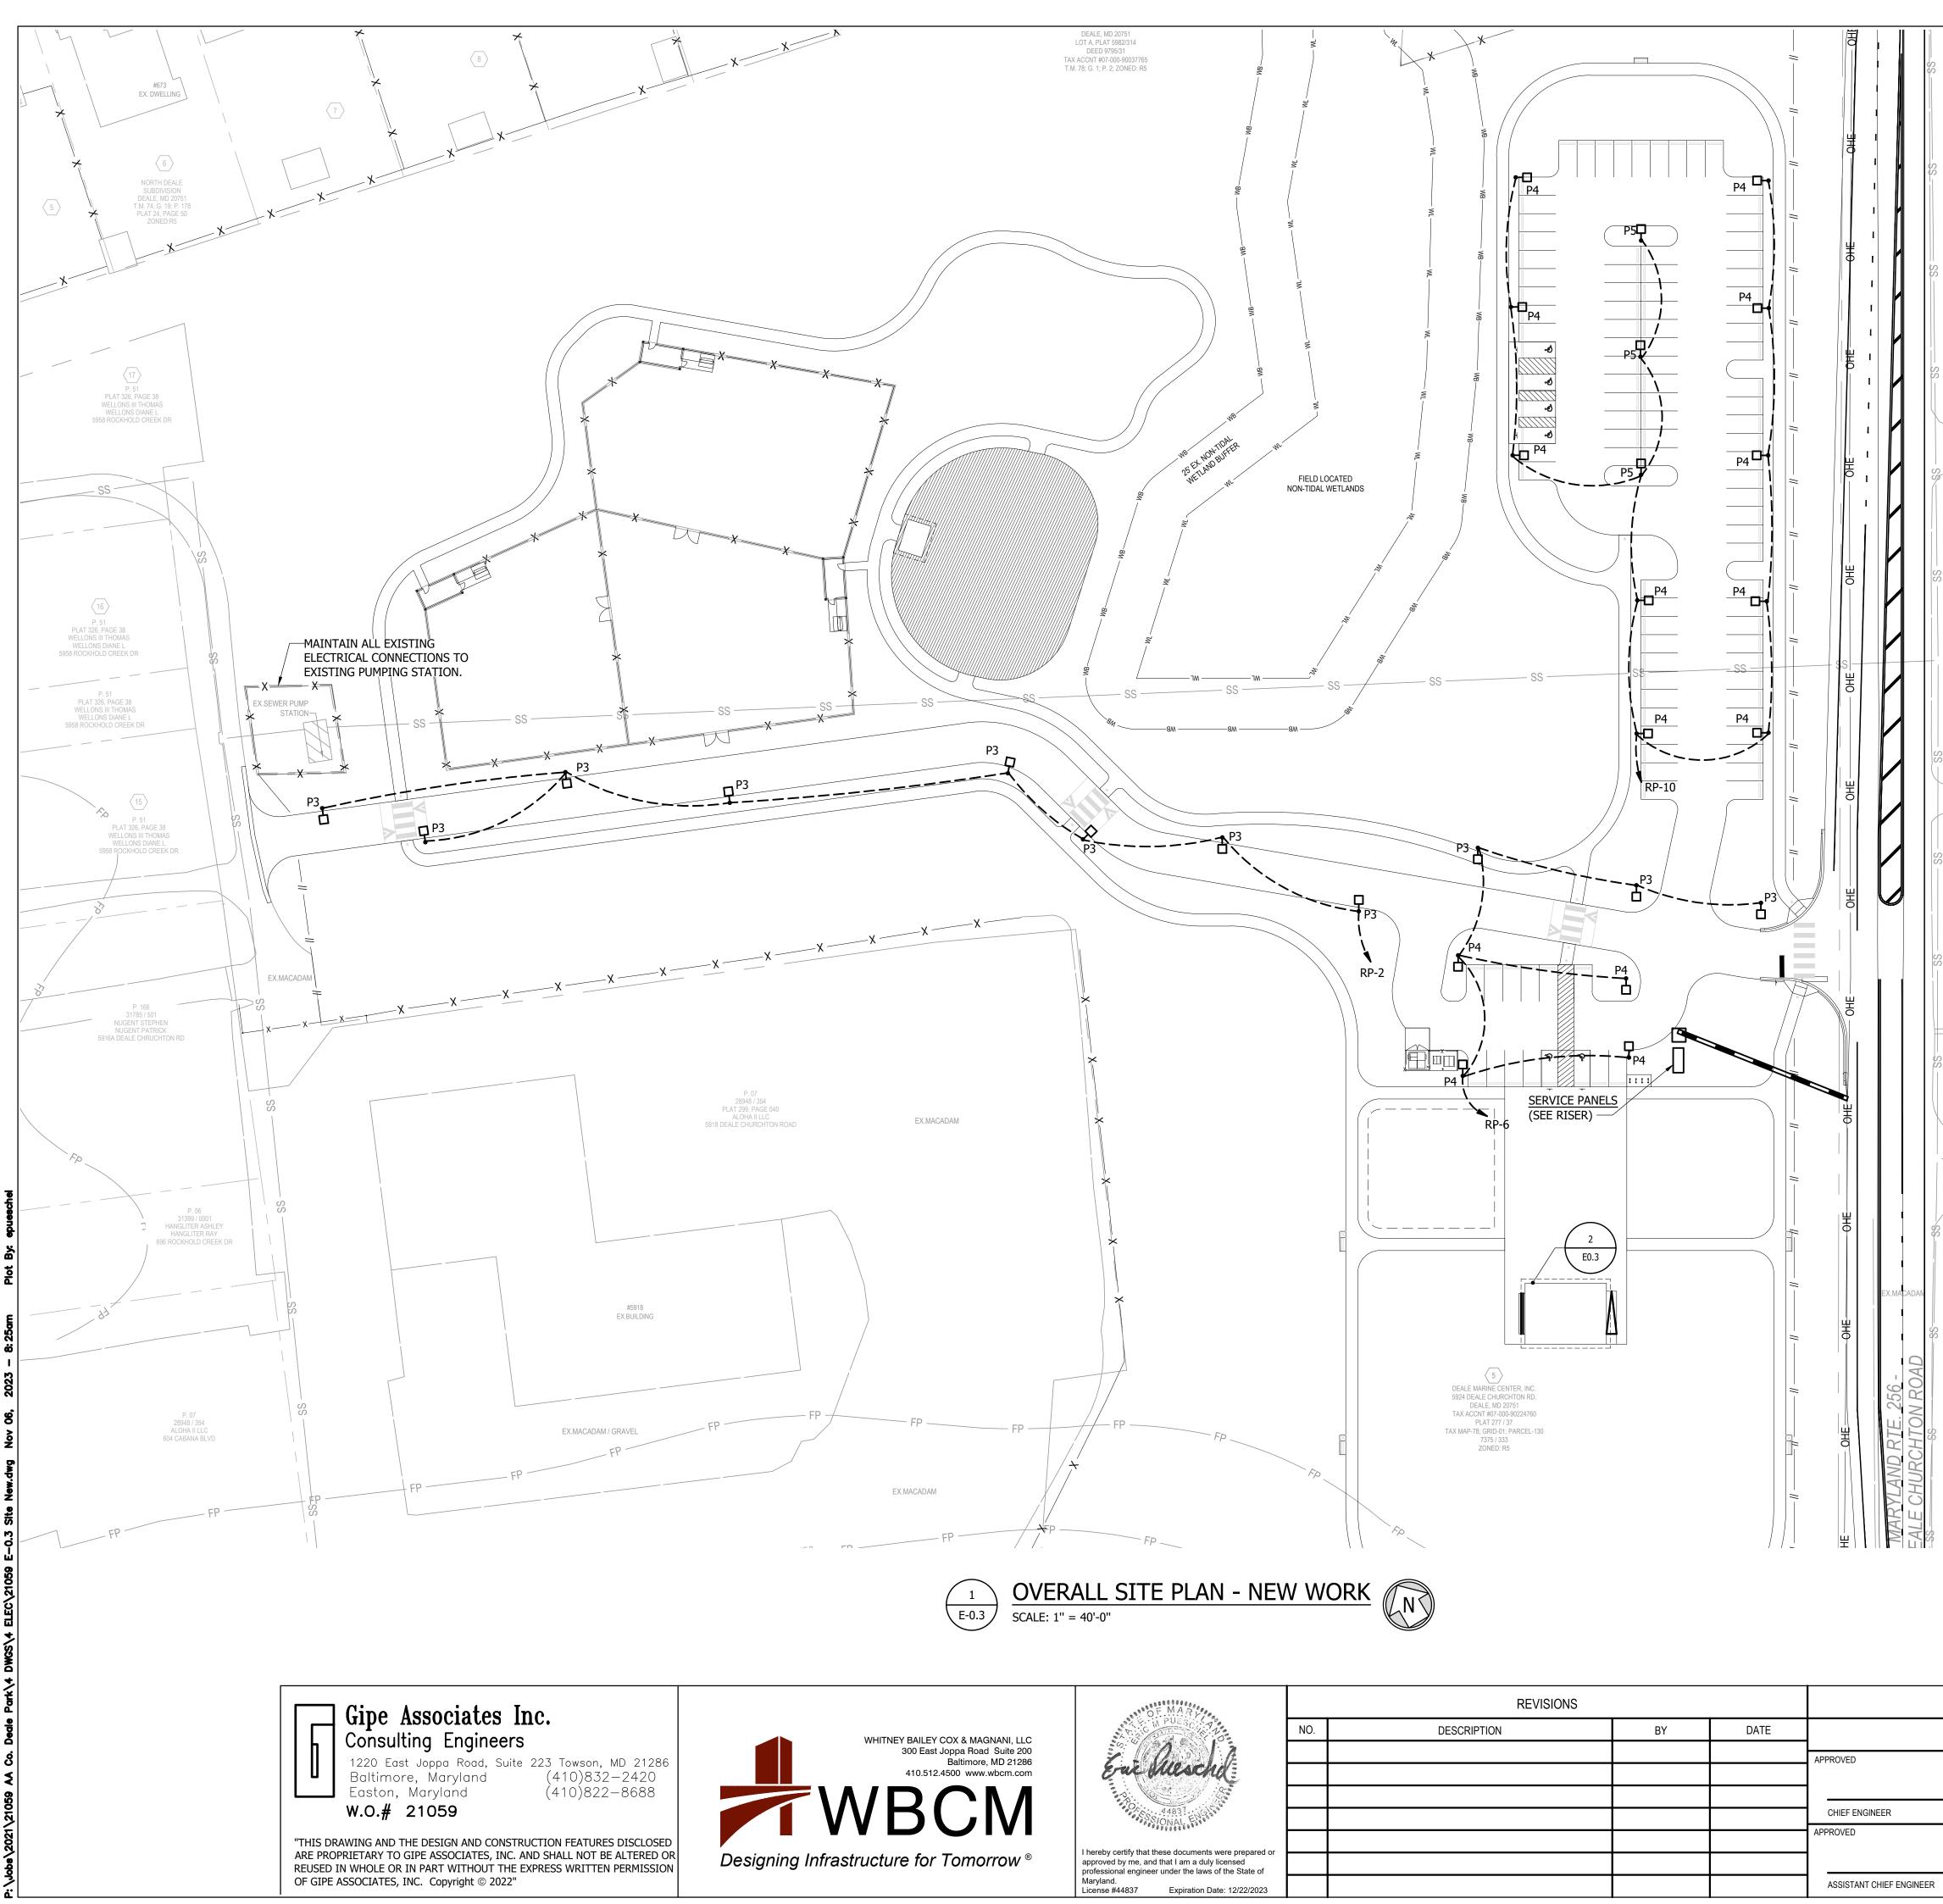

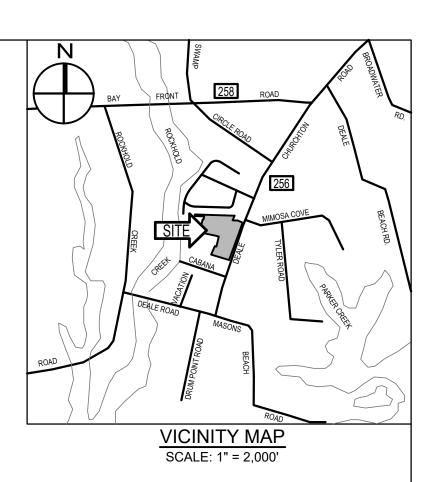

GENERAL NOTES:

- 1. THE PROPOSED PATHWAYS ARE DIAGRAMMATIC IN NATURE. STORMWATER MANAGEMENT PONDS, PERVIOUS PAVING, AND SIDEWALKS SHALL NOT BE DISTURBED WITHOUT ENGINEER OR OWNER APPROVAL.
- 2. SUBMIT A PROPOSED ROUTING PLAN TO OWNER AND ENGINEER FOR REVIEW. INCLUDE PROPOSED METHOD OF EXCAVATION/DRILLING/ETC WITH ROUTING PLAN.
- 3. CONDUITS SHALL BE 1" PVC CONDUIT (MINIMUM).


CH-FIRST BAPTIST PO BOX 117 DEALE MD 20751 5907 DEALE CHRUCHTOM


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C

P. 261 30476 / 472 ANNE ARUNDEL MEDI CENTER FOUNDATION 2000 MEDICAL PKW BELCHER PAV STE 6 5935 DEALE CHURCHTON

- 4. COORDINATE INSTALLATION OF ELECTRICAL WORK WITH EXISTING AND FINAL GRADE.
- 5. OBTAIN ALL PERMITS, UTILITY APPROVALS, ETC, FOR WORK, AS REQUIRED.
- 6. ALL ELECTRICAL WORK SHALL REMAIN, UNLESS OTHERWISE NOTED.
- 7. UTILITY FEEDS TO OTHER PARTS OF THE SITE SHALL BE SUITABLY PROTECTED AGAINST DAMAGE.
- 8. CONTRACTOR TO HIRE PRIVATE UTILITY MARKER TO TRACE ALL EXISTING UNDERGROUND ELECTRICAL WORK. MAINTAIN ALL EXISTING CIRCUITS THROUGH CONSTRUCTION.
- 9. CONCRETE ENCASE DIRECT BURIED CONDUITS ROUTED BENEATH PAVED SURFACES. PRIMARY DUCTBANK MAY BE DIRECTIONALLY DRILLED UNDER GRASS SURFACES.
- 10. REFER TO CIVIL PLANS FOR PHASING REQUIREMENTS.



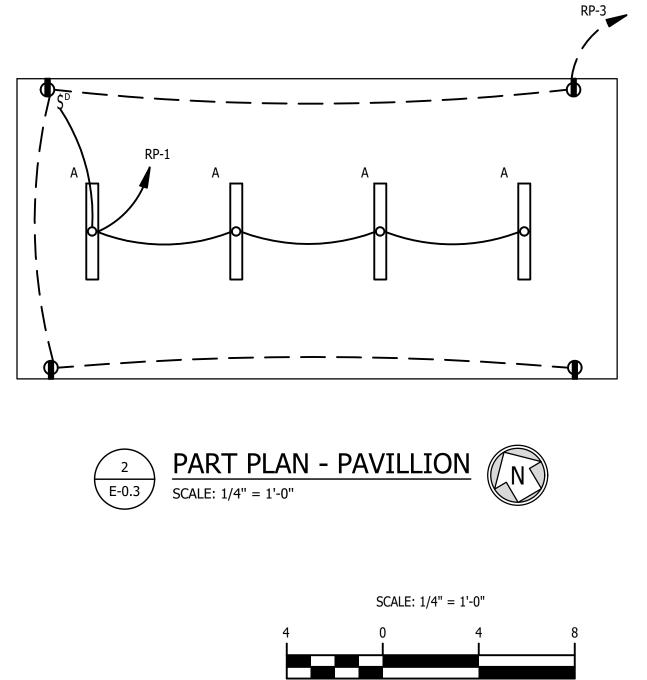

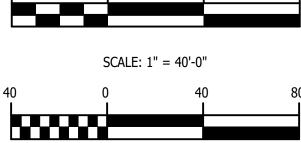BID DOCUMENTS11/08/2023

		BID DOCUMENTST1/08/2023						
	ANNE ARUND							
DEPARTMENT OF PUBLIC WORKS								
DATE	APPROVED DATE	SCALE: 1" = 1'-40"						
		DRAWN BY: J.L.P.	DEALE COMMUNITY PARK					
	PROJECT MANAGER	CHECKED BY: E.M.P.						
DATE	APPROVED DATE	SHEET NO. 46 OF 47	OVERALL SITE PLAN					
		PROJECT NO.: P582001	ELECTRICAL					
	CHIEF, RIGHT-OF-WAY	CONTRACT NO.: P582001						
	•	•	•					

